




# OJAI PERMANENT SUPPORTIVE HOUSING

DESIGN DEVELOPMENT SET | JULY 25 2025

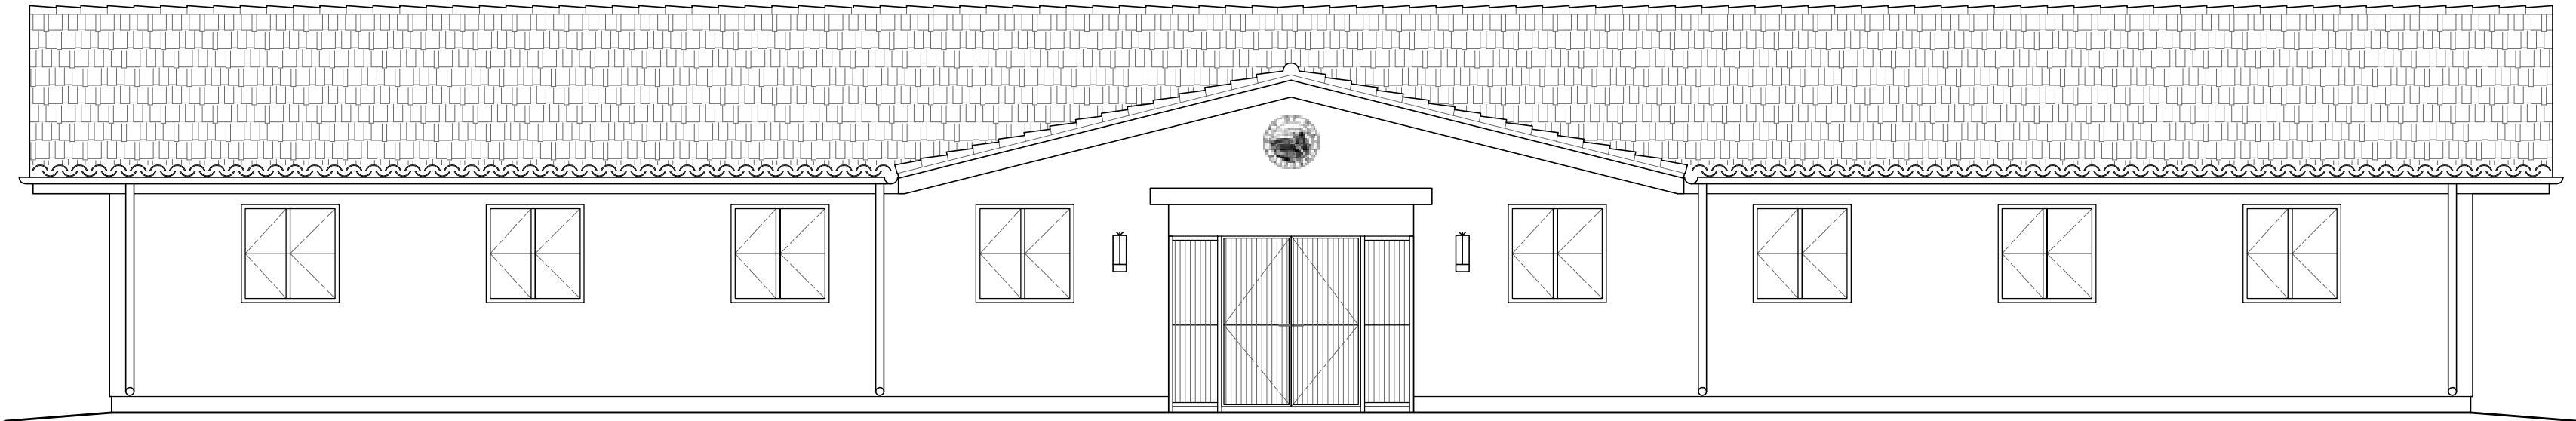

NORTH ELEVATION

<p><b>GREEN BUILDING AND BEST MANAGEMENT PRACTICES FOR CONSTRUCTION</b></p> <ol style="list-style-type: none"><li>FOR STORM WATER AND DRAINAGE CONSERVATION MEASURES AND PLANS, SEE CIVIL DRAWINGS AND 2022 CALIFORNIA GREEN BUILDING STANDARDS CODE SHEET A0.4.</li><li>FOR ENERGY EFFICIENCY STANDARDS, SEE ENERGY CALCULATIONS AND MANDATORY MEASURES ON 2022 CALIFORNIA GREEN BUILDING STANDARDS CODE SHEET A0.4.</li><li>FOR WATER CONSERVATION AND EFFICIENCY STANDARDS FOR PLUMBING FIXTURES, SEE 2022 CALIFORNIA GREEN BUILDING STANDARDS CODE SHEET A0.4.</li><li>FOR WATER CONSERVATION AND EFFICIENCY STANDARDS FOR IRRIGATION SYSTEMS, SEE 2022 CALIFORNIA GREEN BUILDING STANDARDS CODE SHEET A0.4.</li><li>FOR MATERIAL CONSERVATION, REUSE RECYCLE AND RESOURCE EFFICIENCY, SEE 2022 CALIFORNIA GREEN BUILDING STANDARDS CODE SHEET A0.4.</li><li>PROVIDE OPERATION AND MAINTENANCE MANUALS TO OWNER, AS PER 2022 CALIFORNIA GREEN BUILDING STANDARDS CODE SHEET A0.5.</li><li>FOR STANDARDS FOR AIR QUALITY, POLLUTION REDUCTION AND CONTAMINANT REDUCTION, SEE ENVIRONMENTAL QUALITY SECTION IN 2022 CALIFORNIA GREEN BUILDING STANDARDS CODE SHEET A0.4 AND A0.5.</li><li>FOR INTERIOR MOISTURE CONTROL AND INDOOR AIR QUALITY, SEE 2022 CALIFORNIA GREEN BUILDING STANDARDS CODE SHEET A0.5.</li><li>FOR INSTALLER AND SPECIAL INSPECTOR QUALIFICATIONS, SEE 2022 CALIFORNIA GREEN BUILDING STANDARDS CODE SHEET A0.5.</li><li>ERODED SEDIMENTS AND OTHER POLLUTANTS MUST BE RETAINED ON SITE AND MAY NOT BE TRANSPORTED FROM THE SITE VIA SHEET FLOW, SWALES, AREA DRAINS, NATURAL DRAINAGE COURSES OR WIND.</li><li>STOCKPILES OF EARTH AND OTHER CONSTRUCTION RELATED MATERIALS MUST BE PROTECTED FROM BEING TRANSPORTED FROM THE SITE BY THE FORCES OF WIND OR WATER.</li><li>FUELS, OILS, SOLVENTS AND OTHER TOXIC MATERIALS MUST BE STORED IN ACCORDANCE WITH THEIR LISTING AND ARE NOT TO CONTAMINATE THE SOIL AND SURFACE WATERS. ALL APPROVED STORAGE CONTAINERS ARE TO BE PROTECTED FROM THE WEATHER. SPILLS MAY NOT BE WASHED INTO DRAINAGE SYSTEM.</li><li>EXCESS OR WASTE CONCRETE MAY NOT BE WASHED INTO PUBLIC WAY OR ANY OTHER DRAINAGE SYSTEM. PROVISIONS MUST BE MADE TO RETAIN CONCRETE WASTES ON SITE UNTIL THEY CAN BE DISPOSED AS A SOLID WASTE.</li><li>TRASH AND CONSTRUCTION RELATED SOLID WASTE MUST BE DEPOSITED INTO A COVERED RECEPTACLE TO PREVENT CONTAMINATION OF RAINWATER AND DISPERSAL BY WIND.</li></ol>	<p><b>GREEN BUILDING AND BEST MANAGEMENT PRACTICES FOR CONSTRUCTION (CONT.)</b></p> <ol style="list-style-type: none"><li>SEDIMENTS AND OTHER MATERIAL MAY NOT BE TRACKED FROM THE SITE BY VEHICLE TRAFFIC. THE CONSTRUCTION ENTRANCE ROADWAYS MUST BE STABILIZED SO AS TO INHIBIT SEDIMENTS FROM BEING DEPOSITED INTO THE E PUBLIC WAY. ACCIDENTAL DEPOSITION MUST BE SWEEPED UP IMMEDIATELY AND MAY NOT BE WASHED DOWN BY RAIN OR OTHER MEANS.</li><li>ANY SLOPES WITH DISTURBED SOILS OR DEPLETED OF VEGETATION MUST BE STABILIZED SO AS TO INHIBIT EROSION BY WIND AND WATER.</li></ol>	<p><b>GENERAL NOTES</b></p> <ol style="list-style-type: none"><li>DESIGN DEVELOPMENT DRAWINGS ARE INTENDED FOR RFP PRICING AND NOT FOR CONSTRUCTION. FOLLOWING CONTRACTOR SELECTION PROCESS, DRAWINGS AND SPECIFICATIONS WILL BE PREPARED FOR PERMITTING AND CONSTRUCTION.</li><li>SEE ARCHITECTURAL OUTLINE SPECIFICATIONS FOR ADDITIONAL INFORMATION.</li></ol>	 <p><b>LOCATION MAP</b></p>  <p><b>VICINITY MAP</b></p>	<p><b>PROJECT DATA</b></p> <p>PROJECT: OJAI PERMANENT SUPPORTIVE HOUSING 611 SOUTH MONTGOMERY STREET, OJAI, CA., 93023</p> <p>APN: 023-0-120-020</p> <p>LOT SIZE: 1.74 ACRES = 75,794 SF</p> <p>CONSTRUCTION TYPE: V-B</p> <p>ZONING AND LAND USE: REFER TO CITY COUNCIL RESOLUTION 25-19</p> <p>OCCUPANCY: B, A, R-2</p> <p>S.O.A.R.: NO</p> <p>COASTAL ZONE: NO</p> <p>FLOOD ZONE: NO</p> <p>HIGH FIRE ZONE: YES - VERY HIGH FIRE HAZARD SEVERITY ZONE</p> <p>PARKING: REQUIRED COVERED PARKING = 0 REQUIRED UNCOVERED PARKING = 0 PARKING PROVIDED = 8 PROJECT AUTHORIZED UNDER CITY COUNCIL RESOLUTION 25-19</p>	<p><b>CONTACT LIST</b></p> <p><b>OWNER APPLICANT:</b> CITY OF OJAI</p> <p>BEN HARVEY CITY MANAGER BEN.HARVEY@OJAI.CA.GOV</p> <p>LUCAS SEIBERT COMMUNITY DEVELOPMENT DIRECTOR LUCAS.SEIBERT@OJAI.CA.GOV 805.646.5581</p> <p>DEVELOPER: DIGNITY MOVES MAUREEN BOYER VP OF INNOVATION DESIGN MAUREEN@DIGNITYMOVES.ORG 415.459.3510</p> <p>ARCHITECT: DJA ARCHITECTS, PLLC DYLAN JOHNSON, AIA DYLAN@DJAARCHITECTS.COM 206.459.7027</p> <p>CIVIL: JENSEN CIVIL SUSANNE COOPER, PE CAITLIN BUCH CBUCH@JDSCIVIL.COM 805.633.2225</p> <p>LANDSCAPE: STUDIO LANDSCAPE CORP. KATHY NOLAN, ASLA 805.646.8384 KN@STUDIO-LANDSCAPE.COM</p> <p>STRUCTURAL: SWENSON SAY FAGET ZANE KANYER 206.956.3736 ZKANYER@SSFENGINEERS.COM</p> <p>MECHANICAL: MECHANICAL ENGINEERING CONSULTANTS TOM HUGHES TOM@MECENG.COM</p> <p>PLUMBING: MECHANICAL ENGINEERING CONSULTANTS SCOTT BAER SCOTT@MECENG.COM</p> <p><b>ELECTRICAL:</b> JMPE JOHN MALONEY MALONEY@JMPE.NET</p>	<p><b>SHEET INDEX</b></p> <p>T1 TITLE SHEET</p> <p><b>CIVIL:</b></p> <ol style="list-style-type: none"><li>GRADING PLAN COVER SHEET</li><li>GRADING</li><li>GRADING</li><li>GRADING</li><li>GRADING</li><li>COMPOSITE UTILITY PLAN</li><li>HORIZONTAL CONTROL PLAN</li><li>EROSION CONTROL PLAN COVER SHEET</li><li>EROSION CONTROL PLAN</li></ol> <p><b>LANDSCAPE:</b></p> <ol style="list-style-type: none"><li>TITLE SHEET</li><li>EXISTING CONDITIONS PLAN</li><li>LANDSCAPE SITE PLAN</li><li>LANDSCAPE SITE PLAN</li><li>PLANTING DETAILS</li><li>IRRIGATION CONCEPT PLAN</li><li>IRRIGATION DETAILS</li><li>IRRIGATION DETAILS</li><li>LANDSCAPE MATERIALS &amp; IMAGERY</li><li>LANDSCAPE LIGHTING PLAN</li><li>LANDSCAPE LIGHTING PLAN</li><li>LIGHTING SPEC. SHEETS</li><li>TREE PROTECTION PLAN</li><li>TREE PROTECTION PLAN</li></ol> <p><b>ARCHITECTURAL:</b></p> <ol style="list-style-type: none"><li>ABBREVIATIONS, NOTES LEGENDS</li><li>LIFE SAFETY PLAN</li><li>NOT USED</li><li>CAL GREEN CODE NOTES</li><li>CAL GREEN CODE NOTES</li><li>ARCHITECTURAL SITE PLAN</li><li>FLOOR PLAN</li><li>FURNITURE PLAN</li><li>ROOF PLAN</li><li>ENLARGED SGLE UNIT PLAN &amp; INT ELEVS</li><li>ENLARGED DBLE UNIT PLAN &amp; INT ELEVS</li><li>ENLARGED RESTROOM PLANS &amp; INT ELEVS</li><li>STORAGE BUILDING</li><li>TRASH ENCLOSURE</li><li>DOOR SCHEDULE &amp; TYPES</li><li>WINDOW SCHEDULE &amp; TYPES</li><li>SCHEDULES</li><li>ASSEMBLY KEYNOTE LEGEND</li><li>EXTERIOR ELEVATIONS</li><li>EXTERIOR ELEVATIONS</li><li>BUILDING SECTIONS</li><li>WALL SECTIONS</li><li>WALL SECTIONS</li><li>NOT USED</li><li>INTERIOR ELEVATIONS</li><li>REFLECTED CEILING PLAN</li><li>REFLECTED CEILING PLANS UNITS</li><li>NOT USED</li><li>EXTERIOR DETAILS</li><li>EXTERIOR DETAILS</li><li>INTERIOR DETAILS</li></ol>	<p><b>SHEET INDEX (CONT.)</b></p> <p><b>STRUCTURAL:</b></p> <ol style="list-style-type: none"><li>GENERAL STRUCTURAL NOTES</li><li>GENERAL STRUCTURAL NOTES</li><li>FOUNDATION PLAN</li><li>FOUNDATION PLAN - STRONGWALL</li><li>ROOF FRAMING PLAN</li><li>ROOF FRAMING PLAN - STRONGWALL</li><li>FOUNDATION DETAILS</li><li>FOUNDATION DETAILS</li><li>WOOD FRAMING DETAILS</li><li>WOOD FRAMING DETAILS</li></ol> <p><b>MECHANICAL:</b></p> <ol style="list-style-type: none"><li>ABBREVIATIONS, SYMBOLS &amp; GEN. NOTES</li><li>EQUIP. SCHEDULES &amp; COMPLIANCE NOTES</li><li>EQUIPMENT SCHEDULES &amp; DETAILS</li><li>OVERALL MECHANICAL FLOOR PLAN</li><li>ENLARGED MECHANICAL FLOOR PLAN</li><li>ENLARGED MECHANICAL FLOOR PLAN</li><li>ENLARGED MECHANICAL FLOOR PLANS</li></ol> <p><b>PLUMBING:</b></p> <ol style="list-style-type: none"><li>ABBREVIATIONS, SYMBOLS, &amp; SCHEDULES</li><li>SPECIFICATIONS &amp; DETAILS</li><li>OVERALL PLUMBING FLOOR PLAN</li><li>ENLARGED PLUMBING FLOOR PLAN</li><li>ENLARGED PLUMBING FLOOR PLAN</li><li>ENLARGED PLUMBING FLOOR PLANS</li><li>ENLARGED PLUMBING FLOOR PLANS</li></ol> <p><b>ELECTRICAL:</b></p> <ol style="list-style-type: none"><li>SYMBOLS, NOTES, &amp; SINGLE LINE DIAGRAM</li><li>ELECTRICAL SITE PLAN</li><li>ELECTRICAL FLOOR PLAN</li><li>ELECTRICAL FLOOR PLANS</li></ol>																															
<p><b>BUILDING CODES</b></p> <p>THIS PROJECT SHALL COMPLY WITH THE FOLLOWING CODES AND STANDARDS:</p> <p>2022 CBC EDITION CALIF. BUILDING CODE 2022 CEC EDITION CALIF. ELECTRICAL CODE 2022 CEC EDITION CALIF. BUILDING ENERGY CODE 2022 CFC EDITION CALIF. FIRE CODE 2022 CGB EDITION CALIF. GREEN BUILDING CODE 2022 CMC EDITION CALIF. MECHANICAL CODE 2022 CPC EDITION CALIF. PLUMBING CODE</p> <p>WUI STANDARDS - CBC CH 7A, CFC CH 47</p> <p>24 CFR § 982.605 - SRO: HOUSING QUALITY STANDARDS</p>	<p><b>SPECIAL INSPECTIONS</b></p> <p>REFER TO STRUCTURAL GENERAL NOTES FOR LIST OF SPECIAL INSPECTIONS REQUIRED.</p>	<p><b>FIRE SPRINKLERS AND ALARMS</b></p> <p>BUILDING TO BE FULLY SPRINKLERED AND ALARMED. FIRE SPRINKLERS AND ALARM SYSTEM TO BE PROVIDED AS DESIGN BUILD UNDER DEFERRED SUBMITTAL.</p>	<p><b>AREA TABULATIONS</b></p> <table><tr><td>PSH Building</td><td></td></tr><tr><td>Gross Areas</td><td></td></tr><tr><td>East Wing</td><td>4,040</td></tr><tr><td>West Wing</td><td>4,040</td></tr><tr><td>South Wing</td><td>2,206</td></tr><tr><td>Gross Building Area</td><td>10,286</td></tr><tr><td></td><td></td></tr><tr><td>Courtyard</td><td>5,667</td></tr><tr><td>Outdoor Corridors</td><td>603</td></tr><tr><td>Outdoor Spaces</td><td>6,270</td></tr><tr><td>Total Footprint</td><td>16,556</td></tr><tr><td>Roof Area</td><td>14,702</td></tr><tr><td></td><td></td></tr><tr><td>Storage Building</td><td></td></tr><tr><td>Net Interior Area</td><td>920</td></tr><tr><td>Gross Footprint</td><td>1,037</td></tr><tr><td>Roof Area</td><td>1,559</td></tr></table>	PSH Building		Gross Areas		East Wing	4,040	West Wing	4,040	South Wing	2,206	Gross Building Area	10,286			Courtyard	5,667	Outdoor Corridors	603	Outdoor Spaces	6,270	Total Footprint	16,556	Roof Area	14,702			Storage Building		Net Interior Area	920	Gross Footprint	1,037	Roof Area	1,559	<p><b>PROJECT DESCRIPTION</b></p> <p>THE CITY OF OJAI WILL CONSTRUCT, ON CITY OWNED PROPERTY AT 611 SOUTH MONTGOMERY STREET, A PERMANENT SUPPORTIVE HOUSING PROJECT FOR FORMERLY UNHOUSED INDIVIDUALS CONTAINING THIRTY (30) SINGLE-STORY RESIDENTIAL UNITS EACH WITH ENSUITE BATHROOMS, A COMMON AREA, LAUNDRY AND GATHERING FACILITIES, AND OFFICES FOR SITE MANAGERS, ON-SITE CASE MANAGERS AND SITE SECURITY, AN ACCESSORY STORAGE BUILDING, TRASH ENCLOSURE AND ASSOCIATED SITE, CIVIL AND LANDSCAPE DEVELOPMENTS (TOGETHER WITH ALL RELATED FACILITIES, THE "PROJECT"). COOKING SHALL NOT OCCUR AT THE PROJECT. OWNER SHALL RETAIN OPERATOR THAT WILL PROVIDE MINIMUM OF THREE MEALS PER DAY, PREPARED OFF SITE AND DELIVERED.</p>
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GENERAL GRADING NOTES:

1. GRADING ACTIVITIES SHALL BE IN ACCORDANCE WITH THE VENTURA COUNTY BUILDING CODE APPENDIX J GRADING, LATEST EDITION.
2. THE GRADING PERMIT AND WORK SHOWN IN THESE PLANS IS VALID ONLY TO THE EXTENT OF THE VENTURA COUNTY BUILDING CODE APPENDIX J - GRADING. PERMITS OR PERMISSIONS THAT MAY BE REQUIRED BY OTHER REGULATORY AGENCIES OR INTERESTED PARTIES ARE THE RESPONSIBILITY OF THE PERMITTEE.
3. A PRECONSTRUCTION MEETING SHALL BE HELD AT THE SITE PRIOR TO ANY GRADING ACTIVITY OR LAND DISTURBANCES WITH THE FOLLOWING PARTIES PRESENT: OWNER, GRADING CONTRACTOR, DESIGN CIVIL ENGINEER, SOILS ENGINEER, CITY GRADING INSPECTOR(S), AND OTHER JURISDICTIONAL AGENCIES WHEN REQUIRED.
4. HEAVY EQUIPMENT NOISE & TRUCK DELIVERIES SHALL NOT BEGIN UNTIL AFTER 7:00 A.M. NO WORK BEYOND 4:30 PM UNLESS APPROVED BY PWA.
5. NO GRADING ACTIVITY SHALL OCCUR IN ANY WETLAND, BLUE-LINE STREAM, RED-LINE CHANNEL, OR FLOODPLAIN WITHOUT THE PROPER PERMITS & PERMISSION FROM THE PWA & RESOURCE MANAGEMENT AGENCY (RMA), OR OTHER AUTHORITIES HAVING JURISDICTION.
6. RETAINING WALLS AND BRIDGES REQUIRE A SEPARATE PERMIT FROM BUILDING AND SAFETY.
7. ALL RECOMMENDATIONS MADE BY THE SOILS ENGINEER (AND ENGINEERING GEOLOGIST, WHERE EMPLOYED) CONTAINED IN THE REPORTS AS APPROVED BY THE CITY SHALL BE A PART OF THIS GRADING PLAN.
8. ALL DISTURBED SURFACES SUBJECT TO EROSION SHALL BE PROTECTED IN ACCORDANCE WITH THE VENTURA COUNTYWIDE MUNICIPAL STORMWATER NPDES PERMIT. SEDIMENT AND EROSION CONTROL MEASURES SHALL BE INSTALLED AND MAINTAINED FULLY FUNCTIONAL.
9. ALL UNSUITABLE MATERIAL, I.E. LUMBER, LOGS, BRUSH, COMPRESSIBLE SOILS, OR ANY ORGANIC MATERIALS OR RUBBISH, SHALL BE REMOVED AS REQUIRED BY THE SOILS ENGINEER AND ENGINEERING GEOLOGIST FROM ALL AREAS TO RECEIVE FILL.
10. ALL AREAS TO RECEIVE FILL SHALL BE INSPECTED AND APPROVED BY THE SOILS ENGINEER (AND ENGINEERING GEOLOGIST WHERE EMPLOYED) AFTER REMOVAL OF UNSUITABLE MATERIAL AND EXCAVATION OF KEYWAYS AND BENCHES, AND PRIOR TO PLACEMENT OF SUBSURFACE DRAINAGE SYSTEMS OR FILL.
11. ALL MATERIALS DEEMED UNSUITABLE FOR PLACEMENT IN COMPACTED FILL SHALL BE REMOVED FROM THE SITE. MATERIALS SUCH AS CONSTRUCTION INERT DEBRIS, OR IMPORTED MATERIALS SHALL BE APPROVED BY THE SOILS ENGINEER AND CITY PRIOR TO USE IN COMPACTED FILL. WHERE EXCAVATED MATERIAL IS LARGER THAN TWELVE INCHES IN LARGEST DIMENSION, IT MUST BE BROKEN INTO SMALLER PARTICLE SIZES, BEFORE BEING USED AS FILL.
12. THE SOILS ENGINEER SHALL DIRECT THE REMOVAL OF ANY EXISTING UNDERGROUND STRUCTURES SUCH AS SEPTIC TANKS, IRRIGATION LINES, ETC.
13. ANY WATER WELL LOCATED WITHIN THE AREA OF DISTURBANCE SHALL BE REPORTED TO THE WATER RESOURCES DIVISION, WATERSHED PROTECTION DISTRICT PRIOR TO ITS MODIFICATION, ABANDONMENT, OR DESTRUCTION.
14. ANY OIL WELL LOCATED WITHIN THE AREA OF DISTURBANCE SHALL BE REPORTED TO THE STATE OF CALIFORNIA, DIVISION OF OIL, GAS, AND GEOTHERMAL RESOURCES PRIOR TO ITS MODIFICATION, ABANDONMENT, OR DESTRUCTION.
15. ALL TEMPORARY EXCAVATED SLOPES OR BENCHES AND KEYS FOR BUTTRESS OR STABILIZATION FILLS MUST BE EXAMINED BY THE ENGINEERING GEOLOGIST AND SOILS ENGINEER TO INSURE THAT ALL POTENTIAL PLANES OF FAILURE HAVE BEEN EXPOSED IN THE EXCAVATION AND WILL BE ADEQUATELY SUPPORTED BY THE PROPOSED BUTTRESS. FIELD CERTIFICATION MUST BE SUBMITTED BY THE CONSULTANTS PRIOR TO PLACING FILL.
16. THE SOILS ENGINEER AND ENGINEERING GEOLOGIST (WHERE EMPLOYED) SHALL PROVIDE RECOMMENDATIONS AND APPROVE CORRECTIVE WORK TO INSURE SLOPE STABILITY WHERE UNSTABLE MATERIAL IS EXPOSED AT THE TOP OF CUTS AND EXCAVATIONS.
17. THE USE OF CORRUGATED STEEL PIPE IS NOT ALLOWED IN ANY COUNTY RIGHTS OF WAY. THE USE OF CORRUGATED STEEL PIPE ON PRIVATE PROPERTY SHOULD BE MINIMIZED. HOWEVER, IF USED SHOULD BE COATED TO MINIMIZE CORROSION AND TO EXTEND SERVICE TIME.
18. INTERIM SOILS AND GEOLOGIC REPORTS SHALL BE SUBMITTED TO THE COUNTY AS REQUIRED BY THE BUILDING OFFICIAL.
19. ROUGH GRADE SOILS ENGINEERING AND (IF APPLICABLE) ENGINEERING GEOLOGY REPORTS SUMMARIZING ALL EARTHWORK PERFORMED AND CONCLUDING THAT THE WORK HAS BEEN COMPLETED ACCORDING TO THE APPROVED REPORTS SHALL BE SUBMITTED TO THE CITY FOR APPROVAL OF THE ROUGH GRADING BY THE BUILDING OFFICIAL PRIOR TO CALLING FOR BUILDING AND SAFETY INSPECTION.
20. FINAL SOILS ENGINEERING AND (IF APPLICABLE) ENGINEERING GEOLOGY REPORTS SUMMARIZING ALL EARTHWORK PERFORMED SINCE ROUGH GRADING AND CONCLUDING THAT THE WORK HAS BEEN COMPLETED ACCORDING TO THE APPROVED REPORTS SHALL BE SUBMITTED WITH THE AS-BUILT PLANS (RECORD DRAWING) TO THE CITY PRIOR TO FINAL INSPECTION BY THE BUILDING OFFICIAL.
21. PROJECT TO BE BID IN ACCORDANCE WITH CALIFORNIA PUBLIC CONTRACT CODE SECTION 22030-22045 AND OJAI MUNICIPAL CODE CHAPTER 8-4.

EARTHWORK QUANTITIES

CUT: XXXX CU. YDS. EXPORT: XXXX CU. YDS. DISPOSAL SITE XXXX

FILL: XXXX CU. YDS. IMPORT: XXXX CU. YDS. SOURCE XXXX

THIS PROJECT INCLUDES POST CONSTRUCTION BMP'S YES XXXX

THE TOTAL ESTIMATED DISTURBED AREA OF GRADING AND CONSTRUCTION IS XXXX ACRES.

AVERAGE NATURAL SLOPE IN THE AREA OF GRADING XXXX %

THE TOTAL AMOUNT OF IMPERVIOUS AREA TO BE CONSTRUCTED AS PART OF THIS PROJECT IS XXXX SQ. FT.

TOTAL PROPOSED LANDSCAPED AREA XXXX SQ. FT. TOTAL NATIVE PLANTING LANDSCAPE AREA XXXX % (PERCENT OF TOTAL LANDSCAPE AREA)

LAND DEVELOPMENT & INSPECTION SERVICES MUST BE NOTIFIED TEN (10) WORKING DAYS PRIOR TO ANY EXPORT/IMPORT TO/FROM THE PROJECT SITE.

PERMITS

CITY ENCROACHMENT PERMIT NO. VENTURA COUNTY WATERSHED PROTECTION DISTRICT WATERCOURSE PERMIT NO. DATE DATE

STATE ENCROACHMENT PERMIT NO. FLOODPLAIN DEVELOPMENT PERMIT DATE DATE

ENGINEERED GRADING INSPECTION CERTIFICATES

JOB ADDRESS OR LOT AND TRACT NO: \_\_\_\_\_

ROUGH GRADING CERTIFICATION

(A) BY SOILS ENGINEER

I CERTIFY THAT THE ROUGH GRADING WORK INCORPORATES ALL RECOMMENDATIONS CONTAINED IN THE REPORT OR REPORTS FOR WHICH I AM RESPONSIBLE AND ALL RECOMMENDATIONS THAT I HAVE MADE BASED ON FIELD INSPECTION OF THE WORK AND TESTING DURING GRADING. I FURTHER CERTIFY THAT WHERE THE REPORTS OF AN ENGINEERING GEOLOGIST, RELATIVE TO THIS SITE, HAVE RECOMMENDED THE INSTALLATION OF BUTTRESS FILLS OR OTHER SIMILAR STABILIZATION MEASURES, SUCH EARTHWORK CONSTRUCTION HAS BEEN COMPLETED IN ACCORDANCE WITH THE APPROVED DESIGN.

LOT NOS: \_\_\_\_\_

SEE REPORTS DATED: \_\_\_\_\_

FOR TEST DATA, RECOMMENDED ALLOWABLE SOIL BEARING VALUES & OTHER SPECIAL RECOMMENDATIONS.

SOILS ENGINEER \_\_\_\_\_ REG. NO. \_\_\_\_\_ DATE \_\_\_\_\_ (SIGNATURE)

(B) BY ENGINEERING GEOLOGIST

I CERTIFY THAT THE ROUGH GRADING WORK INCORPORATES ALL OF THE RECOMMENDATIONS CONTAINED IN THE REPORT OR REPORTS FOR WHICH I AM RESPONSIBLE AND ALL RECOMMENDATIONS THAT I HAVE MADE BASED ON FIELD INSPECTION OF THE WORK DURING GRADING.

LOT NOS: \_\_\_\_\_

ENGINEERING GEOLOGIST \_\_\_\_\_ CERT. NO. \_\_\_\_\_ DATE \_\_\_\_\_ (SIGNATURE)

(C) BY CIVIL ENGINEER

I CERTIFY TO THE SATISFACTORY COMPLETION OF ROUGH GRADING INCLUDING GRADING TO APPROXIMATE FINAL ELEVATIONS, PROPERTY LINES LOCATED AND STAKED, CUT AND FILL SLOPES CORRECTLY GRADED AND LOCATED IN ACCORDANCE WITH THE APPROVED DESIGN, SWALES AND TERRACES GRADED READY FOR PAVING, BERMS INSTALLED, AND REQUIRED DRAINAGE SLOPES PROVIDED ON THE BUILDING PADS. I FURTHER CERTIFY THAT WHERE REPORT OR REPORTS OF AN ENGINEERING GEOLOGIST AND/OR SOILS ENGINEER HAVE BEEN PREPARED RELATIVE TO THIS SITE, THE RECOMMENDATIONS CONTAINED IN SUCH REPORTS HAVE BEEN INCORPORATED IN THE DESIGN.

LOT NOS: \_\_\_\_\_

CIVIL ENGINEER \_\_\_\_\_ REG. NO. \_\_\_\_\_ DATE \_\_\_\_\_ (SIGNATURE)

FINAL GRADING CERTIFICATION

BY CIVIL ENGINEER

I CERTIFY TO THE SATISFACTORY COMPLETION OF GRADING IN ACCORDANCE WITH THE APPROVED PLANS. ALL DRAINAGE DEVICES REQUIRED BY THE GRADING PERMIT, GRADING PLANS AND GRADING ORDINANCE HAVE BEEN INSTALLED. EROSION TREATMENT OF SLOPES AND IRRIGATION SYSTEMS (WHERE REQUIRED) HAVE BEEN INSTALLED. ADEQUATE PROVISIONS HAVE BEEN MADE FOR DRAINAGE OF SURFACE WATERS FROM EACH BUILDING SITE AS OF THIS DATE.

LOT NOS: \_\_\_\_\_

CIVIL ENGINEER \_\_\_\_\_ REG. NO. \_\_\_\_\_ DATE \_\_\_\_\_ (SIGNATURE)

GRADING CONTRACTOR CERTIFICATION

BY GRADING CONTRACTOR

I CERTIFY THAT THE GRADING WAS DONE IN ACCORDANCE WITH THE PLANS AND SPECIFICATIONS, THE GRADING ORDINANCE, AND THE RECOMMENDATIONS OF THE CIVIL ENGINEER, SOILS ENGINEER AND ENGINEERING GEOLOGIST. IT IS UNDERSTOOD THAT THIS CERTIFICATION INCLUDES ONLY THOSE ASPECTS OF THE WORK THAT CAN BE DETERMINED BY ME, AS A COMPETENT GRADING CONTRACTOR, WITHOUT SPECIAL EQUIPMENT OR PROFESSIONAL SKILLS.

GRADING CONTRACTOR \_\_\_\_\_ LICENSE NO. \_\_\_\_\_ DATE \_\_\_\_\_ (SIGNATURE)

INSTRUCTIONS: THE OWNER MAY SIGN IF THE GRADING WAS NOT DONE BY A LICENSED GRADING CONTRACTOR.

CITY OF OJAI  
PUBLIC WORKS AGENCY

GENERAL STORMWATER NOTES:

THE LEGALLY RESPONSIBLE PERSON OF ANY PROPERTY IN WHICH GRADING ACTIVITIES OR OTHER SOIL DISTURBANCE ACTIVITIES ARE PERFORMED, INCLUDING PERMITTEE, SHALL COMPLY WITH THE LATEST AND APPLICABLE NPDES REQUIREMENTS. EFFECTIVE COMBINATION OF EROSION AND SEDIMENT CONTROL BEST MANAGEMENT PRACTICES (BMP'S) SHALL BE INSTALLED BEFORE GRADING BEGINS. DURING GRADING ACTIVITIES, ALL BMP'S SHALL BE UPDATED AS NECESSARY TO PREVENT EROSION AND ANY ILLICIT DISCHARGE OF CONSTRUCTION RELATED POLLUTANTS. EROSION CONTROL BMP'S ARE LISTED ON COUNTY FORMS SW-1, SW-2, OR SW-4R.

1. **GENERAL CONSTRUCTION PERMIT.** PROJECTS THAT CAUSE SOIL DISTURBANCE OF ONE ACRE OR MORE, OR THAT ARE PART OF A COMMON PLAN OF DEVELOPMENT OR SALE THAT CAUSE SOIL DISTURBANCE OF ONE ACRE OR MORE ARE REQUIRED TO OBTAIN COVERAGE UNDER NPDES CALIFORNIA STATEWIDE GENERAL CONSTRUCTION PERMIT NO. CAS000002, AS A NUMBER ASSIGNED TO THE PROJECT BY THE STATE WATER RESOURCES CONTROL BOARD, COMPLETED AND SIGNED NOTICE OF INTENT (NOI) AND PROJECT STORMWATER POLLUTION PREVENTION PLAN (SWPPP) SHALL BE SUBMITTED AND IMPLEMENTED DURING ALL GRADING ACTIVITIES.
2. **COUNTY'S STORM DRAIN SYSTEM.** ILLICIT DISCHARGES INTO THE COUNTY'S STORM DRAIN SYSTEM AS A RESULT OF GRADING, CLEARING, CONSTRUCTION, DEMOLITION, AND OTHER SOIL DISTURBANCE ACTIVITIES ARE PROHIBITED.
3. **INSPECTIONS.** EROSION CONTROL AND PERMANENT STORMWATER TREATMENT BMP'S ARE SUBJECT TO INSPECTIONS AS REQUIRED BY THE PERMIT ORDER NO. R4-2010-0108, AS AMENDED FROM TIME TO TIME.
4. **PUMPED WATER DISCHARGES.** DISCHARGES OF PUMPED GROUND WATER REQUIRE A DISCHARGE PERMIT FROM THE STATE OF CALIFORNIA REGIONAL WATER QUALITY CONTROL BOARD (RWQCB).
5. **SANITARY FACILITIES.** PORTABLE SANITARY FACILITIES SHALL BE LOCATED ON RELATIVELY LEVEL GROUND AWAY FROM TRAFFIC AREAS, DRAINAGE COURSES, AND STORM DRAIN INLETS.
6. **EMERGENCY WORK.** A STANDBY CREW FOR EMERGENCY WORK SHALL BE AVAILABLE AT ALL TIMES DURING THE RAINY SEASON (OCTOBER 1ST TO APRIL 15TH). NECESSARY MATERIALS SHALL BE AVAILABLE ON SITE AND STOCKPILED AT CONVENIENT LOCATIONS TO FACILITATE RAPID CONSTRUCTION OF EMERGENCY DEVICES WHEN RAIN IS IMMINENT.

PROJECT BMP'S

THE FOLLOWING BMP'S AS OUTLINED IN, BUT NOT LIMITED TO, THE LATEST EDITION OF THE CASQA CONSTRUCTION BMP ONLINE HANDBOOK MAY APPLY DURING THE CONSTRUCTION OF THIS PROJECT (ADDITIONAL MEASURES MAY BE REQUIRED IF DEEMED APPROPRIATE BY THE PROJECT ENGINEER, QUALIFIED SWPPP DEVELOPER, PRACTITIONER OR THE BUILDING OFFICIAL). CERTAIN BMP'S ARE REQUIRED AS PART OF THE STORMWATER FORMS SW-1, SW-2 AND SW-4R. THE APPLICANT IS RESPONSIBLE FOR ENSURING THAT THE BMP'S LISTED HEREON, ARE IMPLEMENTED AND MAINTAINED AT ALL TIMES DURING THE CONSTRUCTION. THE INSPECTOR OR BUILDING OFFICIAL MAY PERFORM UNANNOUNCED SITE INSPECTIONS TO ENSURE THAT THE PROJECT MAINTAINS THE BMP'S AS LISTED BELOW.


BMP DESCRIPTIONS AND DETAILS CAN BE OBTAINED FROM THE CALIFORNIA STORMWATER HANDBOOKS AT [WWW.CASQA.ORG](http://WWW.CASQA.ORG)

COMPLETE CHECKLIST BELOW FOR APPLICABLE PROJECT BMP'S

EROSION CONTROL	
<input checked="" type="checkbox"/>	EC1 - SCHEDULING
<input checked="" type="checkbox"/>	EC2 - PRESERVATION EXISTING VEGETATION
<input checked="" type="checkbox"/>	EC3 - HYDRAULIC MULCH
<input checked="" type="checkbox"/>	EC4 - HYDROSEEDING
<input checked="" type="checkbox"/>	EC5 - SOIL BINDERS
<input checked="" type="checkbox"/>	EC6 - STRAW MULCH
<input checked="" type="checkbox"/>	EC7 - GEOTEXTILES & MATS
<input checked="" type="checkbox"/>	EC8 - WOOD MULCHING
<input checked="" type="checkbox"/>	EC9 - EARTH DIKES & DRAINAGE SWALES
<input checked="" type="checkbox"/>	EC10 - VELOCITY DISSIPATION DEV.
<input checked="" type="checkbox"/>	EC11 - SLOPE DRAINS
<input checked="" type="checkbox"/>	EC12 - STREAMBANK STABILIZATION
<input checked="" type="checkbox"/>	EC14 - COMPOST BLANKETS
<input checked="" type="checkbox"/>	EC15 - SOIL PREPARATION/ROUGHENING
<input checked="" type="checkbox"/>	EC16 - NON-VEGETATED STABILIZATION
TEMPORARY SEDIMENT CONTROL	
<input checked="" type="checkbox"/>	SE1 - SILT FENCE
<input checked="" type="checkbox"/>	SE2 - SEDIMENT BASIN
<input checked="" type="checkbox"/>	SE3 - SEDIMENT TRAP
<input checked="" type="checkbox"/>	SE4 - CHECK DAM
<input checked="" type="checkbox"/>	SE5 - FIBER ROLLS
<input checked="" type="checkbox"/>	SE6 - GRAVEL BAG BERM
<input checked="" type="checkbox"/>	SE7 - STREET SWEEPING AND VACUUMING
<input checked="" type="checkbox"/>	SE8 - SANDBAG BARRIER
<input checked="" type="checkbox"/>	SE9 - STRAW BALE BARRIER
<input checked="" type="checkbox"/>	SE10 - STORM DRAIN INLET PROTECTION
<input checked="" type="checkbox"/>	SE11 - ACTIVE TREATMENT SYSTEMS
<input checked="" type="checkbox"/>	SE12 - TEMPORARY SILT DIKE
<input checked="" type="checkbox"/>	SE13 - COMPOST SOCKS & BERMS
<input checked="" type="checkbox"/>	SE14 - BIOFILTER BAGS

WIND EROSION CONTROL	
<input checked="" type="checkbox"/>	WE1 - WIND EROSION CONTROL
EQUIPMENT TRACKING	
<input checked="" type="checkbox"/>	TC1 - STABILIZED CONSTRUCTION ENTRANCE EXIT
<input checked="" type="checkbox"/>	TC2 - STABILIZED CONSTRUCTION ROADWAY
<input checked="" type="checkbox"/>	TC3 - ENTRANCE/OUTLET TIRE WASH
NON-STORMWATER MANAGEMENT	
<input checked="" type="checkbox"/>	NS1 - WATER CONSERVATION PRACTICES
<input checked="" type="checkbox"/>	NS2 - DEWATERING OPERATIONS
<input checked="" type="checkbox"/>	NS3 - PAVING & GRINDING OPERATIONS
<input checked="" type="checkbox"/>	NS4 - TEMPORARY STREAM CROSSING
<input checked="" type="checkbox"/>	NS5 - CLEAR WATER DIVERSION
<input checked="" type="checkbox"/>	NS6 - ILLICIT CONNECTION/DISCHARGE
<input checked="" type="checkbox"/>	NS7 - POTABLE WATER/IRRIGATION
<input checked="" type="checkbox"/>	NS8 - VEHICLE & EQUIPMENT CLEANING
<input checked="" type="checkbox"/>	NS9 - VEHICLE & EQUIPMENT FUELING
<input checked="" type="checkbox"/>	NS10 - VEHICLE & EQUIPMENT MAINTENANCE
<input checked="" type="checkbox"/>	NS11 - PILE DRIVING OPERATIONS
<input checked="" type="checkbox"/>	NS12 - CONCRETE CURING
<input checked="" type="checkbox"/>	NS13 - CONCRETE FINISHING
<input checked="" type="checkbox"/>	NS14 - MATERIAL & EQUIPMENT USE
<input checked="" type="checkbox"/>	NS15 - DEMOLITION ADJACENT TO WATER
<input checked="" type="checkbox"/>	NS16 - TEMPORARY BATCH PLANTS
WASTE MANAGEMENT & MATERIAL POLLUTION CONTROL	
<input checked="" type="checkbox"/>	WM1 - MATERIAL DELIVERY & STORAGE
<input checked="" type="checkbox"/>	WM2 - MATERIAL USE
<input checked="" type="checkbox"/>	WM3 - STOCKPILE MANAGEMENT
<input checked="" type="checkbox"/>	WM4 - SPILL PREVENTION & CONTROL
<input checked="" type="checkbox"/>	WM5 - SOLID WASTE MANAGEMENT
<input checked="" type="checkbox"/>	WM6 - HAZARDOUS WASTE MANAGEMENT
<input checked="" type="checkbox"/>	WM7 - CONTAMINATION SOIL MANAGEMENT
<input checked="" type="checkbox"/>	WM8 - CONCRETE WASTE MANAGEMENT

TOP AND BOTTOM OF SLOPE SETBACK CRITERIA \*

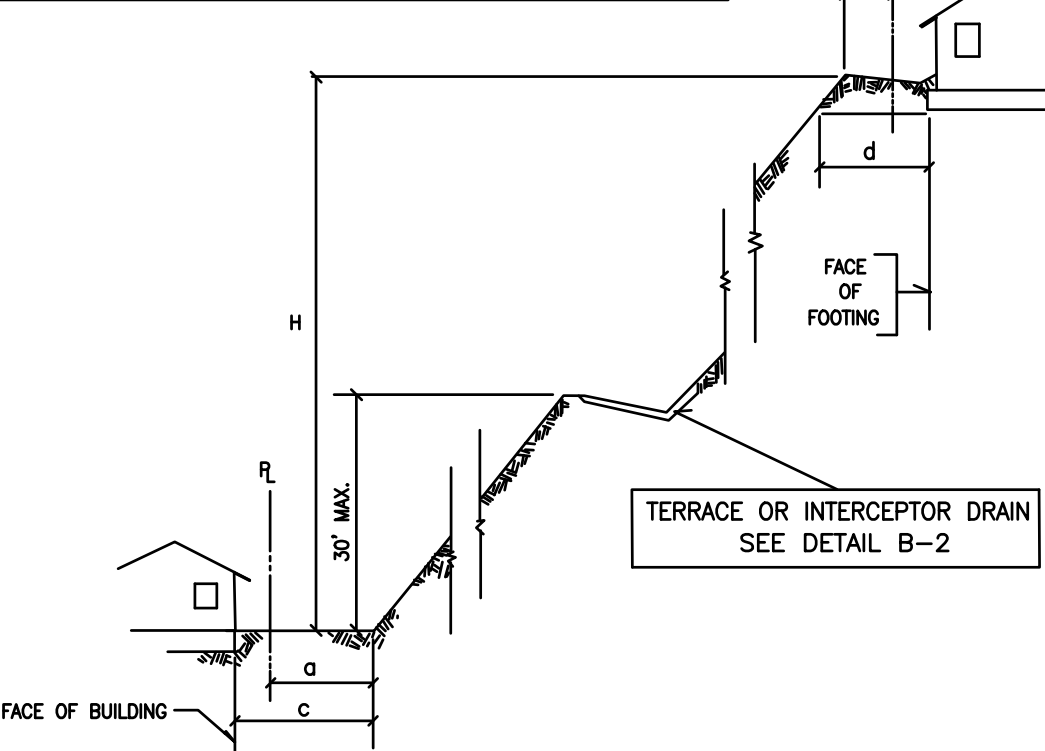


H (IN FEET)	a	b	c	d
ANY HEIGHT	2' MIN (H/2)' 20' MAX	2' MIN (H/5)' 10' MAX	(H/2)' 15' MAX	(H/3)' 40' MAX

\* FROM C B C SEC. 1808.7 AND APPENDIX J - SEC. J109 R (SITE BOUNDARY)

DETAIL A  
NTS

FILL PLACEMENT AND DRAINAGE DETAILS

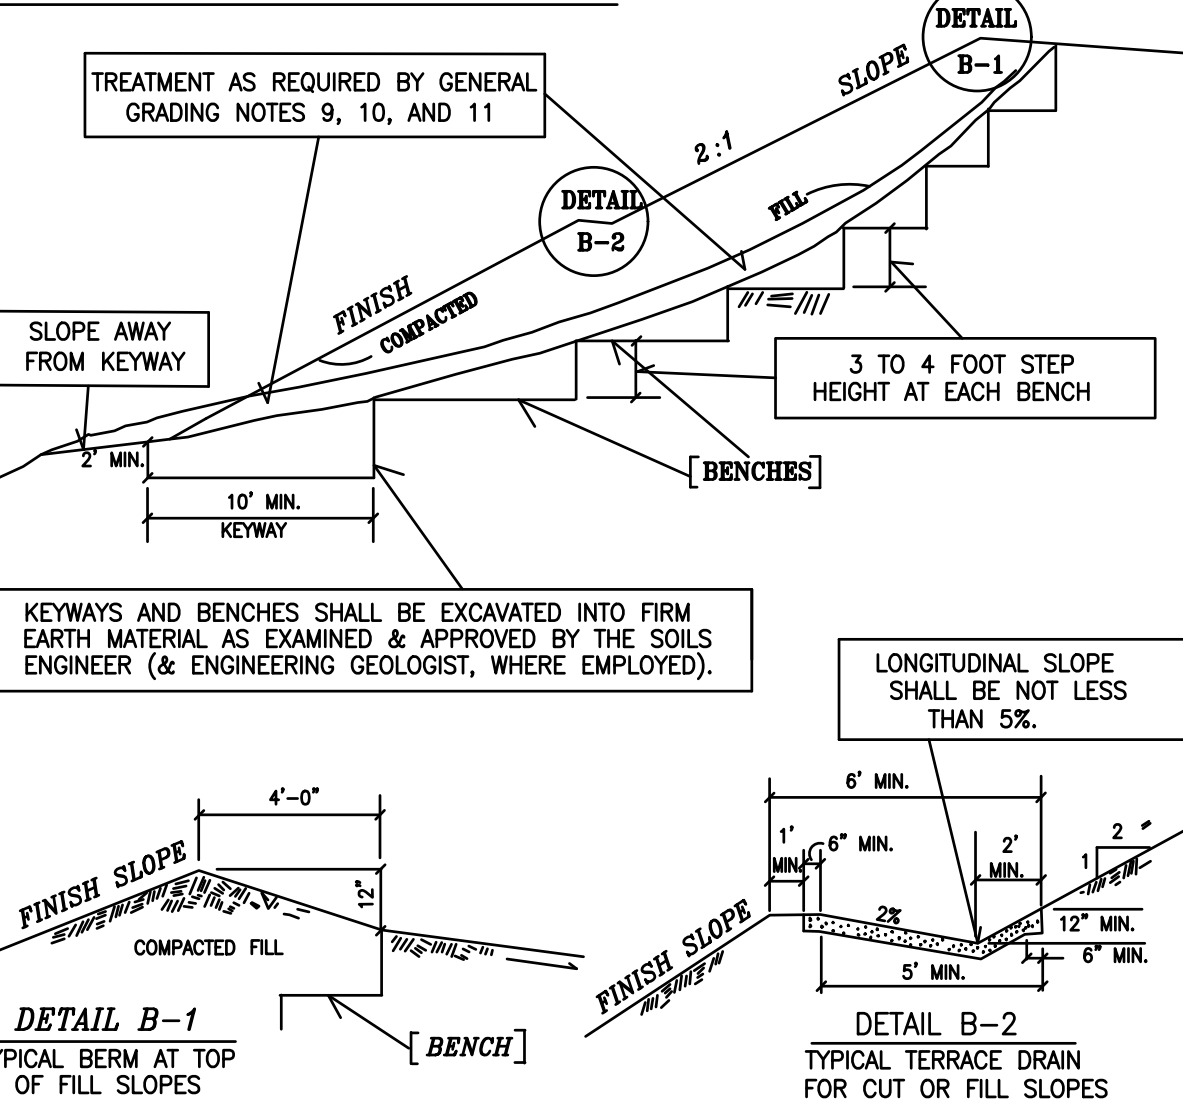


- 1) TERRACE DRAINS, INTERCEPTOR DRAINS & DOWNDRAINS SHALL BE CONSTRUCTED OF MINIMUM 3" REINFORCED CONCRETE REINFORCED WITH 6 x 6 x 10 x 10 W.W.M. & SHALL BE OF EITHER SEMI-CIRCULAR OR TRIANGULAR CROSS SECTION.
- 2) FOR INTERCEPTOR DRAIN AT TOP OF CUT SLOPES AND DOWN DRAINS, MINIMUM WIDTH OF 3 FEET.

DETAIL B  
NTS

Design Development  
NOT FOR CONSTRUCTION  
25 July 2025

WDID: \_\_\_\_\_ APN: 023-0-120-020 GP GP NO

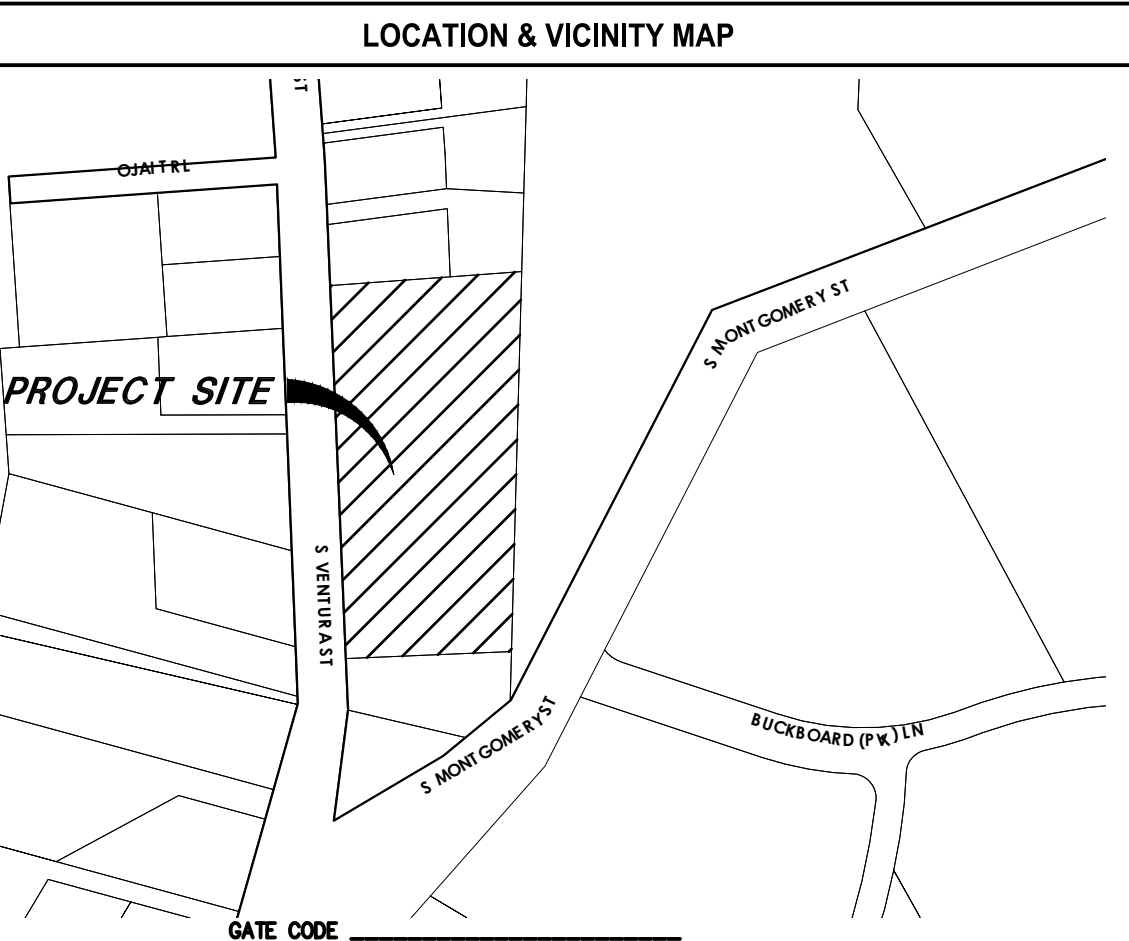

APPROVAL BY CONSULTANTS

THIS GRADING PLAN IS ACCEPTABLE IN REGARD TO SOILS (AND GEOLOGIC - IF APPLICABLE) CONDITIONS AND CONFORMS TO THE RECOMMENDATION OF THE SUPPORTIVE REPORT(S) DATED: \_\_\_\_\_

SOILS ENGINEERING REPORTS: \_\_\_\_\_ 20 \_\_\_\_\_

(SOILS ENGINEER SIGNATURE) \_\_\_\_\_ 123 EASY WAY VENTURA, CA 93003 (805) 555-5555 GEO@AOL.COM

(PRINT NAME) \_\_\_\_\_ (RCE NO.) \_\_\_\_\_

ENGINEERING GEOLOGY REPORTS: \_\_\_\_\_ 20 \_\_\_\_\_

(ENGINEERING GEOLOGIST SIGNATURE) \_\_\_\_\_ 123 EASY WAY VENTURA, CA 93003 (805) 555-5555 GEO@AOL.COM

(PRINT NAME) \_\_\_\_\_ CERT. NO. \_\_\_\_\_

(CIVIL ENGINEER SIGNATURE) \_\_\_\_\_ 1672 DONLON STREET, VENTURA, CA 93003 (805) 654-6977 INFO.VENTURA1@SANBELL.COM

(PRINT NAME) \_\_\_\_\_ (RCE NO.) \_\_\_\_\_

OWNER/APPLICANT

OJAI DIGNITY MOVES  
123 EASY WAY VENTURA, CA 93003

BENCH MARK DATA

VENTURA COUNTY VCPID 982

BRASS DISK STAMPED "49-21 RM-1 1986" SET ON THE SOUTHEAST CORNER OF A CONCRETE CATCH BASIN LOCATED ON THE NORTHERLY SIDE OF MONTGOMERY STREET, APPROXIMATELY 1,300 FEET SOUTHERLY ALONG MONTGOMERY STREET FROM ITS INTERSECTION WITH OJAI AVENUE (STATE HIGHWAY 150), IN THE CITY OF OJAI, VENTURA COUNTY, CA.

ELEVATION: 711.74 FEET (NAVD 88)

TOPOGRAPHY DATA

TOPOGRAPHIC SURVEY CONDUCTED USING CONVENTIONAL METHODS ON SEPTEMBER 17, 2024, BY JEREMY HENRY, PLS 8135. SURVEY DATA IS REFERENCED TO NAD 83, CALIFORNIA ZONE 5, US SURVEY FOOT, AND NAVD 88 VERTICAL DATUM. CONTOUR INTERVALS ARE SHOWN AT 1-FOOT INTERVALS.



DESIGNED \_\_\_\_\_ DRAWN \_\_\_\_\_

APPROVED: CITY OF OJAI

DATE: \_\_\_\_\_

BY: \_\_\_\_\_

MANAGER, DEVELOPMENT & INSPECTION SERVICES

CITY OF OJAI  
PUBLIC WORKS AGENCY


GRADING PLAN COVERSHEET

OJAI DIGNITY MOVES  
611 SOUTH MONTGOMERY STREET  
OJAI, CA

SHEET 1 OF 8

DRAWING NO. DWS NO



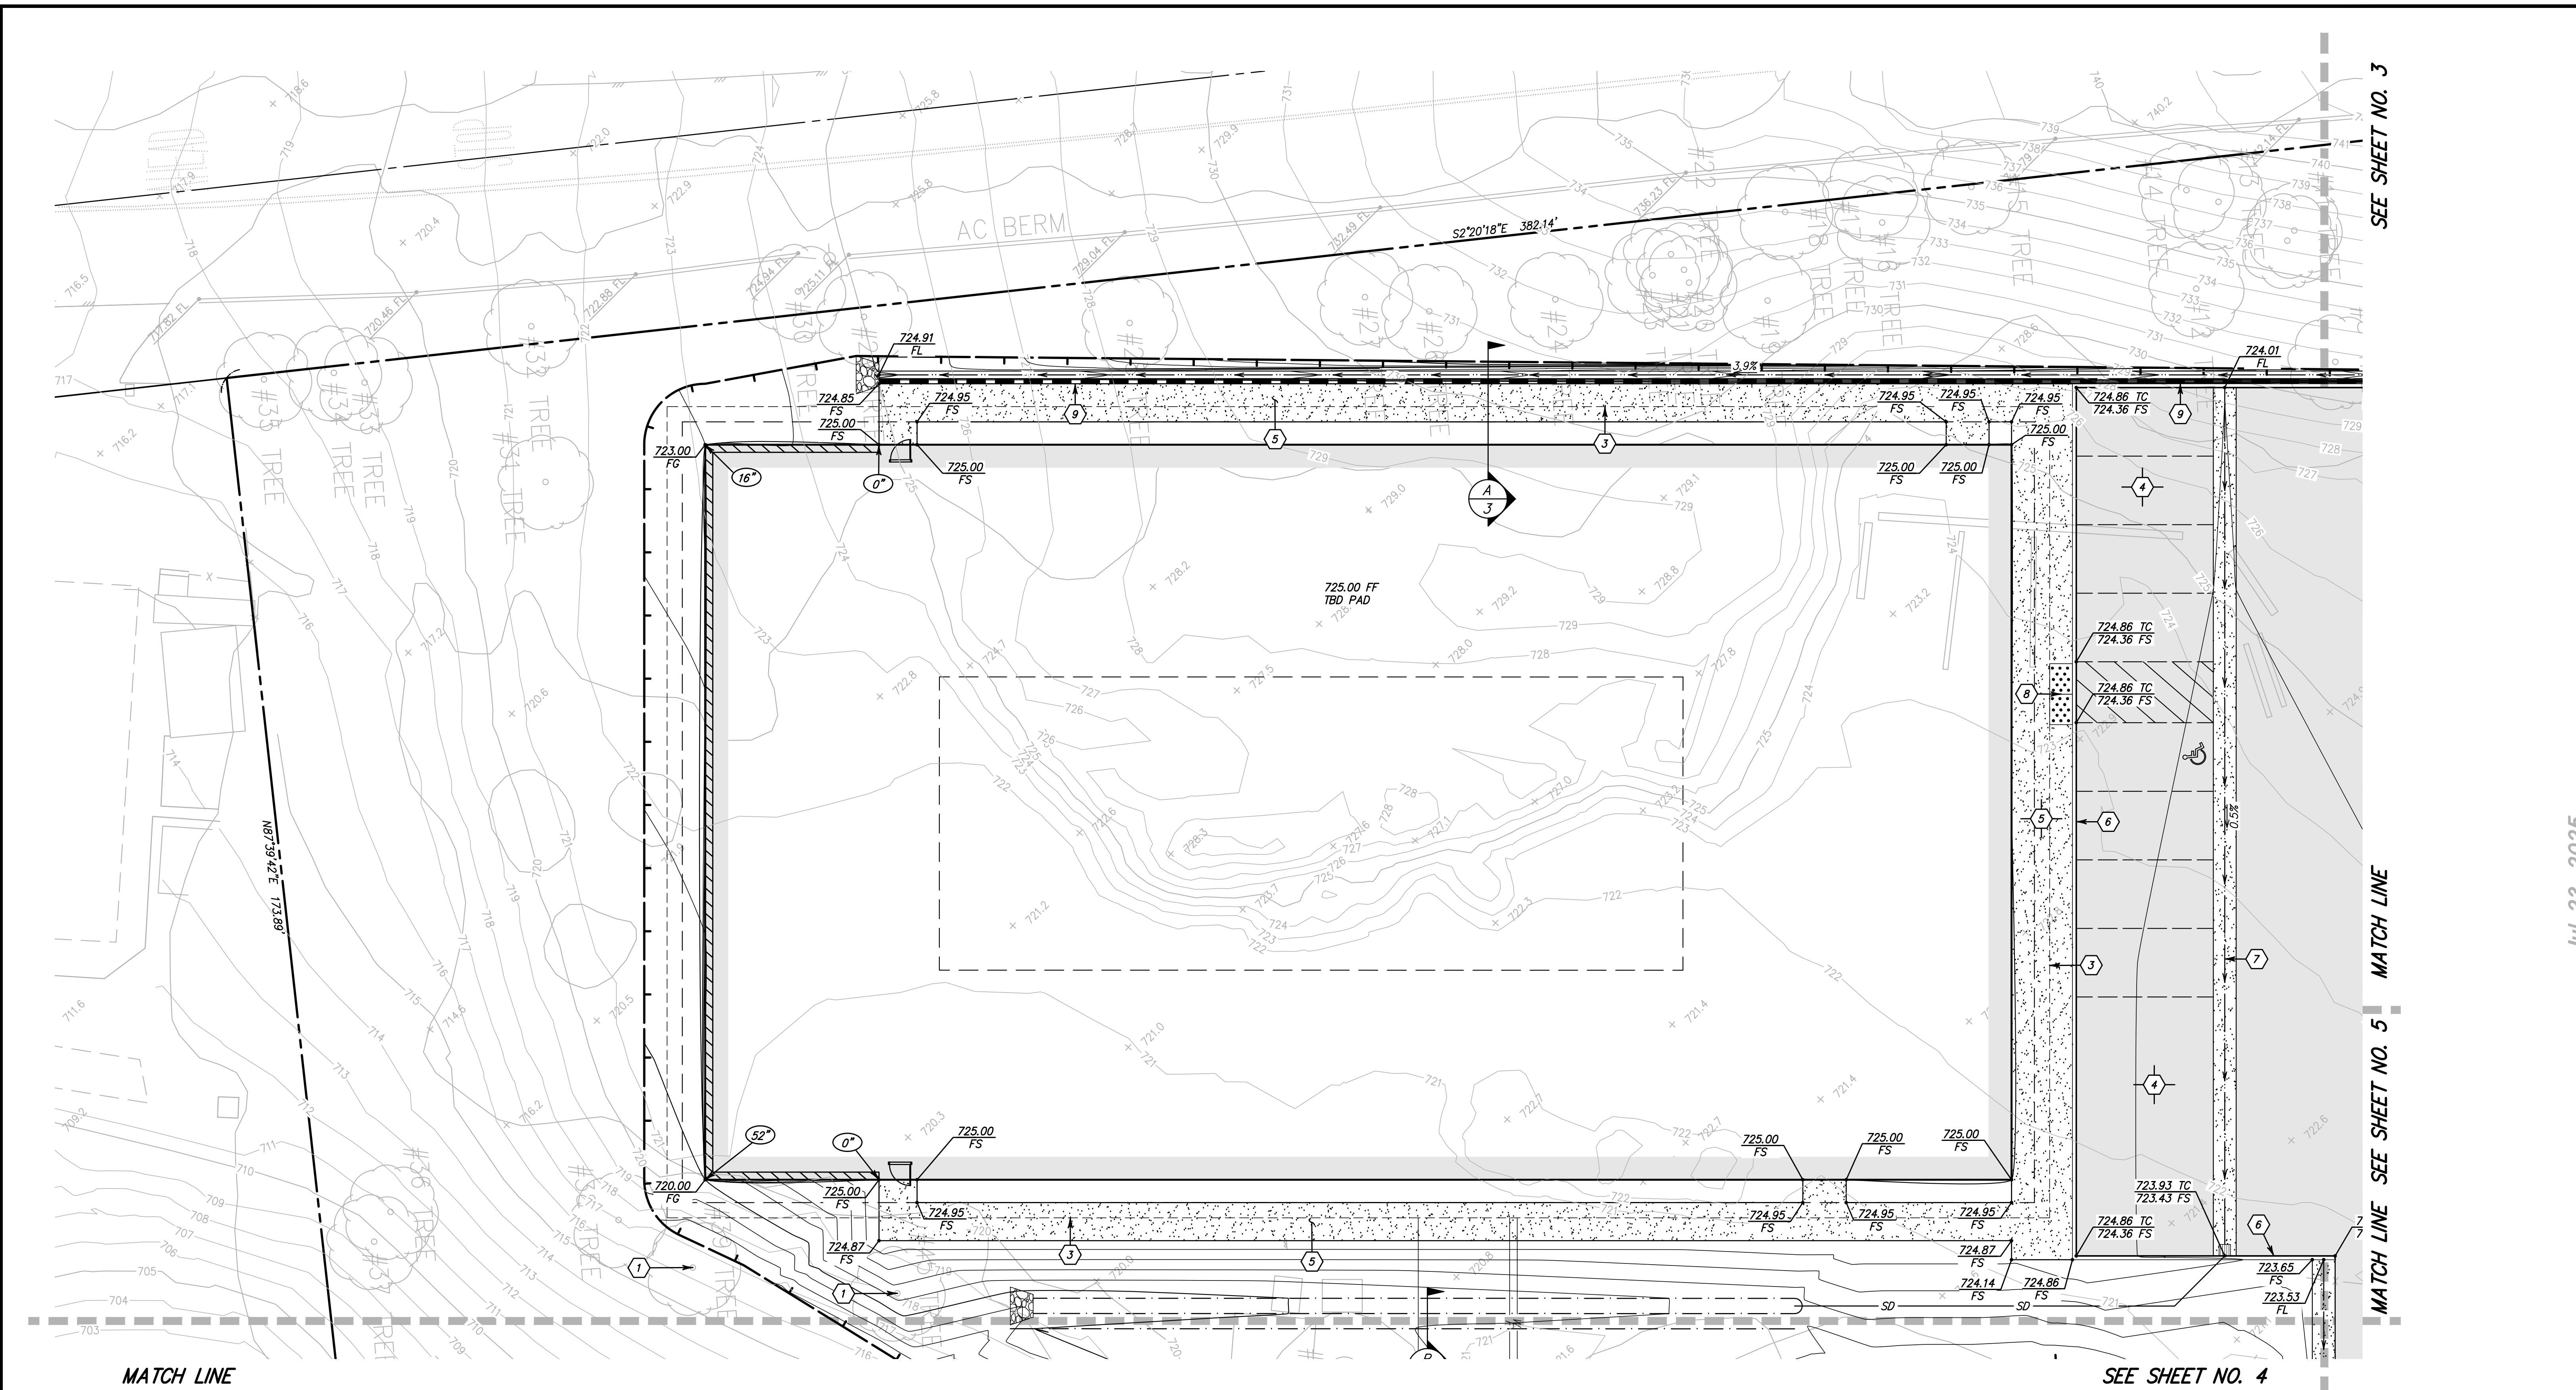

SEE SHEET NO. 3

MATCH LINE

SEE SHEET NO. 5

MATCH LINE

SEE SHEET NO. 4

**NOTICE TO THE CONTRACTOR**  
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9. RETAINING WALL PER SEPARATE PLAN & PERMIT.

Design Development  
NOT FOR CONSTRUCTION  
25 July 2025



REVISION	DESCRIPTION	REV	APP.	DATE

**sanbell**  
1672 DONLON STREET  
VENTURA, CALIF. 93003  
PHONE 805/654-6977  
WEB www.sanbell.com

SUSANNE M. COOPER R.C.E. C060448

DESIGNED CE DRAWN CE  
APPROVED: CITY OF OJAI  
DATE: \_\_\_\_\_  
BY: \_\_\_\_\_  
MANAGER, DEVELOPMENT & INSPECTION SERVICES

**CITY OF OJAI**  
**PUBLIC WORKS AGENCY**

SPEC. NO.
PROJ. NO.

A.P. No.: 023-0-120-020 G.P. No.: GP NO

**GRADING**  
OJAI DIGNITY MOVES  
611 SOUTH MONTGOMERY STREET  
OJAI, CA

SHEET <u>2</u>
OF <u>8</u>
DRAWING NO.
DWG NO.



SEE SHEET NO. 2

MATCH LINE

MATCH LINE

SEE SHEET NO. 5



Know what's below.  
Call before you dig.


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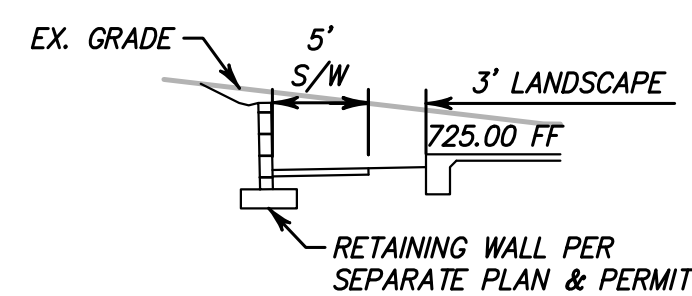
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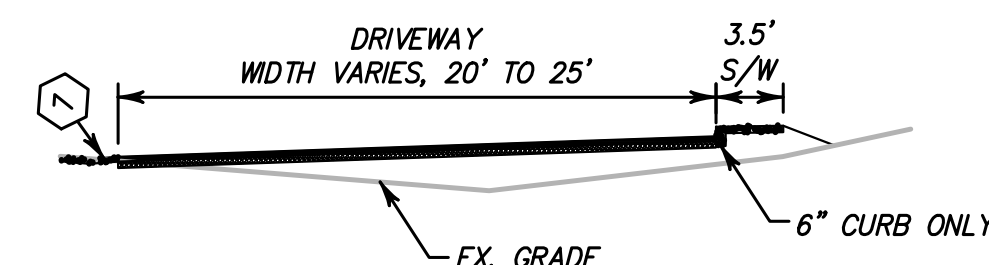


#### CONSTRUCTION NOTES


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**A SECTION A-A**  
NOT TO SCALE



**C SECTION C-C**  
NOT TO SCALE

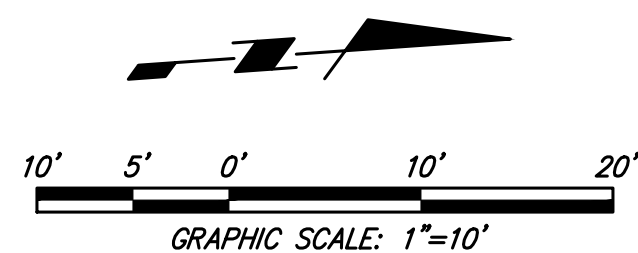

**B BIOSWALE DETAIL**  
NOT TO SCALE

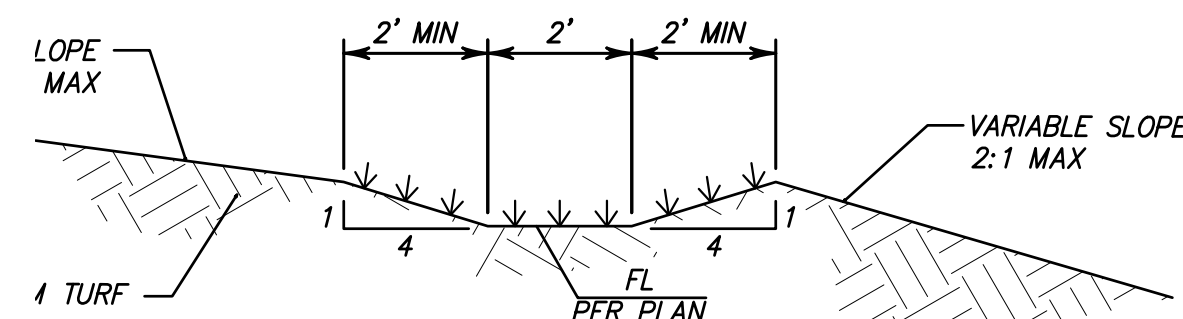Design Development  
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25 July 2025

A.P. No.: 023-0-120-020

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PHONE 805/654-6977  
WEB www.sanbell.com

SUSANNE M. COOPER R.C.E. C060448

DATE

DESIGNED CE  
APPROVED: CITY OF OJAI  
DATE: \_\_\_\_\_  
BY: \_\_\_\_\_

DRAWN CE

MANAGER, DEVELOPMENT & INSPECTION SERVICES

CITY OF OJAI  
PUBLIC WORKS AGENCY

SPEC. NO.

PROJ. NO.

#### GRADING

OJAI DIGNITY MOVES  
611 SOUTH MONTGOMERY STREET  
OJAI, CA

SHEET 3  
OF 8  
DRAWING NO.  
DWG NO.

Jul 23, 2025

GRADING

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MATCH LINE

SEE SHEET NO. 2

SEE SHEET NO. 5

MATCH LINE

S MONTGOMERY ST



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Design Development  
NOT FOR CONSTRUCTION  
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C				
B				
A				



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SUSANNE M. COOPER R.C.E. C060448

DATE

DESIGNED CE DRAWN CE  
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DATE: \_\_\_\_\_  
BY: \_\_\_\_\_  
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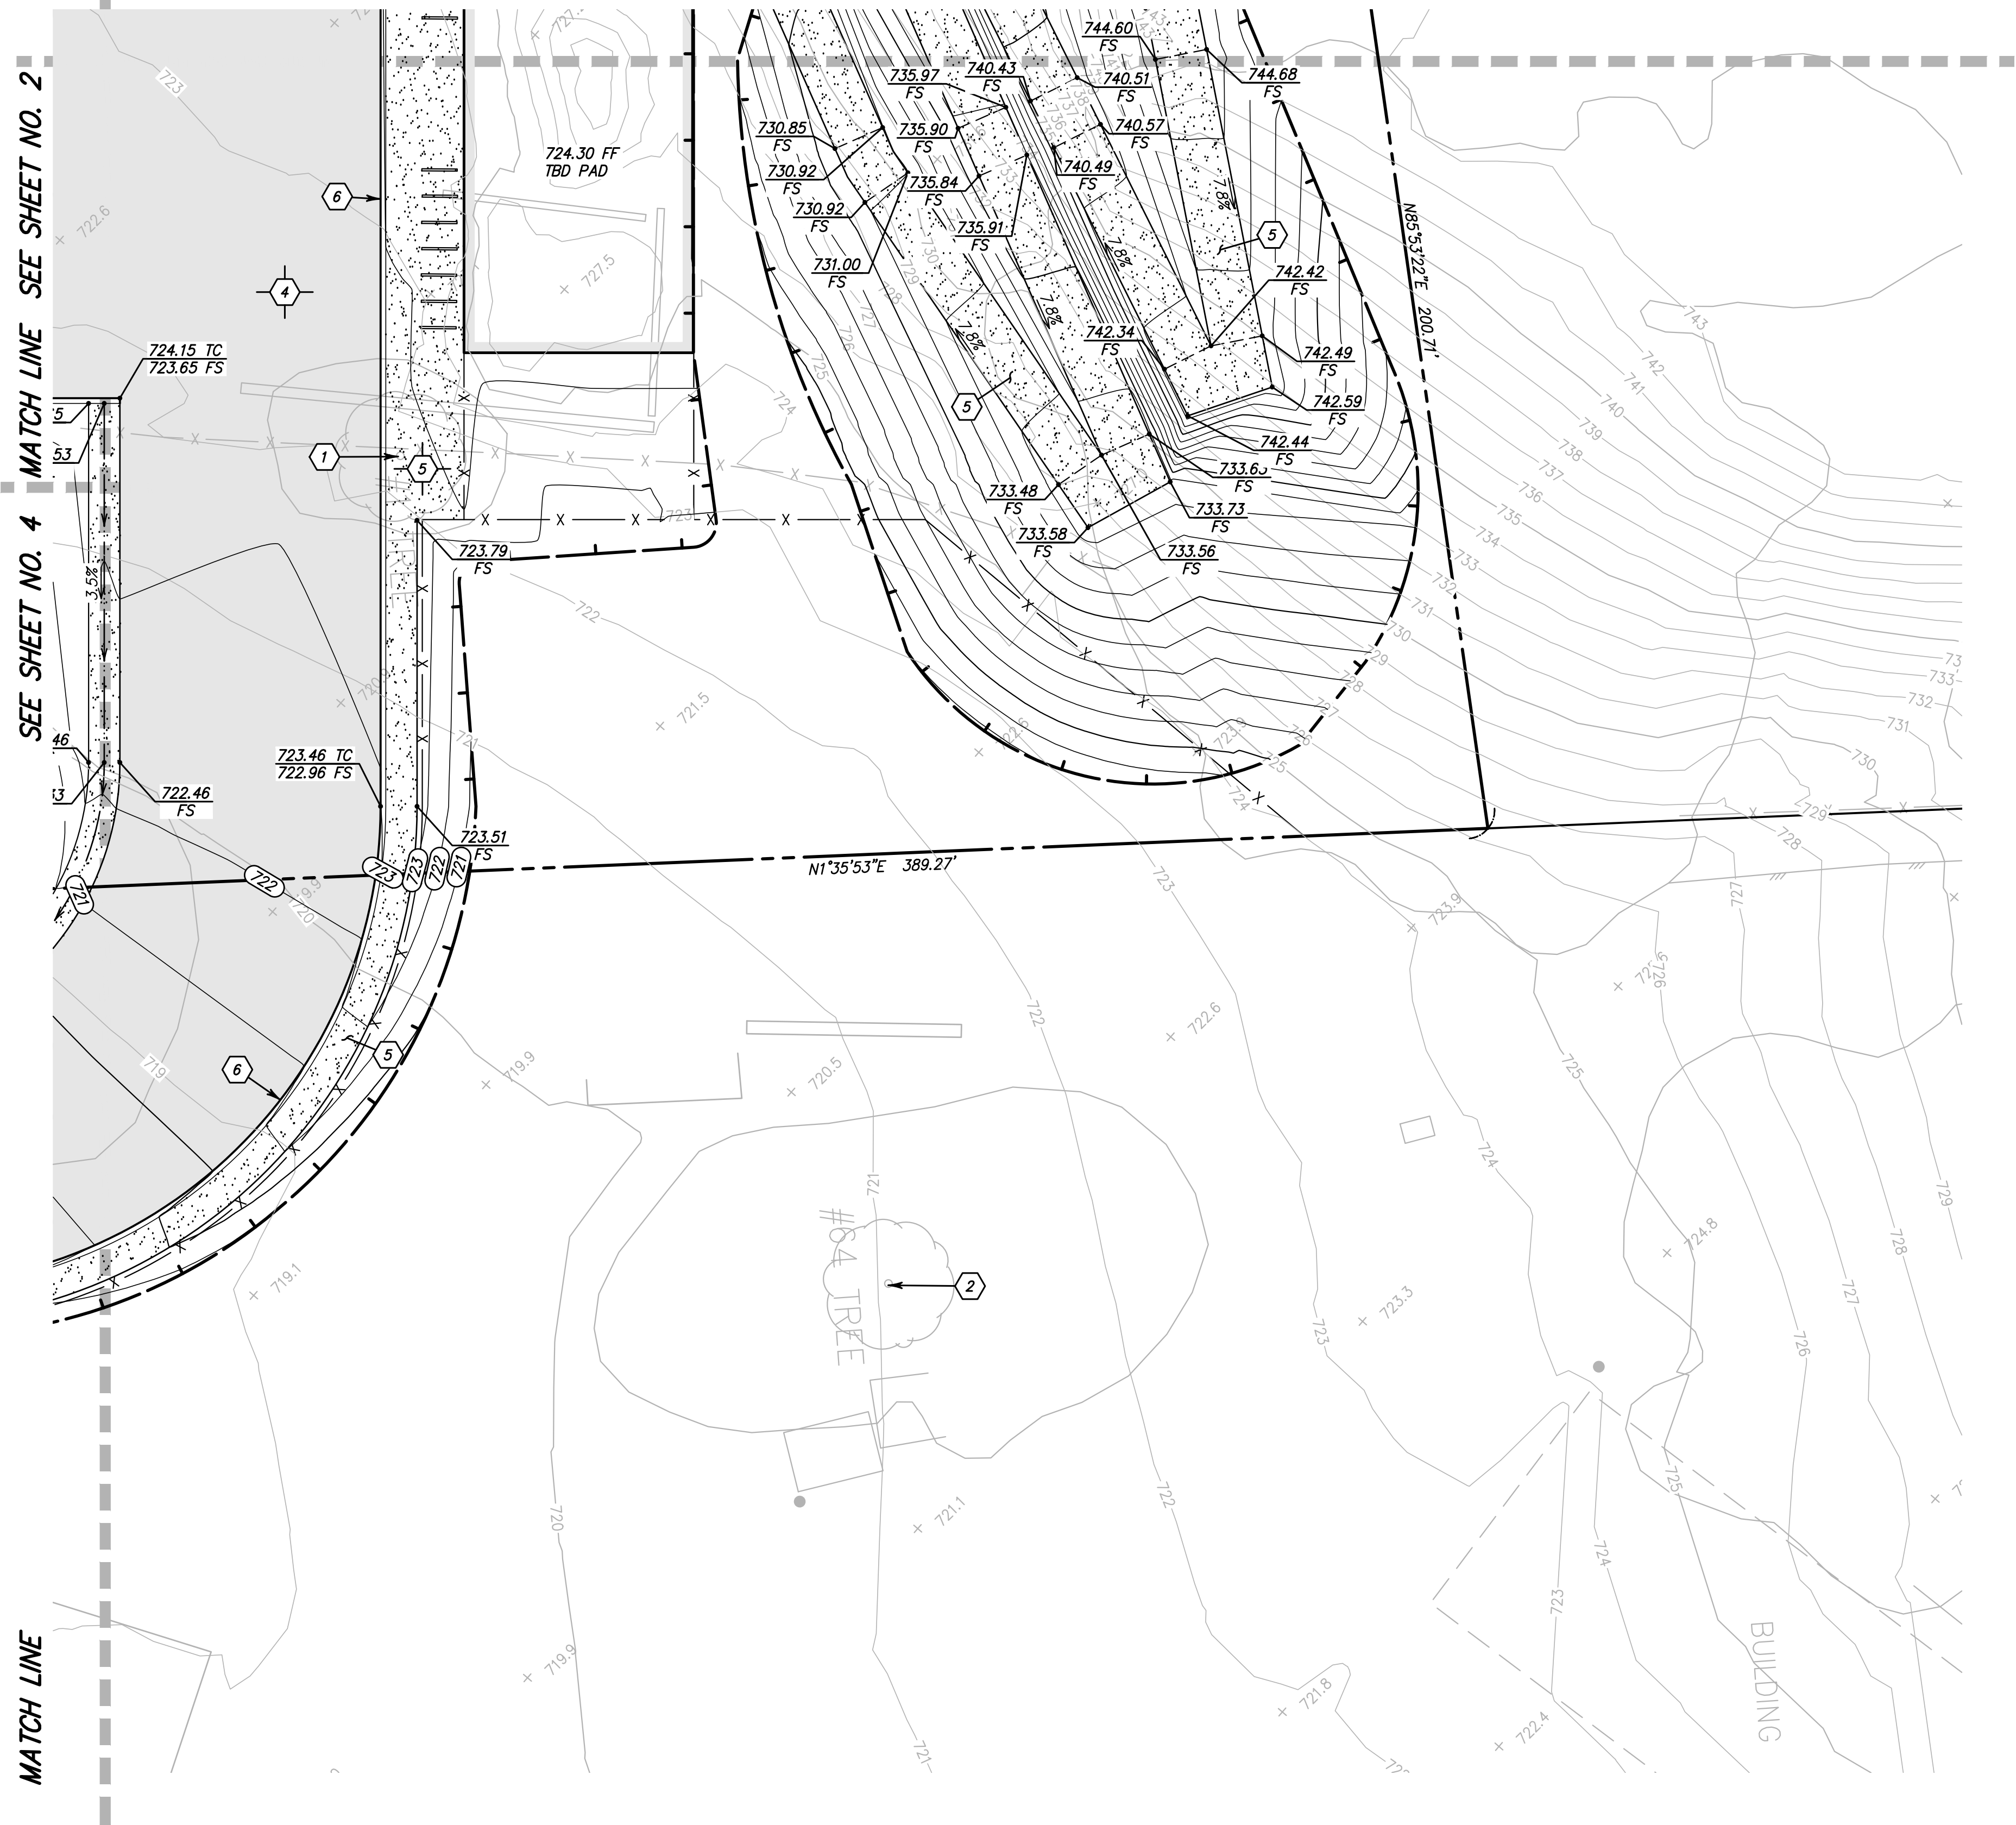
SHEET 4  
OF 8  
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DWG NO

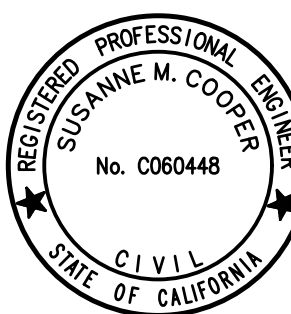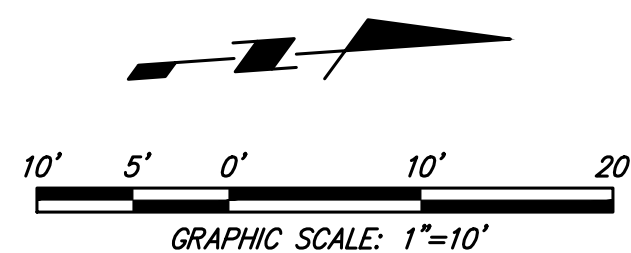Jul 23, 2025  
GRADING

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SEE SHEET NO. 3



## NOTICE TO THE CONTRACTOR


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
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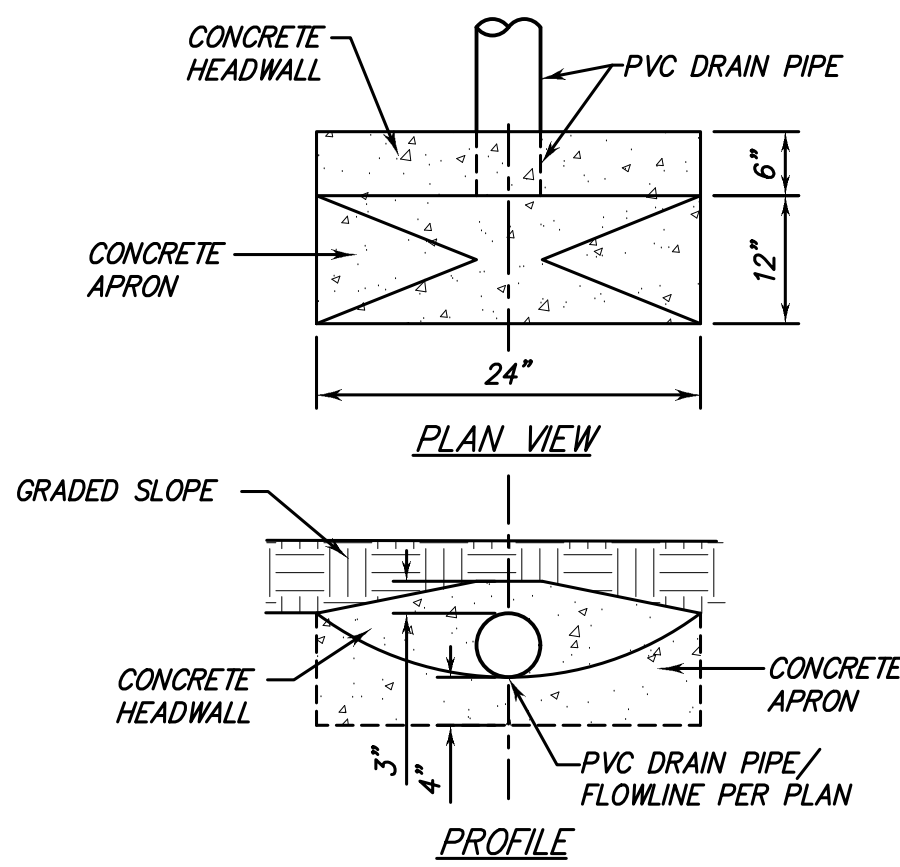
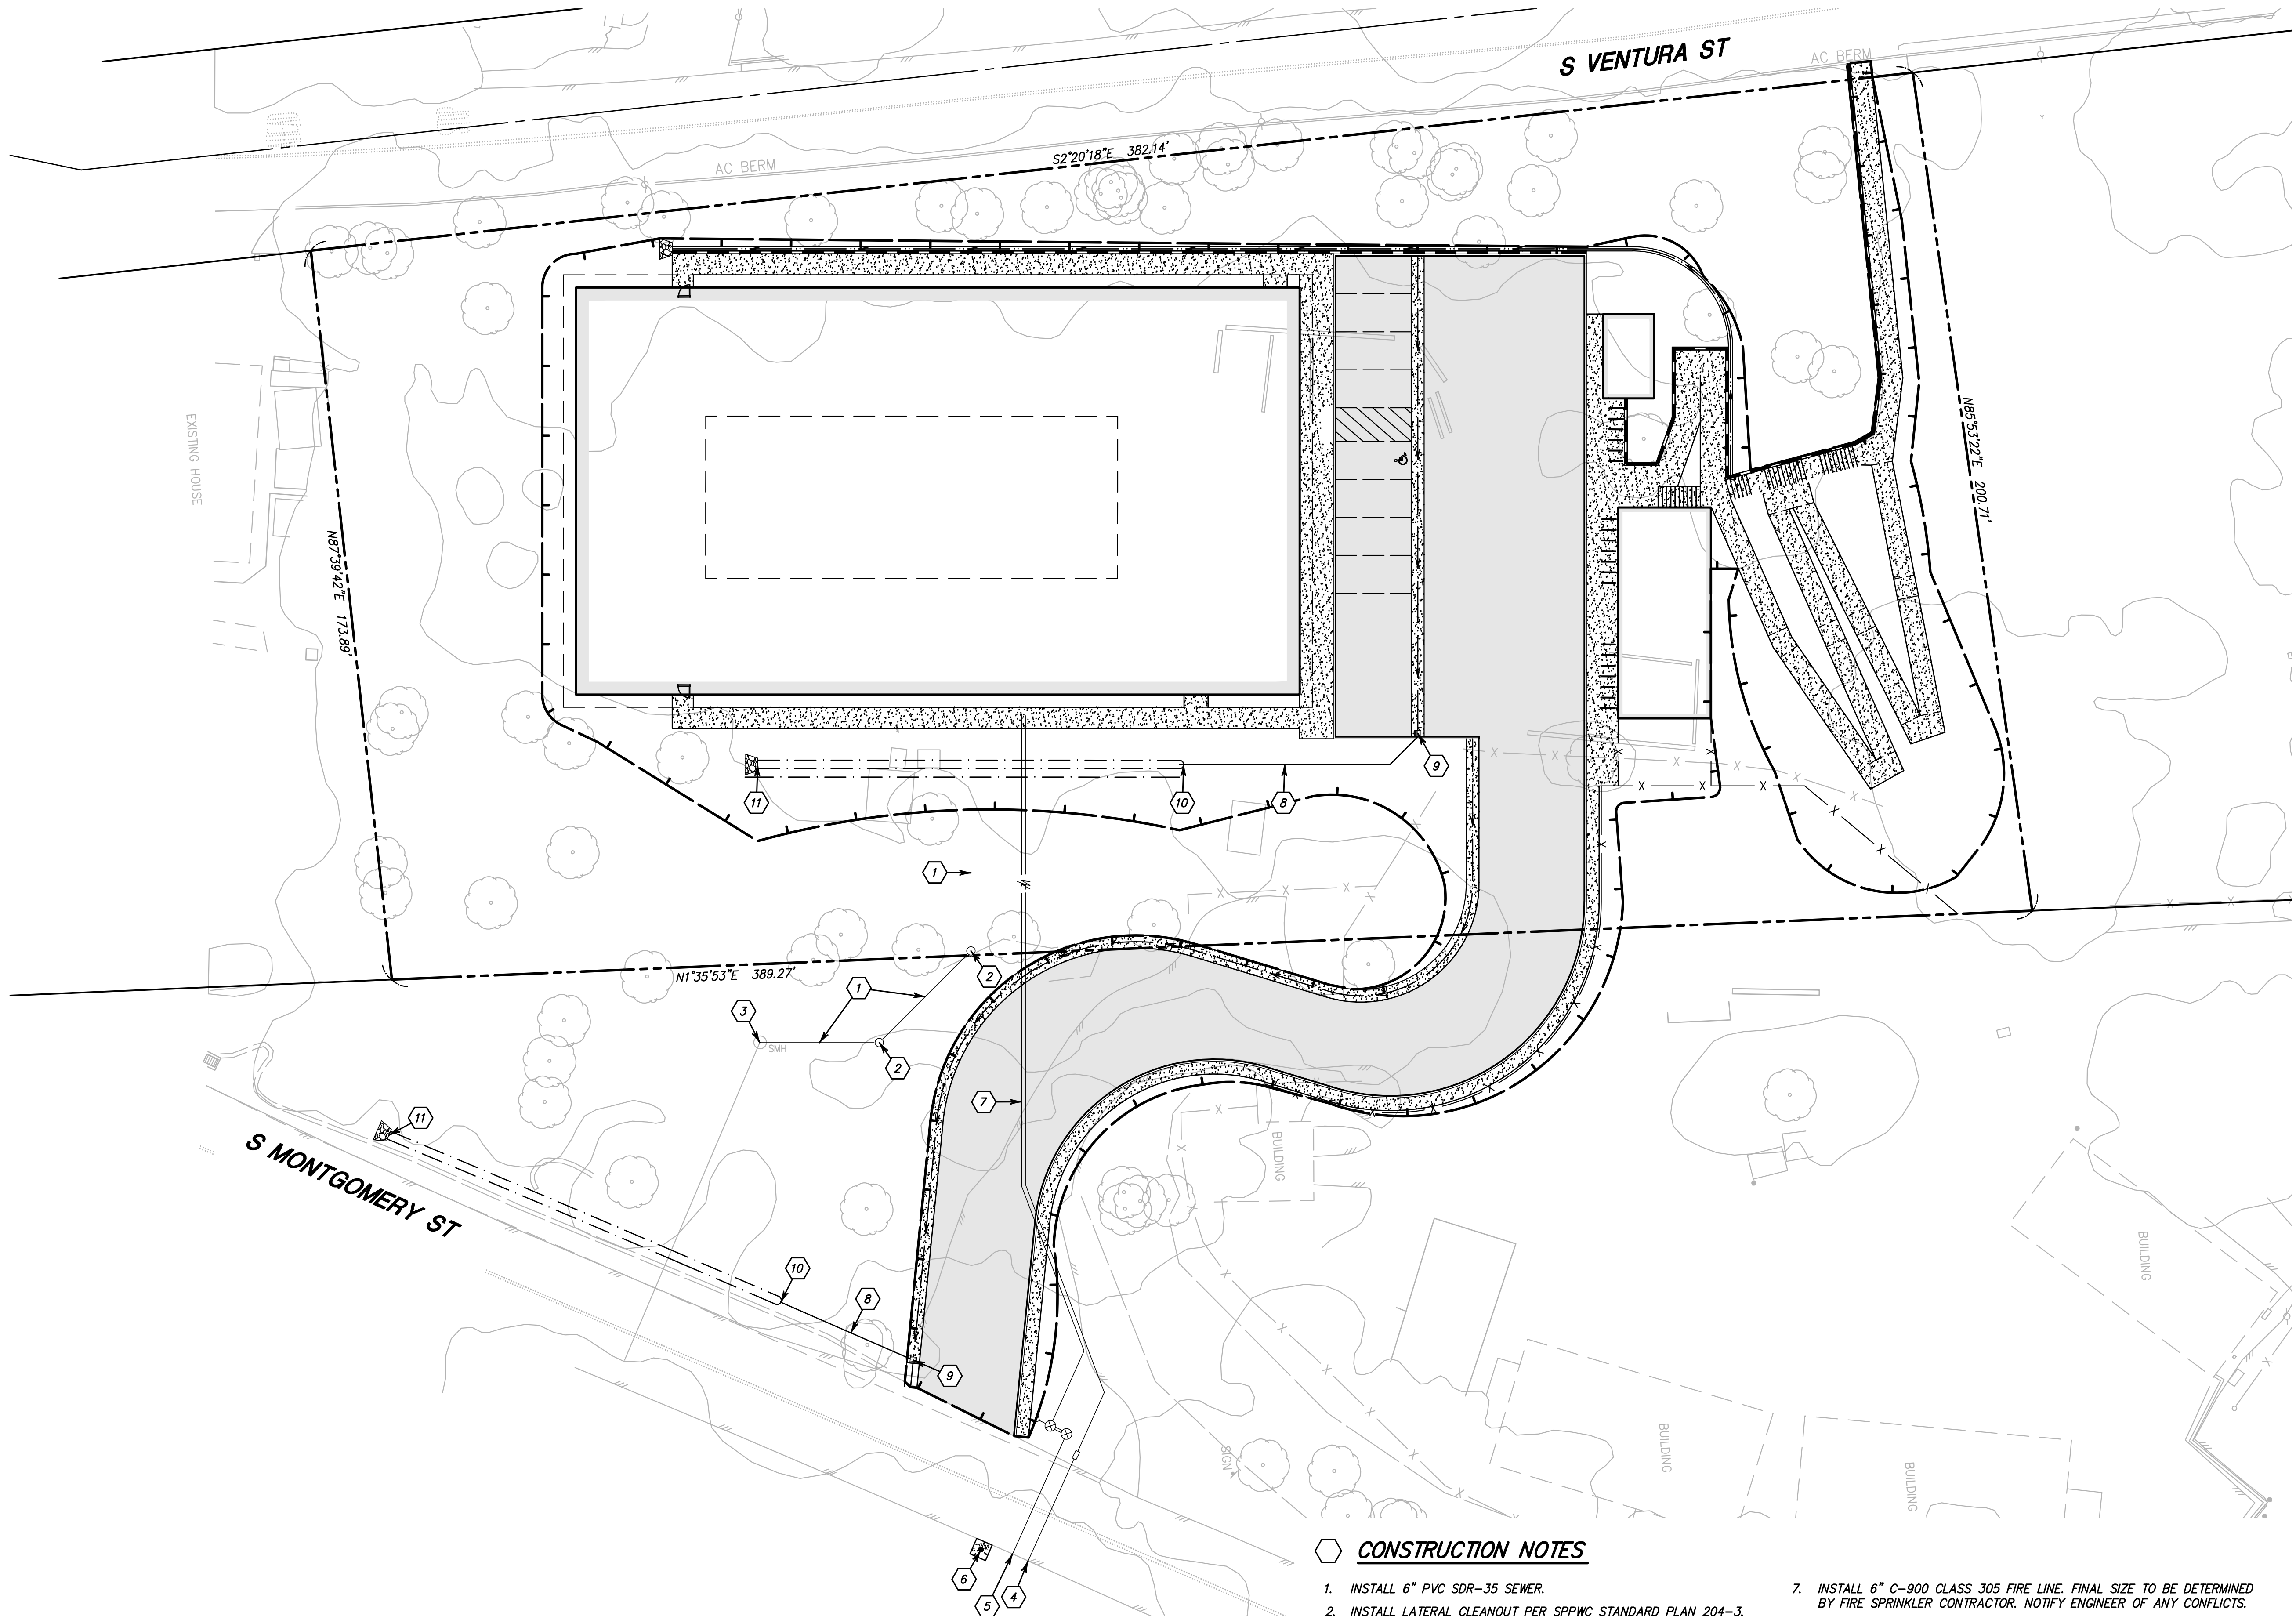
Design Development  
NOT FOR CONSTRUCTION  
25 July 2025

D				<div><div>1672 DONLON STREET VENTURA, CALIF. 93003 PHONE 805/654-6977 WEB www.sanbell.com</div></div> <div>SUSANNE M. COOPER R.C.E. C060448</div> <div>DATE</div>	DESIGNED <u>CE</u>	DRAWN <u>CE</u>	<div>CITY OF OJAI PUBLIC WORKS AGENCY</div>	SPEC. NO.  _____	<div>GRADING OJAI DIGNITY MOVES 611 SOUTH MONTGOMERY STREET OJAI, CA</div>	SHEET <u>5</u>
C					APPROVED: CITY OF OJAI					OF <u>8</u>
B					DATE: _____					DRAWING NO.
A					BY: _____					<u>DWG NO</u>
Δ	REVISION	DESCRIPTION	RCE		APP.	DATE		MANAGER, DEVELOPMENT & INSPECTION SERVICES		


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**GRADING**



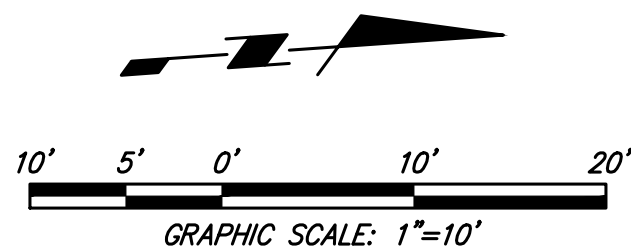


**A** PIPE OUTLET  
NOT TO SCALE

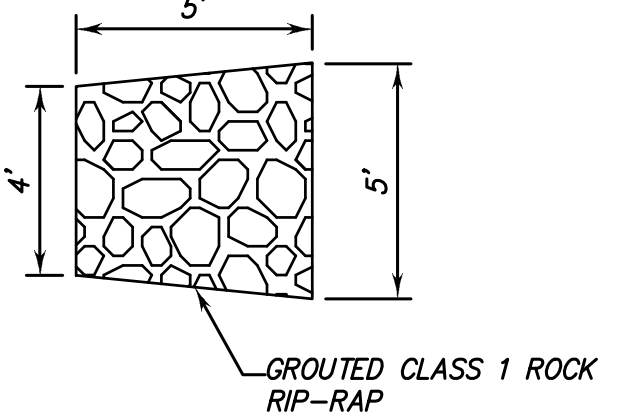

**B** RIP-RAP OUTLET DETAIL  
NOT TO SCALE

**CONSTRUCTION NOTES**

1. INSTALL 6" PVC SDR-35 SEWER.
2. INSTALL LATERAL CLEANOUT PER SPPWC STANDARD PLAN 204-3.
3. JOIN EXISTING MANHOLE PER SPPWC STANDARD PLAN 208-3.
4. INSTALL 1/2" HOT TAPPING SADDLE PER CMWD STANDARD DETAIL SD-111 AND SD-112 WITH A 1/2" SERVICE AND METER.
5. INSTALL 6" PVC C900 FIRE SERVICE WITH DOUBLE DETECTOR CHECK VALVE ASSEMBLY PER CMWD STANDARD DETAIL SD-110.
6. INSTALL 6" WET BARREL FIRE HYDRANT ON CONCRETE PAD PER CMWD STANDARD DETAIL SD-109.
7. INSTALL 6" C-900 CLASS 305 FIRE LINE. FINAL SIZE TO BE DETERMINED BY FIRE SPRINKLER CONTRACTOR. NOTIFY ENGINEER OF ANY CONFLICTS.
8. INSTALL 6" PVC SDR-35 STORM DRAIN LINE PER MANUFACTURER SPECIFICATIONS. SLOPES & INVERTS PER PLAN.
9. INSTALL BROOKS PRODUCTS 12X12 TRAFFIC-RATED CATCH BASIN, OR EQUAL.
10. CONSTRUCT PIPE OUTLET STRUCTURE PER DETAIL A HEREON.
11. CONSTRUCT RIPRAP PER DETAIL B HEREON.

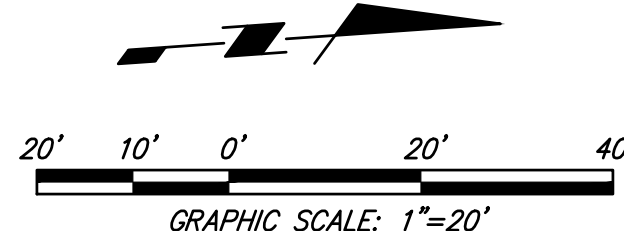

Know what's below.  
Call before you dig.

**CAUTION:**  
EXISTING UTILITIES WERE LOCATED FROM BEST AVAILABLE INFORMATION. CONTRACTOR SHALL POthOLE AND LOCATE EXISTING UTILITIES PRIOR TO CONSTRUCTION AND NOTIFY ENGINEER OF ANY DISCREPANCIES.

Design Development  
NOT FOR CONSTRUCTION  
25 July 2025

REVISION	DESCRIPTION	DATE

**sanbell**  
1672 DONLON STREET  
VENTURA, CALIF. 93003  
PHONE 805/654-6977  
WEB www.sanbell.com

DESIGNED CE DRAWN CE  
APPROVED: CITY OF OJAI  
DATE: \_\_\_\_\_  
BY: \_\_\_\_\_  
MANAGER, DEVELOPMENT & INSPECTION SERVICES

**CITY OF OJAI  
PUBLIC WORKS AGENCY**

SPEC. NO.  
\_\_\_\_\_  
PROJ. NO.  
\_\_\_\_\_

A.P. No.: 023-0-120-020

G.P. No.: GP NO


**COMPOSITE UTILITY PLAN**  
OJAI DIGNITY MOVES  
611 SOUTH MONTGOMERY STREET  
OJAI, CA

SHEET 6  
OF 8  
DRAWING NO.  
\_\_\_\_\_  
DWG NO  
\_\_\_\_\_

Jul 23, 2025

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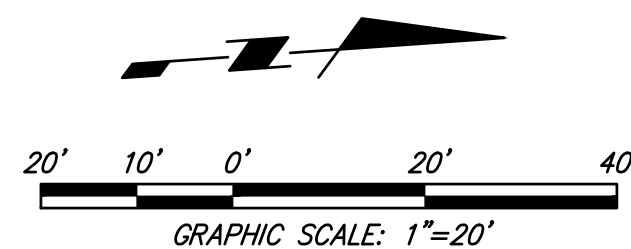


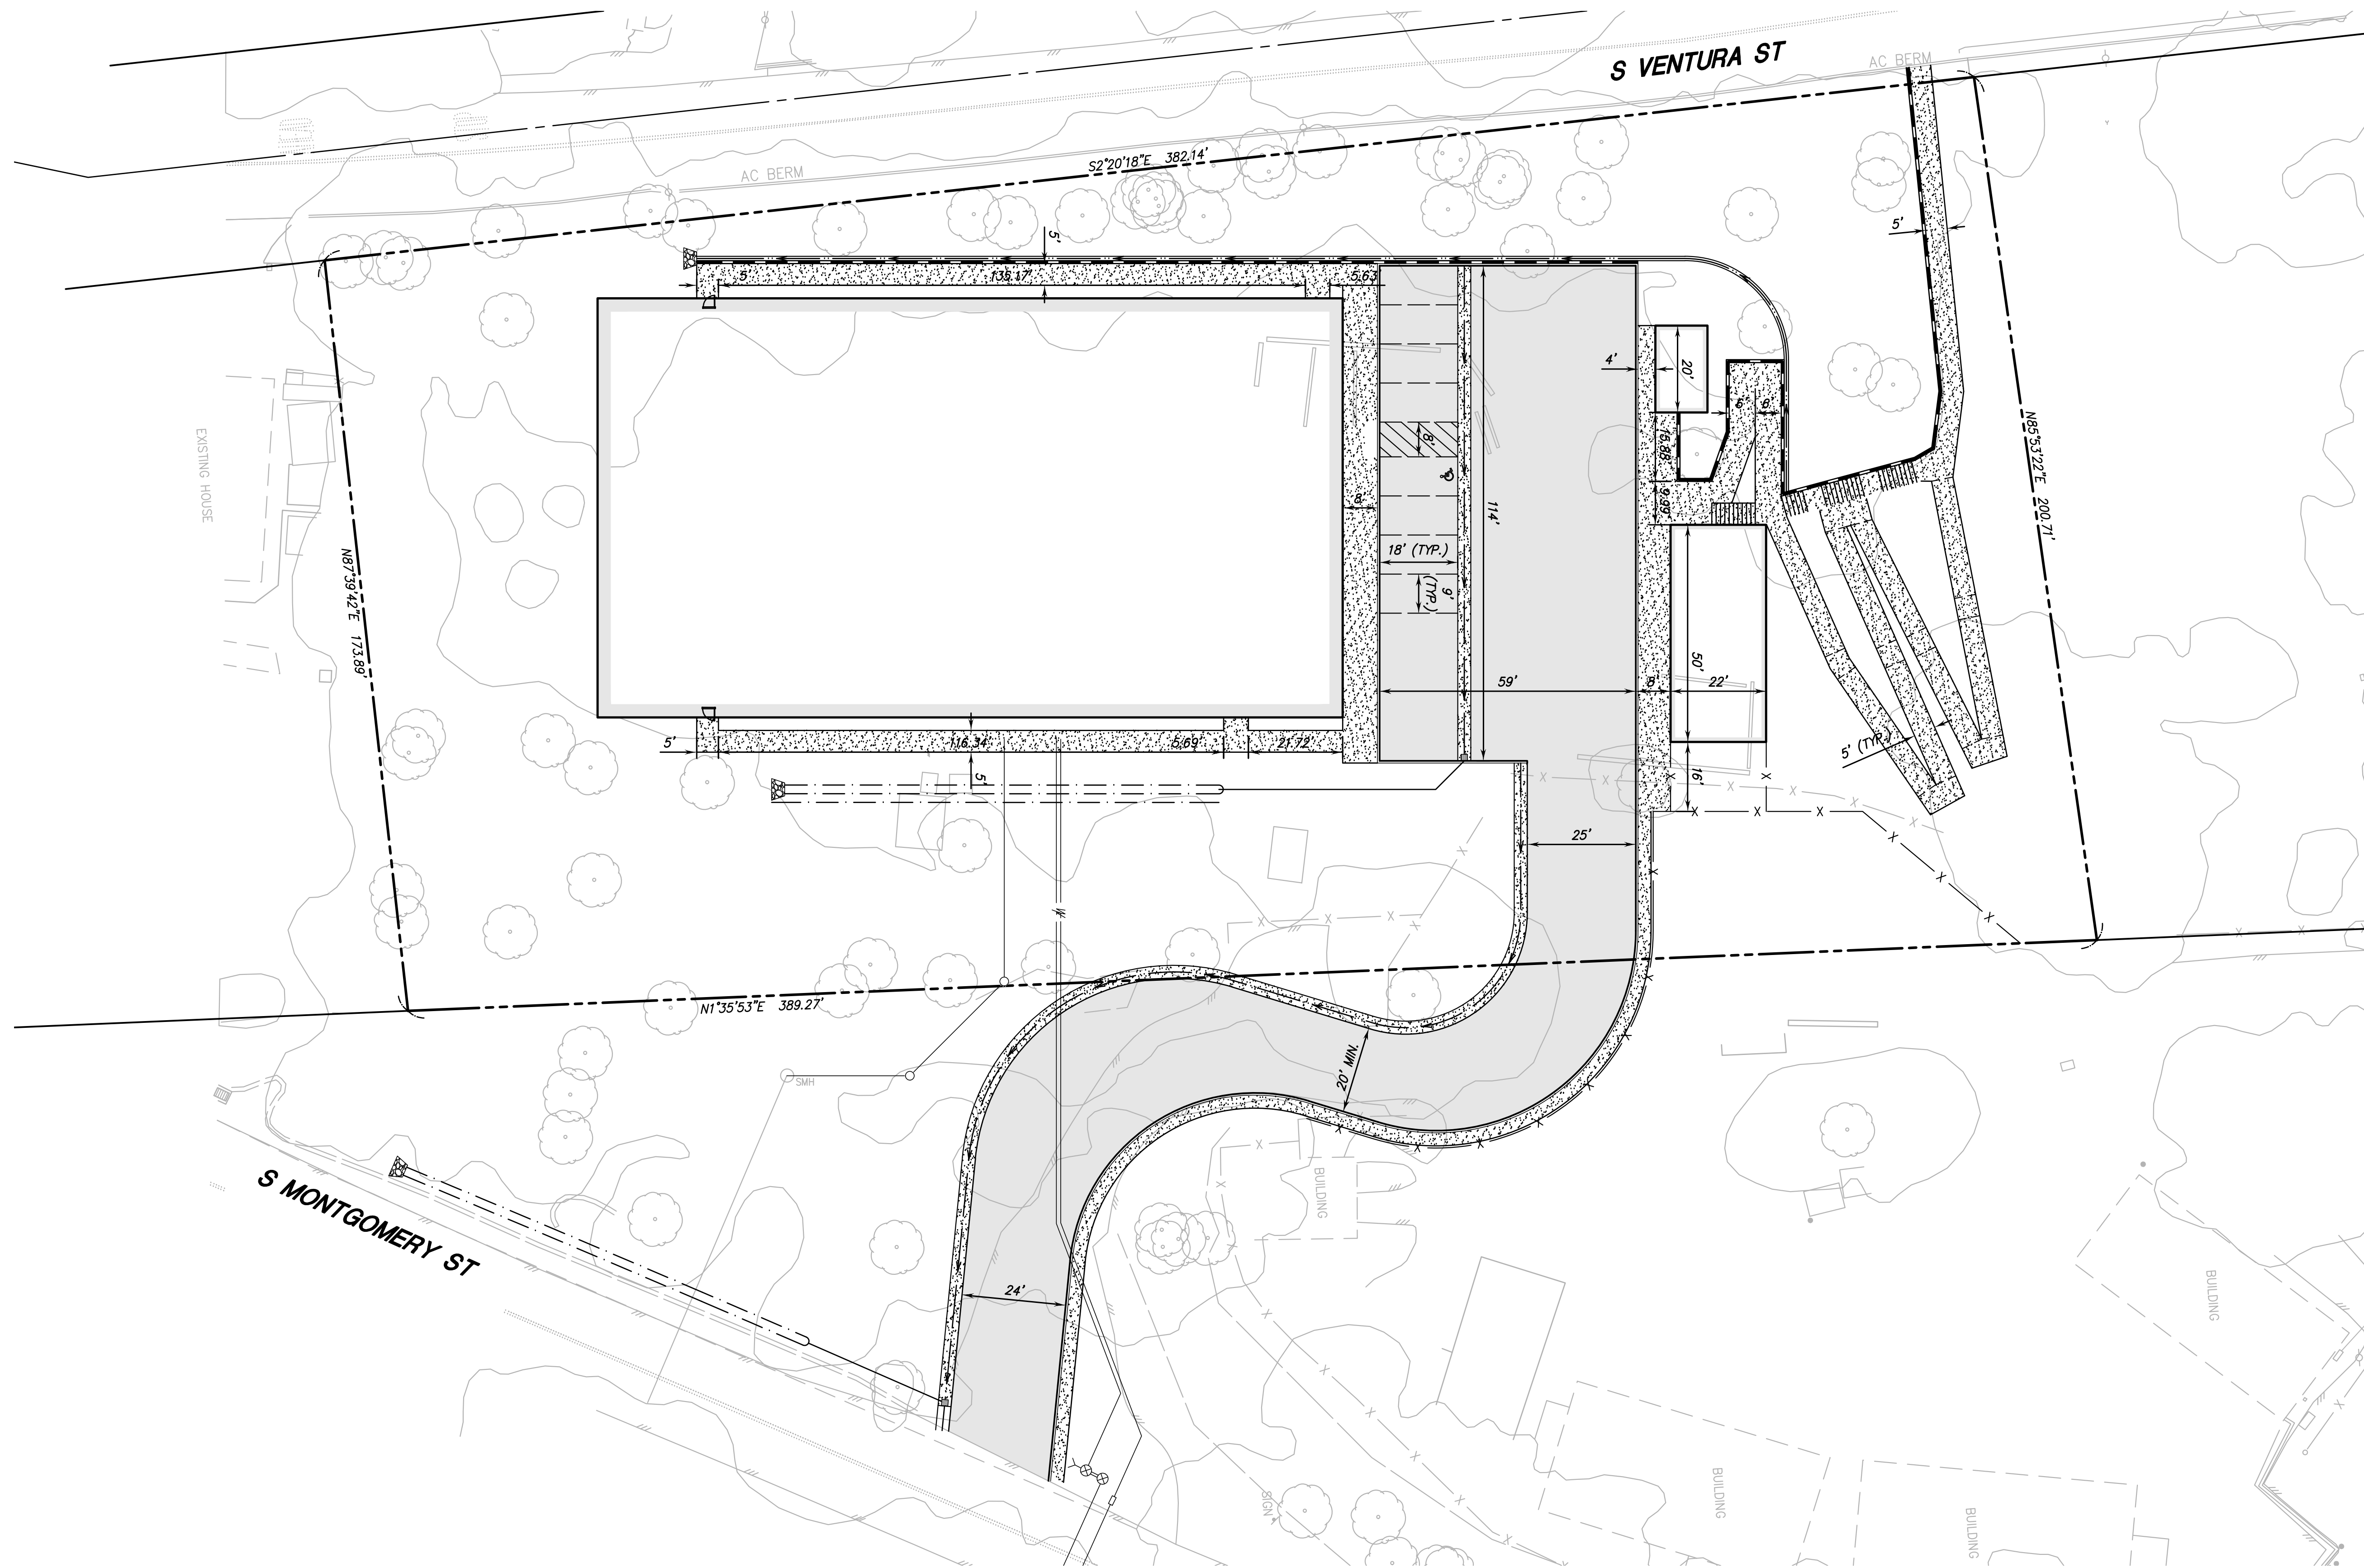

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Design Development  
NOT FOR CONSTRUCTION  
25 July 2025

REVISION	DESCRIPTION	DATE
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C		
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VENTURA, CALIF. 93003  
PHONE 805/654-6977  
WEB www.sanbell.com

SUSANNE M. COOPER R.C.E. C060448

DATE

DESIGNED CE DRAWN CE  
APPROVED: CITY OF OJAI  
DATE: \_\_\_\_\_  
BY: \_\_\_\_\_  
MANAGER, DEVELOPMENT & INSPECTION SERVICES

CITY OF OJAI  
PUBLIC WORKS AGENCY

SPEC. NO.
PROJ. NO.

A.P. No.: 023-0-120-020

G.P. No.: GP NO

**HORIZONTAL CONTROL PLAN**  
OJAI DIGNITY MOVES  
611 SOUTH MONTGOMERY STREET  
OJAI, CA

SHEET 7  
OF 8  
DRAWING NO.  
DWG NO

Jul 23, 2025

HORIZONTAL CONTROL


\\00206260\proj\Improvement Plans\023-0-120-020-HC.dwg Jul 23, 2025, 9:42am ceros



General Notes


- Best Management Practices (BMP's) contained herein reflect minimum requirements. For additional BMP's refer to California Stormwater BMP Handbooks.
- All construction activity shall be performed in accordance with a Storm Water Pollution Prevention Plan (SWPPP, 1 acre and larger) and/or a Storm Water Pollution Control Plan (SWPCP, less than 1 acre) developed and implemented in compliance with requirements of the Ventura Countywide Stormwater Quality Management Program, National Pollution Discharge Elimination System (NPDES) Permit No. CAS063339.
- The SWPPP / SWPCP shall:
  - Identify potential pollutant sources and include the design and placement of BMP's to effectively prohibit the entry of pollutants from the construction site into and onto the street and storm drain system during construction.
  - Be kept on site and amended to reflect changing conditions throughout the course of construction.
  - Be kept up to date. Any additional updates requested by agency representatives are to be made immediately.
- Non-Stormwater discharges are prohibited from entering any storm drain system and/or street.
- Discharges of pumped ground water require a discharge permit from the State of California Regional Water Quality Control Board (RWQCB).
- Pollutants shall be removed from stormwater discharges to the Maximum Extent Practicable (MEP) through design & implementation of the SWPPP / SWPCP.
- A standby crew for emergency work shall be available at all times during the rainy season (Oct. 1 to Apr. 15). Necessary materials shall be available on site and stockpiled at convenient locations to facilitate rapid construction of emergency devices when rain is imminent.
- Portable sanitary facilities shall be located on relatively level ground away from traffic areas, drainage courses, and storm drain inlets.
- Employees, subcontractors and suppliers shall be educated on all BMP's including concrete waste storage and disposal procedures.
- Sediment control practices shall effectively prevent a net increase of sediment load in stormwater discharge.

A Catch Basin/Inlet Protection

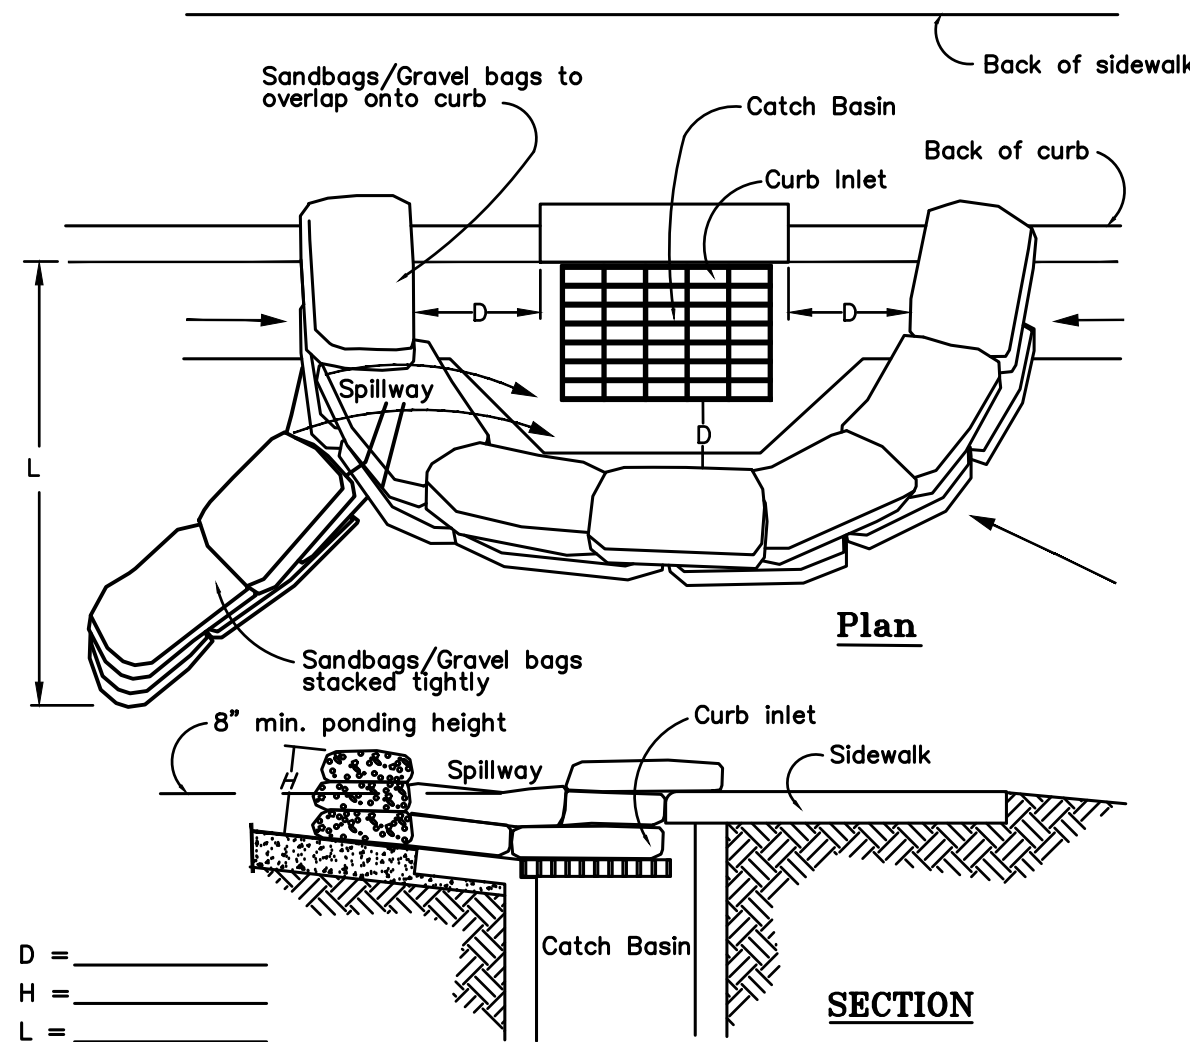


- Notes:
- Catch Basin/Inlet protection shall be installed wherever there is a potential of stormwater or non-stormwater being discharged into it.
  - Inlet protection is required along with other pollution prevention measures such as: erosion control, soil stabilization, and measures to prevent tracking onto paved surfaces.
  - Modify inlet protection as needed to avoid creating traffic hazards.
  - Include inlet protection measures at hillside v-ditches and misc. drainage swales.
  - Inlet protection shall be inspected and accumulated sediments removed. Sediment shall be disposed of properly and in a manner that assures that the sediment does not enter the storm drain system.
  - Damaged bags shall be replaced immediately.
  - Additional sandbag sediment traps shall be placed at intervals as indicated on site plan.

B Silt Fence

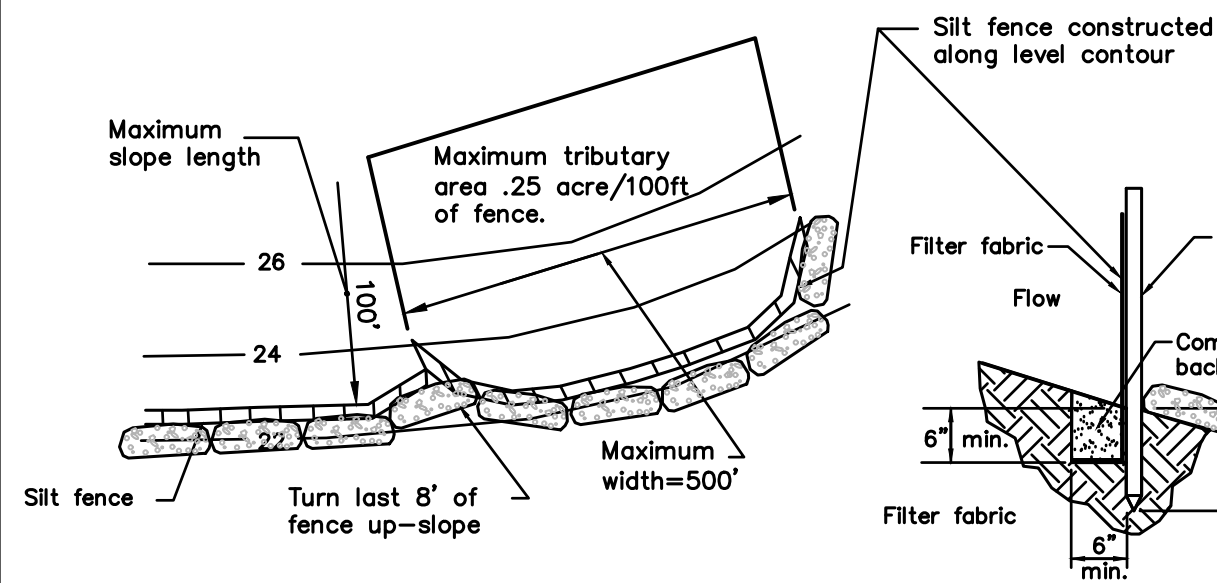

- Notes:
- Maintain silt fence for duration of construction period. Construct the silt fence along a level contour.
  - Silt fences shall remain in place until the disturbed area is permanently stabilized.
  - Provide sufficient room for runoff to pond behind the fence and allow sediment removal equipment to pass between the silt fence and toe of slope or other obstructions. About 1200 sq. ft. of ponding area shall be provided for every acre draining to the fence.
  - Turn the ends of the filter fence uphill to prevent stormwater from flowing around the fence.
  - Leave an undisturbed or stabilized area immediately downslope from the fence.
  - Do not place in live stream or intermittently flowing channels.
  - When standard filter fabric is used, a wire mesh support fence shall be fastened securely to the upslope side of the posts using heavy-duty wire staples at least 1 inch long, tie wires or hog rings.

C Stabilized Construction Entrance

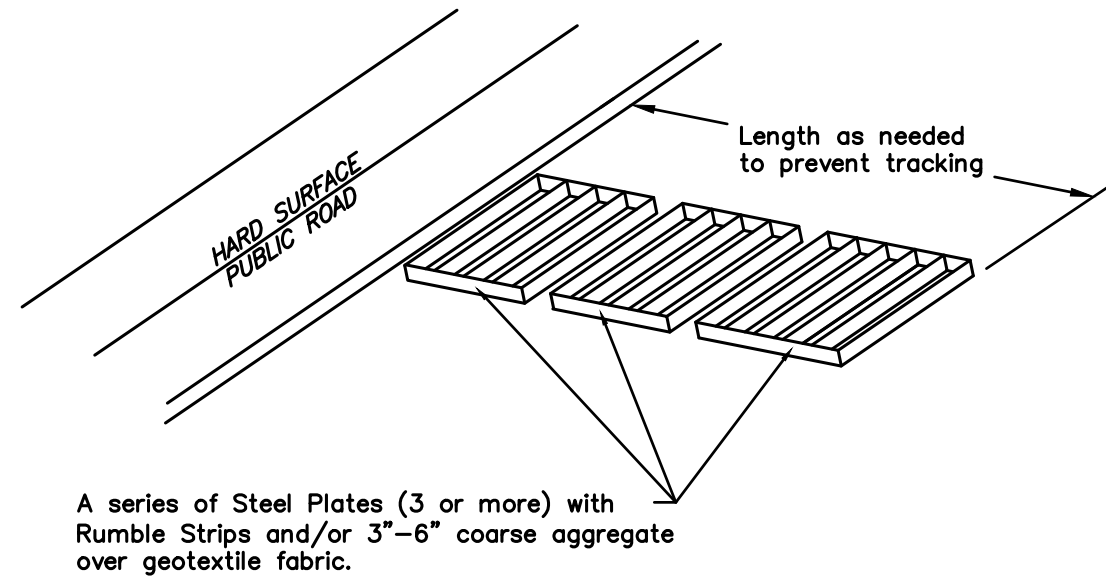


- Notes:
- Sediments and other materials shall not be tracked from the site by vehicle traffic. The construction entrance roadways shall be stabilized so as to prevent sediments from being deposited into the public roads. Depositions must be swept up immediately and may not be washed down by rain or other means into the storm drain system.
  - Stabilized construction entrance shall be:
    - Located at any point where traffic will be entering or leaving a construction site to or from a public right of way, street, alley, and sidewalk or parking area.
    - A series of steel plates with rumble strips, and/or 3-inch to 6-inch coarse aggregate, min. 12-inch thickness, with length & width as needed to adequately prevent any tracking onto paved surfaces.
  - Adding a wash rack with a sediment trap large enough to collect all wash water can greatly improve efficiency.
  - All vehicles accessing the construction site shall utilize the stabilized construction entrance sites.

Street Maintenance


- Remove all sediment deposited on paved roadways immediately.
- Sweep paved areas that receive construction traffic whenever sediment becomes visible.
- Pavement washing with water is prohibited if it results in a discharge to the storm drain system.

D Erosion Control

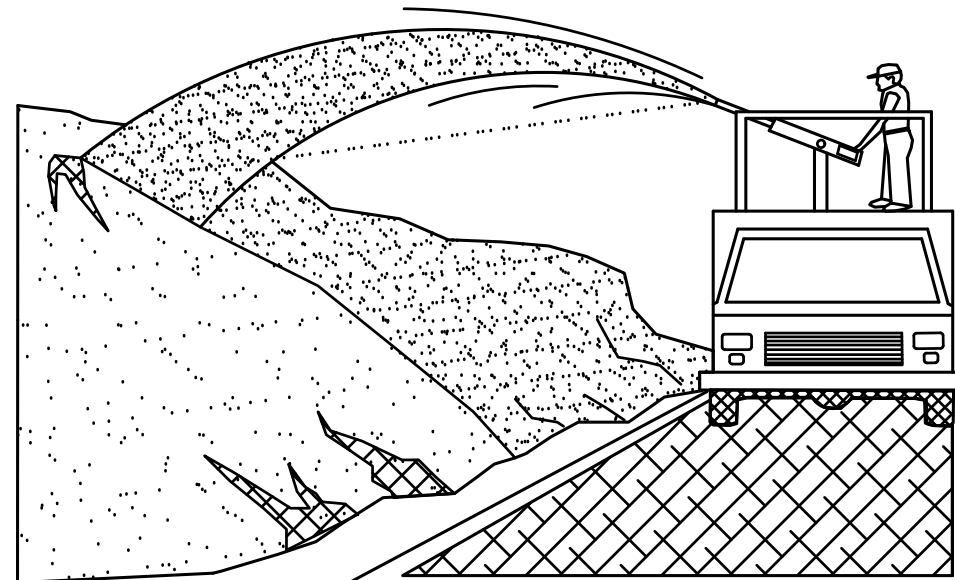


- Notes:
- Soil/Slope stabilization practices shall be designed to preserve existing vegetation where feasible and to revegetate open areas as soon as feasible after grading. These control practices shall include temporary seeding, permanent seeding, mulching, sod stabilization, vegetative buffer strips, protection of trees, or other soil stabilization practices.
  - Soil stabilization shall be implemented year-round. Exposed soil and stockpiles shall be covered after 14 days of inactivity.
  - Stabilization practices shall control/prevent erosion from the forces of wind and water.
  - Stabilization practices shall be implemented in conjunction with sediment trapping/filtering practices and practices to reduce the tracking of sediment onto paved roads.
  - When using straw mulching, the minimum application shall be 1.5 tons/acre. Mulch must be anchored immediately to minimize loss by wind or water.
  - When using hydroseeding/mulching, the minimum application of wood fiber shall be 2,000 lbs/acre, that does not contain more than 50 percent newsprint.
  - For seeding recommendations, contact: USDA, Natural Resources Conservation Service or Ventura County RCD.

E Material Storage

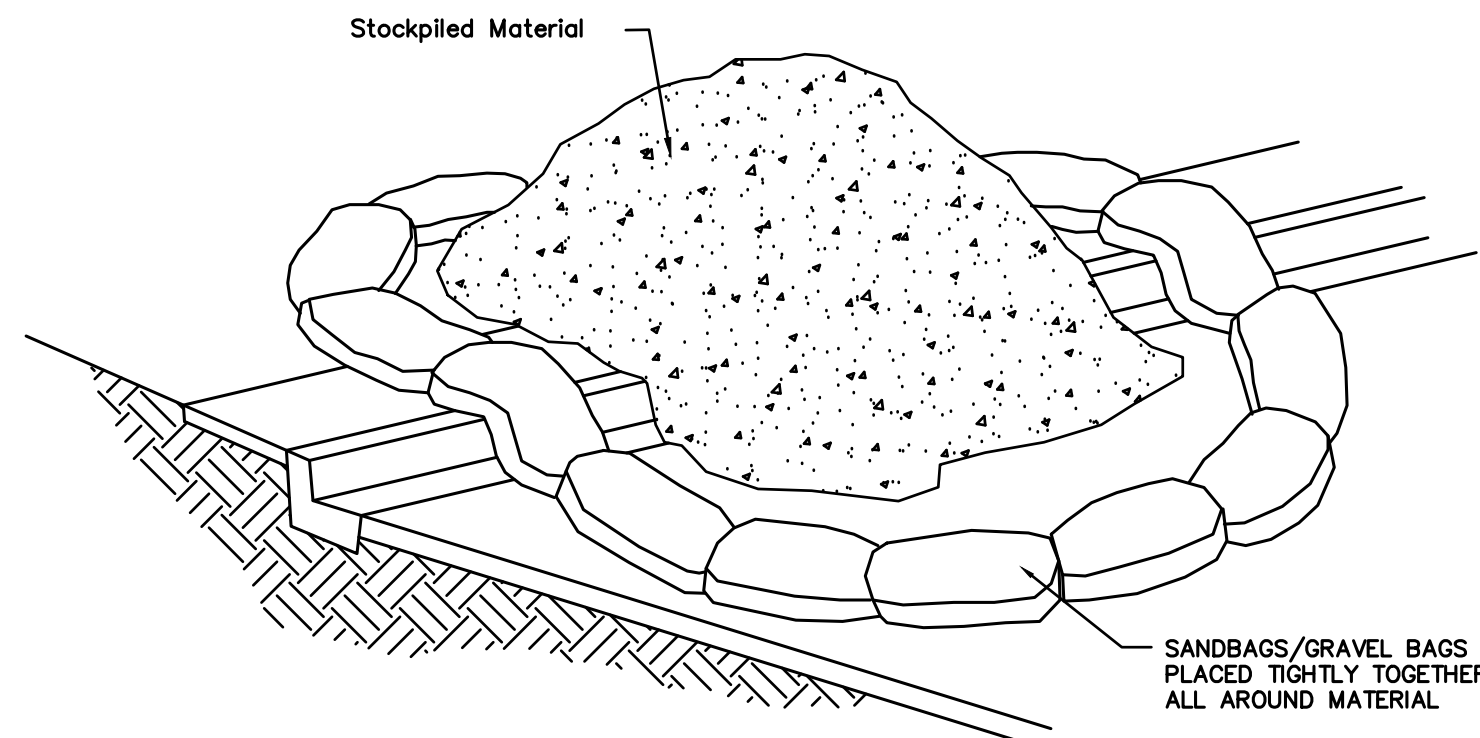


- Notes:
- Dirt and other construction related materials placed in the street or on other impervious surfaces must be contained with sandbags or other measures to prevent transport to the stormdrain system.
  - Any construction material stored or stockpiled on-site shall be protected from being transported by the force of wind or water.

F Concrete Waste Management

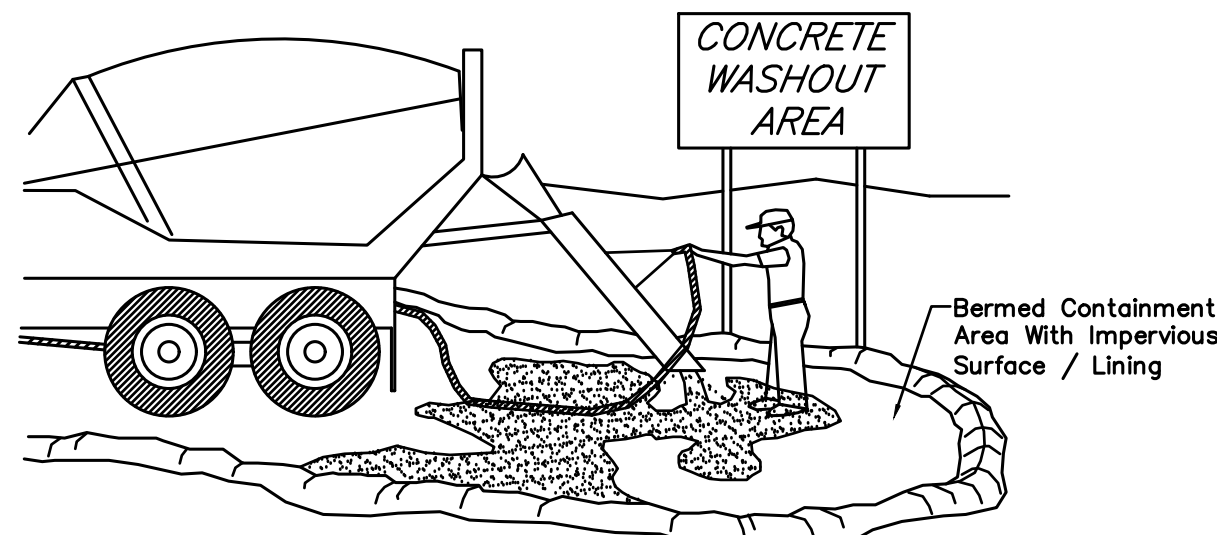


- Notes:
- Excess and waste concrete shall not be washed into the street or into a drainage system.
  - For washout of concrete and mortar products, a designated containment facility of sufficient capacity to retain liquid and solid waste shall be provided on site.
  - Slurry from concrete and asphalt saw cutting shall be vacuumed or contained, dried, picked up and disposed of properly.

G Vehicle/Equipment Fueling

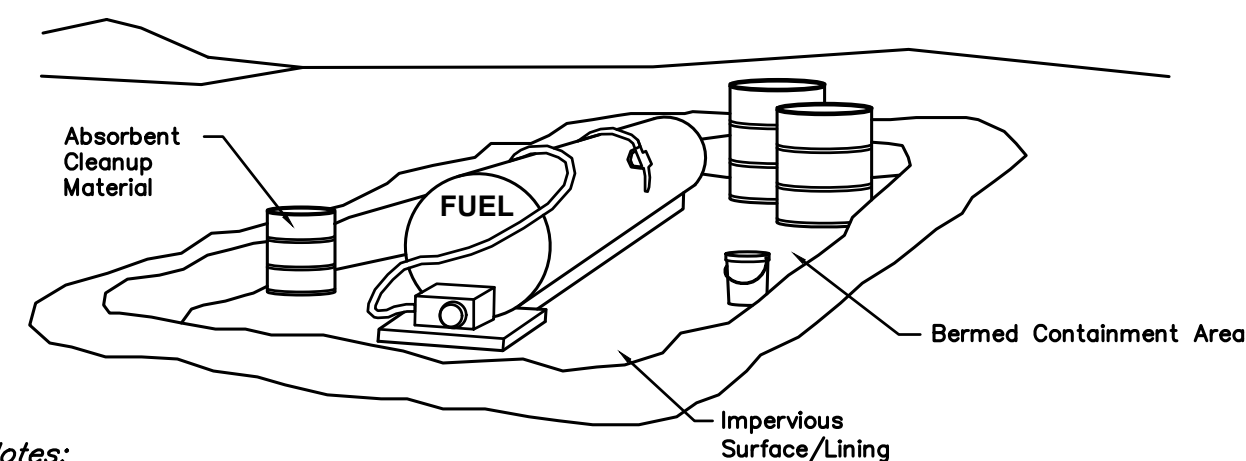

- Notes:
- Fueling shall be performed in a designated area, min. 50' away from drainage courses.
  - Absorbent cleanup material shall be on site and used immediately in the event of a spill.

H Equipment Repair/Maintenance

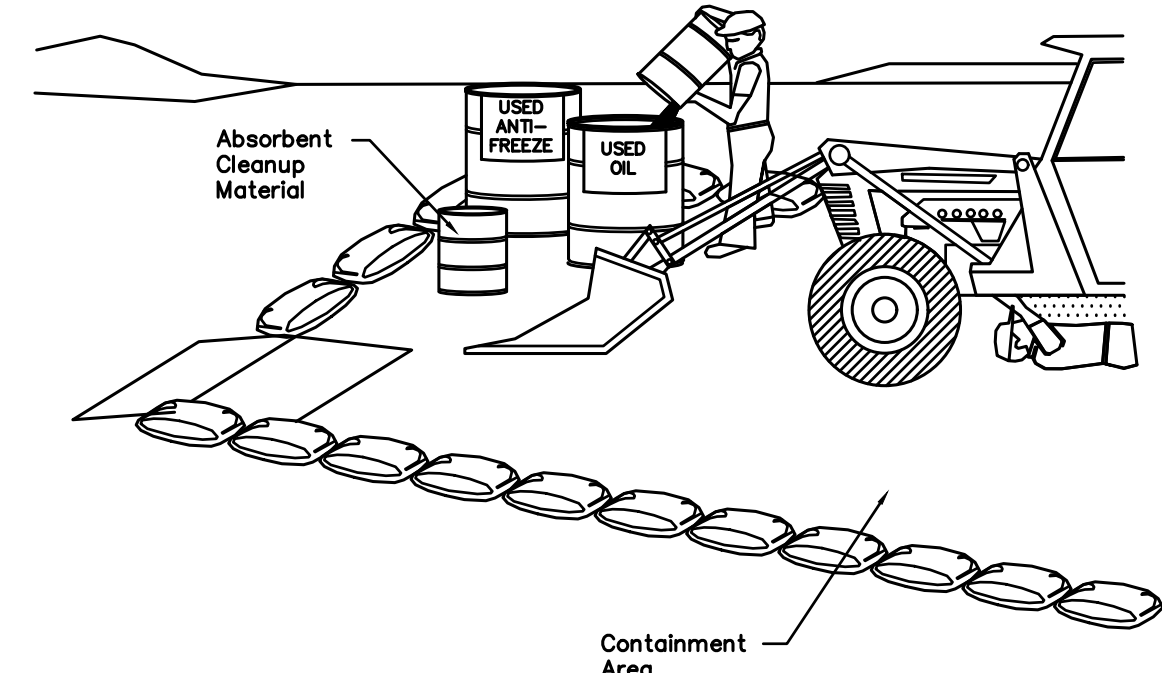


- Notes:
- Leaking vehicles and equipment shall not be allowed on-site. Equipment and vehicles shall be inspected frequently for leaks and shall be repaired immediately. Clean up spills and leaks promptly with absorbent materials; do not flush with water.
  - Vehicles and equipment shall be maintained, and repaired on-site only in designated areas. Prevent run-on and run-off from designated areas. Containment devices shall be provided and areas shall be covered if necessary.
  - Designate on-site vehicle and equipment maintenance areas, min. 50' away from storm drain inlets and watercourses.
  - Always use secondary containment, such as a drain pan or drop cloth, to catch spills and leaks when removing or changing fluids.
  - Legally dispose of used oils, fluids, and lubricants.
  - Provide spill containment dikes or secondary containment around stored oil, fuel, and chemical drums.
  - Maintain an adequate supply of absorbent spill cleanup materials in designated area.



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25 July 2025

A.P. No.: 023-0-120-020

G.P. No.: GP NO

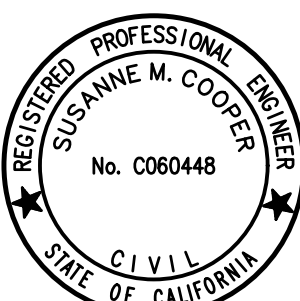EROSION CONTROL PLAN COVER SHEET

OJAI DIGNITY MOVES  
611 SOUTH MONTGOMERY STREET  
OJAI, CA

SHEET 8  
OF 8  
DRAWING NO.  
DWG NO.

REVISION	DESCRIPTION	DATE


sanbell  
1672 DONLON STREET  
VENTURA, CALIF. 93003  
PHONE 805/654-6977  
WEB www.sanbell.com

DESIGNED CE  
DRAWN CE  
APPROVED: CITY OF OJAI  
DATE: \_\_\_\_\_  
BY: \_\_\_\_\_  
MANAGER, DEVELOPMENT & INSPECTION SERVICES

CITY OF OJAI  
PUBLIC WORKS AGENCY

SPEC. NO.  
PROJ. NO.




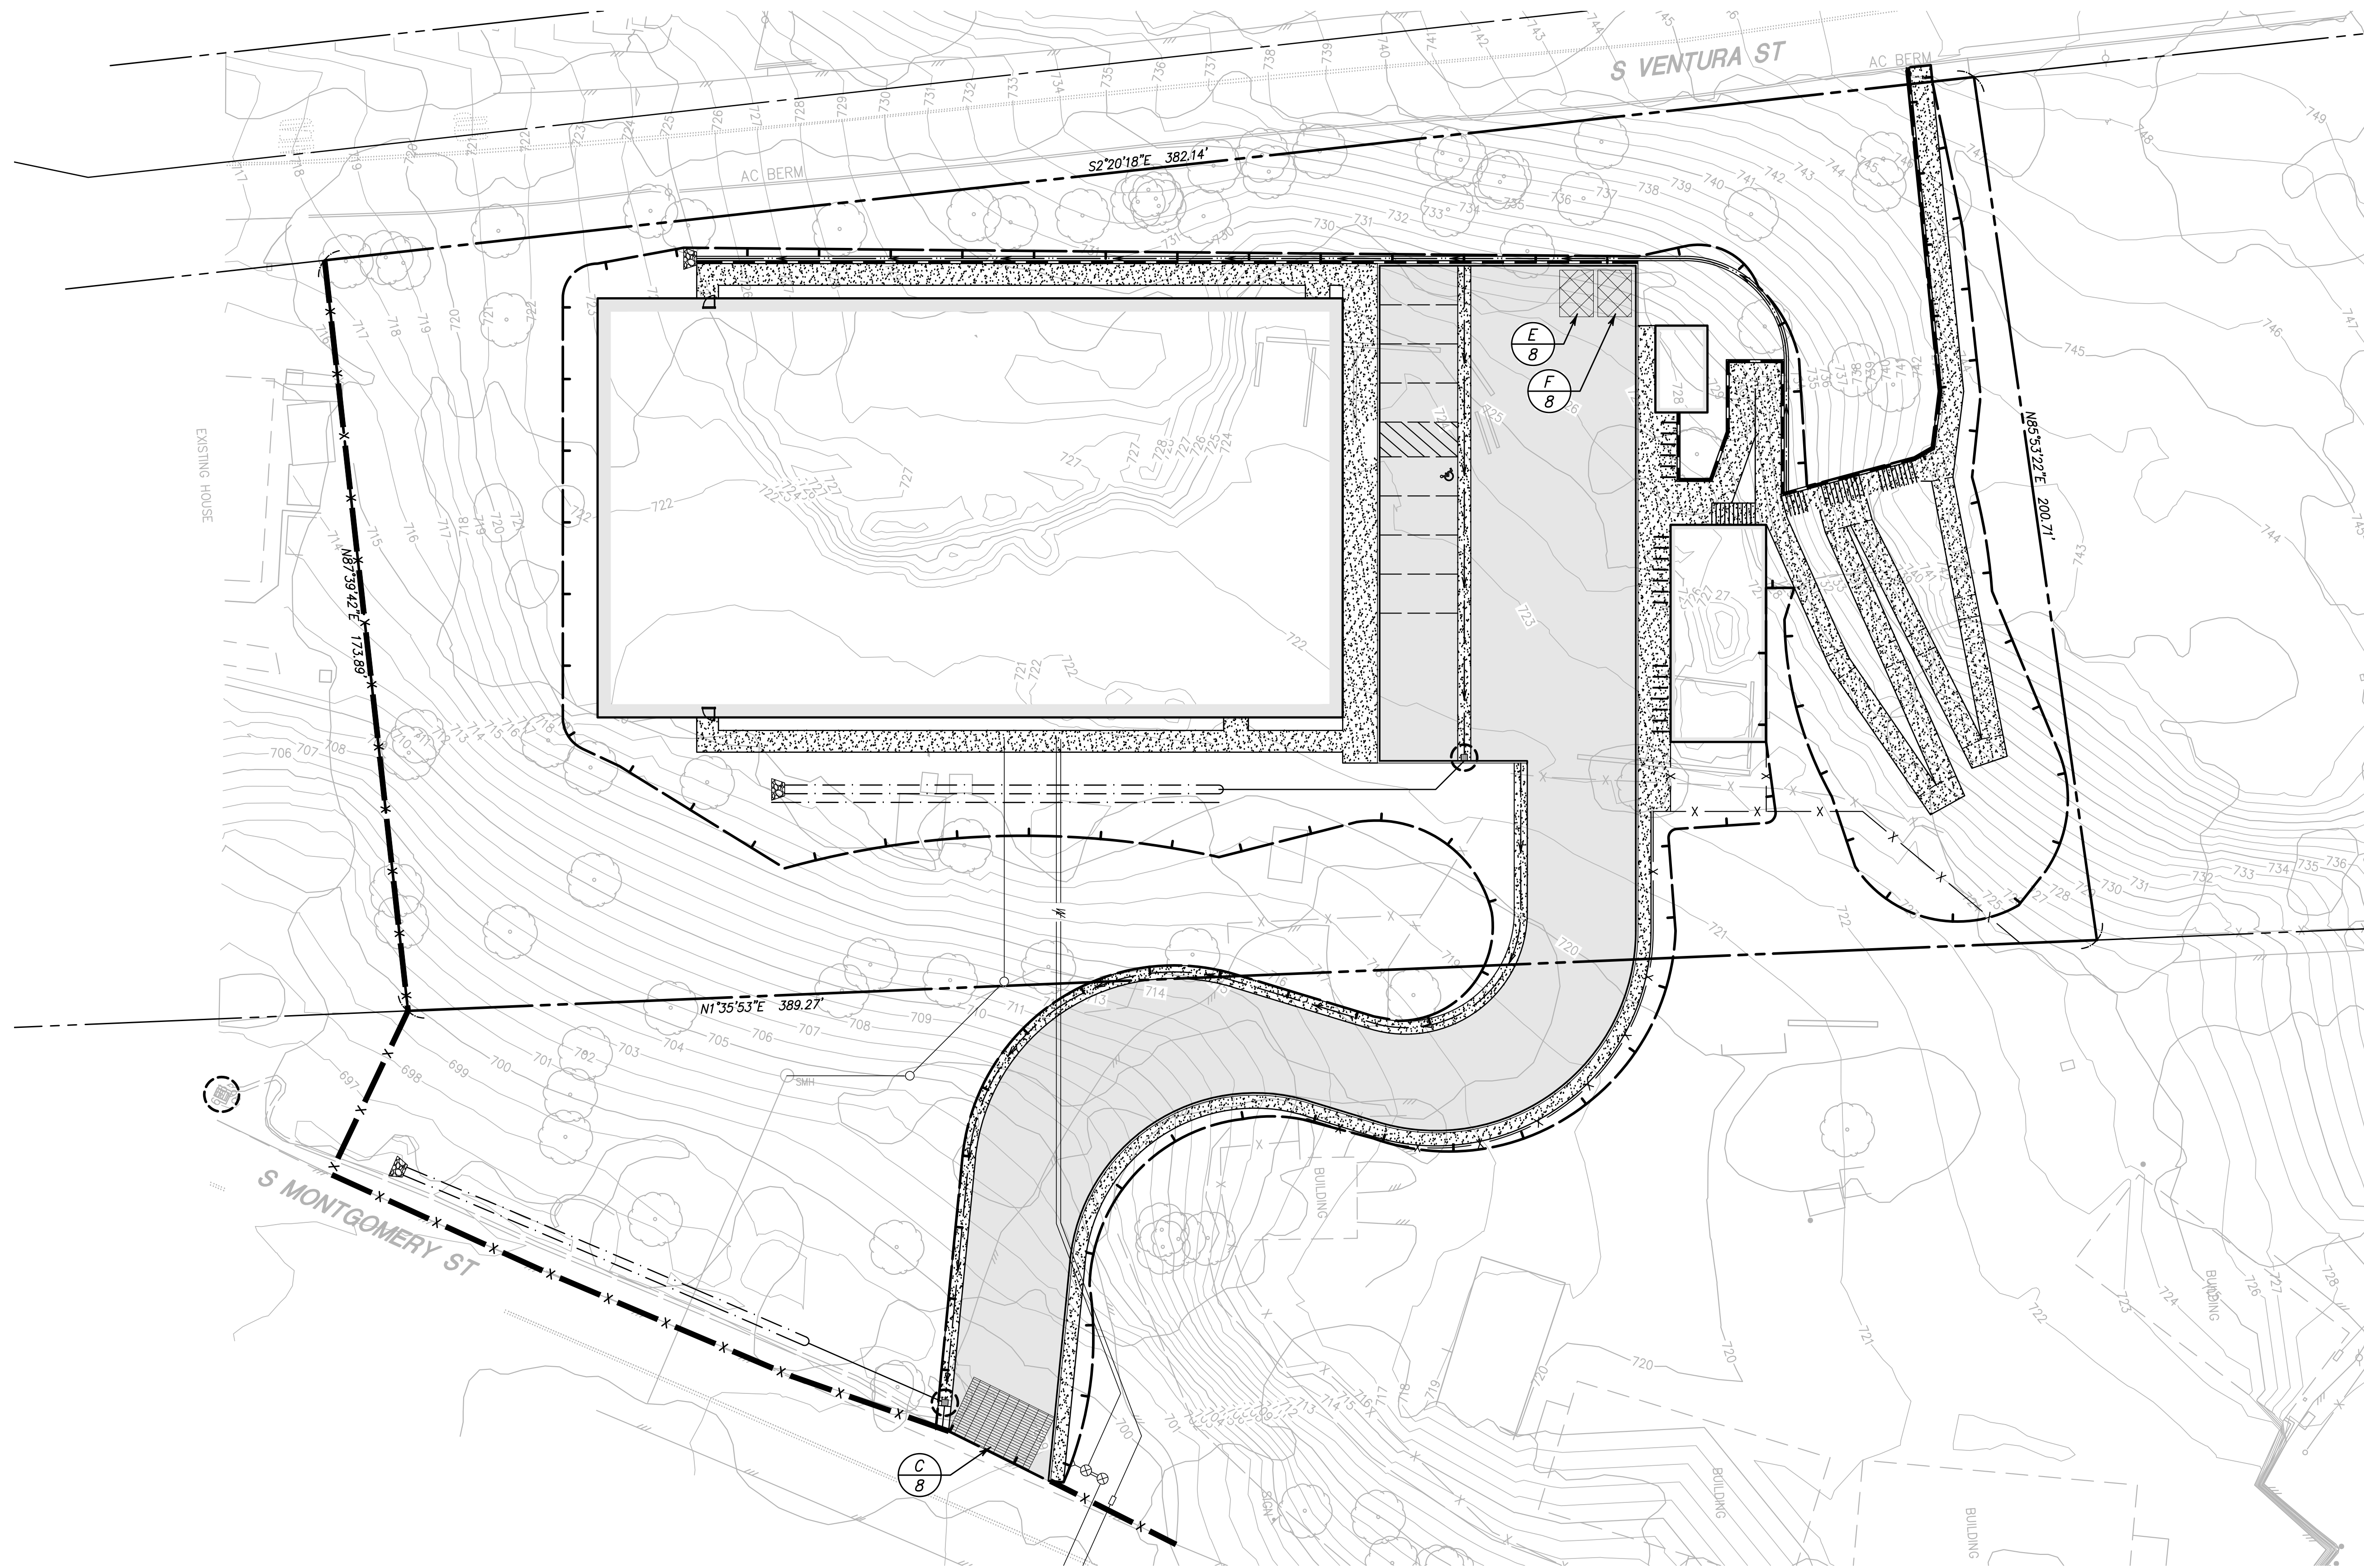

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Design Development  
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25 July 2025

REVISION	DESCRIPTION	DATE
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C		
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1672 DONLON STREET  
VENTURA, CALIF. 93003  
PHONE 805/654-6977  
WEB www.sanbell.com

SUSANNE M. COOPER R.C.E. C060448

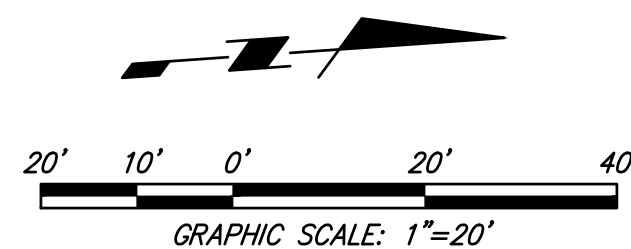DATE

DESIGNED CE DRAWN CE  
APPROVED: CITY OF OJAI  
DATE: \_\_\_\_\_  
BY: \_\_\_\_\_  
MANAGER, DEVELOPMENT & INSPECTION SERVICES

CITY OF OJAI  
PUBLIC WORKS AGENCY

SPEC. NO.
PROJ. NO.

A.P. No.: 023-0-120-020

G.P. No.: GP NO

**EROSION CONTROL PLAN**  
OJAI DIGNITY MOVES  
611 SOUTH MONTGOMERY STREET  
OJAI, CA

SHEET 9  
OF 8  
DRAWING NO.  
DWG NO

Jul 23, 2025

HORIZONTAL CONTROL

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


PROJECT INFORMATION

APPLICANT INFORMATION:  
PROJECT NAME: DIGNITY MOVES - CITY OF OJAI

PROJECT INFORMATION:  
PUBLIC WORKS YARD, 611 SOUTH MONTGOMERY ST., OJAI CA 93023  
APN: 023-0-120-020  
ZONING: P-L ZONING  
PROJECT TYPE: RESIDENTIAL

TOTAL LANDSCAPE AREA: 54,276 SF  
TOTAL IRRIGATED LANDSCAPE AREA: 9,999 SF  
TOTAL NON-IRRIGATED LANDSCAPE AREA: 43973 SF  
TOTAL SPECIAL LANDSCAPE AREA: 304 SF



MWELO PROJECT INFORMATION

Model Water Efficient Landscape Ordinance

Applicant Information

Name

KATHLEEN NOLAN / STUDIO LANDSCAPE CORP.

Phone

805-646-8334

Address

340 AVENIDA DE LA VEREDA, OJAI, CA. 93023

Email

kn@studio-landscape.com

Project

Site Address

PUBLIC WORKS YARD 611 SOUTH MONTGOMERY ST, OJAI, CA. 93023

Project Type (new dwelling, commercial, etc.)

RESIDENTIAL NEW DWELLING

☒ Currently, this project does not include landscaping. (I am aware that future landscape installations may be required to comply with the Model Water Efficient Landscape Ordinance (MWELO) requirements per California Code of Regulations, Title 23, Division 2, Chapter 2.7.

☒ This project does incorporate landscaping. (Please provide the information below specific to the landscape area which will be completed as part of this project and specify the compliance method to be used):

Total Landscape Area (sq. ft.)

54,276

Turf Area (sq. ft.)

1,223 SF

Non-Turf Plant Area (sq. ft.)

52,749

Special Landscape Area (sq. ft.)

304 SF

Water Type (potable, recycled, well)

POTABLE

Name of water purveyor (if not served by private well)

CASITAS MUNICIPAL WATER DISTRICT

Compliance Method

☒ Performance (Items included in Performance Checklist is included on plans)

☐ Prescriptive (Items included in Prescriptive Checklist is included on plans)

Signature

certify the above information is correct and agree to comply with the requirements of the MWELO.

07/10/2025

Signature of property owner or authorized representative

Date

611 South Montgomery Street - Ojai, CA 93023

023-0-120-020

Public Works Yard

DIG ALERT  
**811 DIG ALERT** CALL BEFORE YOU DIG  
<http://california811.org>  
UNDERGROUND SERVICE ALERT  
9 THINGS TO REMEMBER

1. DELINEATE THE SITE. IT'S MANDATORY THAT YOU OUTLINE THE PROPOSED EXCAVATION SITE WITH WHITE PAINT OR STAKES.
2. DIAL BEFORE YOU DIG. IT'S THE LAW. NO MATTER WHAT SIZE JOB YOU PLAN, CALL BEFORE YOU EXCAVATE. THE LAW PROVIDES PENALTIES FOR THOSE WHO DO NOT COMPLY.
3. CALL AT LEAST TWO WORKING DAYS BEFORE. YOU MAY CALL 14 DAYS PRIOR TO EXCAVATION. BUT DON'T WAIT UNTIL THE LAST MINUTE!
4. YOU'RE RESPONSIBLE FOR DAMAGE. IF DAMAGE TO UNDERGROUND UTILITIES RESULTS FROM YOUR DIGGING, YOU MAY BE CHARGED THE COST OF REPAIRING IT - PLUS A FINE.
5. MAKE ONLY ONE CALL. THAT'S ALL IT TAKES TO HAVE ALL UNDERGROUND LINES ON YOUR SITE LOCATED AND MARKED BEFORE YOU DIG.
6. THE CALL COSTS YOU NOTHING. THERE'S NO CHARGE TO CALL THE TOLL-FREE 800 NUMBER.
7. CALLING SAVES TIME. THE DIGALERT PROCESS HELPS EXPEDITE YOUR PROJECT BY ELIMINATING ANY SEARCHING FOR UNDERGROUND UTILITIES.
8. EVERYONE SHOULD CALL - NOT JUST PROFESSIONALS. CALLING IS JUST AS IMPORTANT FOR PROPERTY OWNERS AS IT IS FOR PLUMBERS, ELECTRICIANS, CONTRACTORS, LANDSCAPERS, SWIMMING POOL BUILDERS OR ANYONE ELSE.
9. YOUR PERMIT IS NOT VALID WITHOUT A DIGALERT NUMBER. AN EXCAVATION PERMIT DOESN'T MEAN YOU'RE FREE OF RESPONSIBILITY FOR DAMAGE TO UNDERGROUND UTILITIES. MAKE SURE YOU OBTAIN AN UNDERGROUND SERVICE ALERT/DIGALERT NUMBER BY CALLING.

TREE PERMIT (T 25-XXX)

SEE ARBORIST REPORT & TREE PROTECTION PLAN FOR REQUIREMENTS.

SHEET INDEX

- L-0 TITLE SHEET
- L-1 EXISTING CONDITIONS & DEMO PLAN
- L-2 LANDSCAPE SITE PLAN
- L-3 LANDSCAPE SITE PLAN
- L-4 PLANTING DETAILS
- L-5 IRRIGATION CONCEPT PLAN
- L-6 IRRIGATION DETAILS
- L-7 IRRIGATION DETAILS
- L-8 LANDSCAPE MATERIALS & IMAGERY
- L-9 LANDSCAPE LIGHTING PLAN
- L-10 LANDSCAPE LIGHTING PLAN
- L-11 LANDSCAPE LIGHTING SPECIFICATIONS
- L-12 TREE PROTECTION PLAN
- L-13 TREE PROTECTION PLAN

DEFENSIBLE SPACE ZONES

- ZONE 0 (0-5' FROM STRUCTURE)
- ZONE 1 (5-30' FROM STRUCTURE)
- ZONE 2 (30-100' FROM STRUCTURE)

PROJECT CONTACT LIST

OWNER APPLICANT  
CITY OF OJAI  
LUCAS SEIBERT  
COMMUNITY DEVELOPMENT DIRECTOR  
805.646.5581  
lucas.seibert@ojai.ca.gov

DEVELOPER  
DIGNITY MOVES  
MAUREEN BOYER  
VP OF INNOVATIVE DESIGN  
415.246.3510  
maureen@dignitymoves.org

LANDSCAPE ARCHITECT  
STUDIO LANDSCAPE CORPORATION  
KATHLEEN NOLAN, PLA, ASLA  
805.646.8384  
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DJA ARCHITECS, PLLC  
DYLAN JOHNSON, AIA  
206.459.7027  
dylan@djaarchitects.com

CIVIL ENGINEER  
SANBELL  
SUSAN COOPER, PE  
1672 DONLON ST.  
VENTURA, CA. 93003  
808.633.2225  
scooper@jdcivil.com

LOCATION MAP

GENERAL NOTE:

PROJECT TO BE BID **"IN ACCORDANCE WITH CALIFORNIA PUBLIC CONTRACT CODE SECTIONS 22030-22045 AND OJAI MUNICIPAL CODE CHAPTER 8-4"**  
PRODUCT SPECIFICATIONS WILL NEED TO ACCOMMODATE COMPETITIVE BIDDING AND SUBSTITUTIONS ACCORDINGLY.

C:\Users\Keith\Dropbox\studio-landscape\Clients\2025\Dignity Moves 25-01 DM\CAD\CD\L-Title Sheet.dwg

**STUDIO LANDSCAPE CORPORATION**  
KATHLEEN NOLAN, PLA, ASLA  
340 Avenida de la Vereda  
Ojai, CA 93023  
tel: 805.646.8384  
email: kn@studio-landscape.com  
www.studio-landscape.com

**DIGNITY MOVES**  
OJAI PERMANENT SUPPORTIVE HOUSING  
PUBLIC WORKS YARD  
611 S. MONTGOMERY ST, OJAI, CA. 93023  
APN # 023-0-120-020

TITLE SHEET

REVISIONS	
NAME	DATE

PHASE  
DESIGN  
DEVELOPMENT

NOT FOR CONSTRUCTION

JOB NUMBER: 25-01 DM  
ORIGIN DATE 12.23.24  
PLOT DATE 07.25.25  
DRAWN BY: KD  
CHECKED BY: KN

SHEET 1 OF 14

L-0

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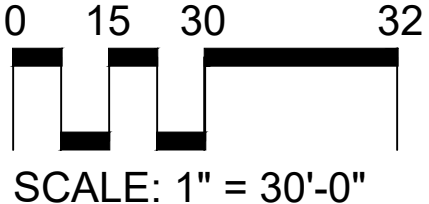
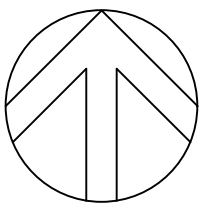
SURVEY INFORMATION:  
HENRY LAND SURVEYING, INC.  
619 CRESTVIEW DRIVE  
OJAI, CA 93023  
(805) 216-6124  
09/17/2024

DEMOLITION KEY NOTES:

- 1 REMOVE BRUSH & WEEDS (SMILO GRASS, MUSTARD, THISTLE SPECIES)  
BARB WIRE FENCING (LEAVE OR REMOVE)
- 3 REMOVE ASPHALT
- 4 NON-PROTECTED MISCELLANEOUS SHRUBS (PRIVET, OLEANDER)
- 5 NON PROTECTED MISCELLANEOUS TREES
- 6 ALL PUBLIC WORKS STORED MATERIALS, EQUIPMENT, WASTE
- 7 MISCELLANEOUS SITE DEBRIS

PROTECT KEY NOTES:

- 1 EXISITNG OAKS, SEE ARBORIST REPORT
- 2 EXISTING CHAIN LINK FENCING
- 3 EXISTING UTILITIES (NOT SHOWN)



DESIGN DEVELOPMENT, NOT FOR CONSTRUCTION

EXISTING  
CONDITIONS  
PLAN

REVISIONS	
NAME	DATE

PHASE  
DESIGN  
DEVELOPMENT  
NOT FOR CONSTRUCTION

JOB NUMBER: 25-01 DM  
ORIGIN DATE 12.23.24  
PLOT DATE 07.25.25  
DRAWN BY: KD  
CHECKED BY: KN  
SHEET 2 OF 14


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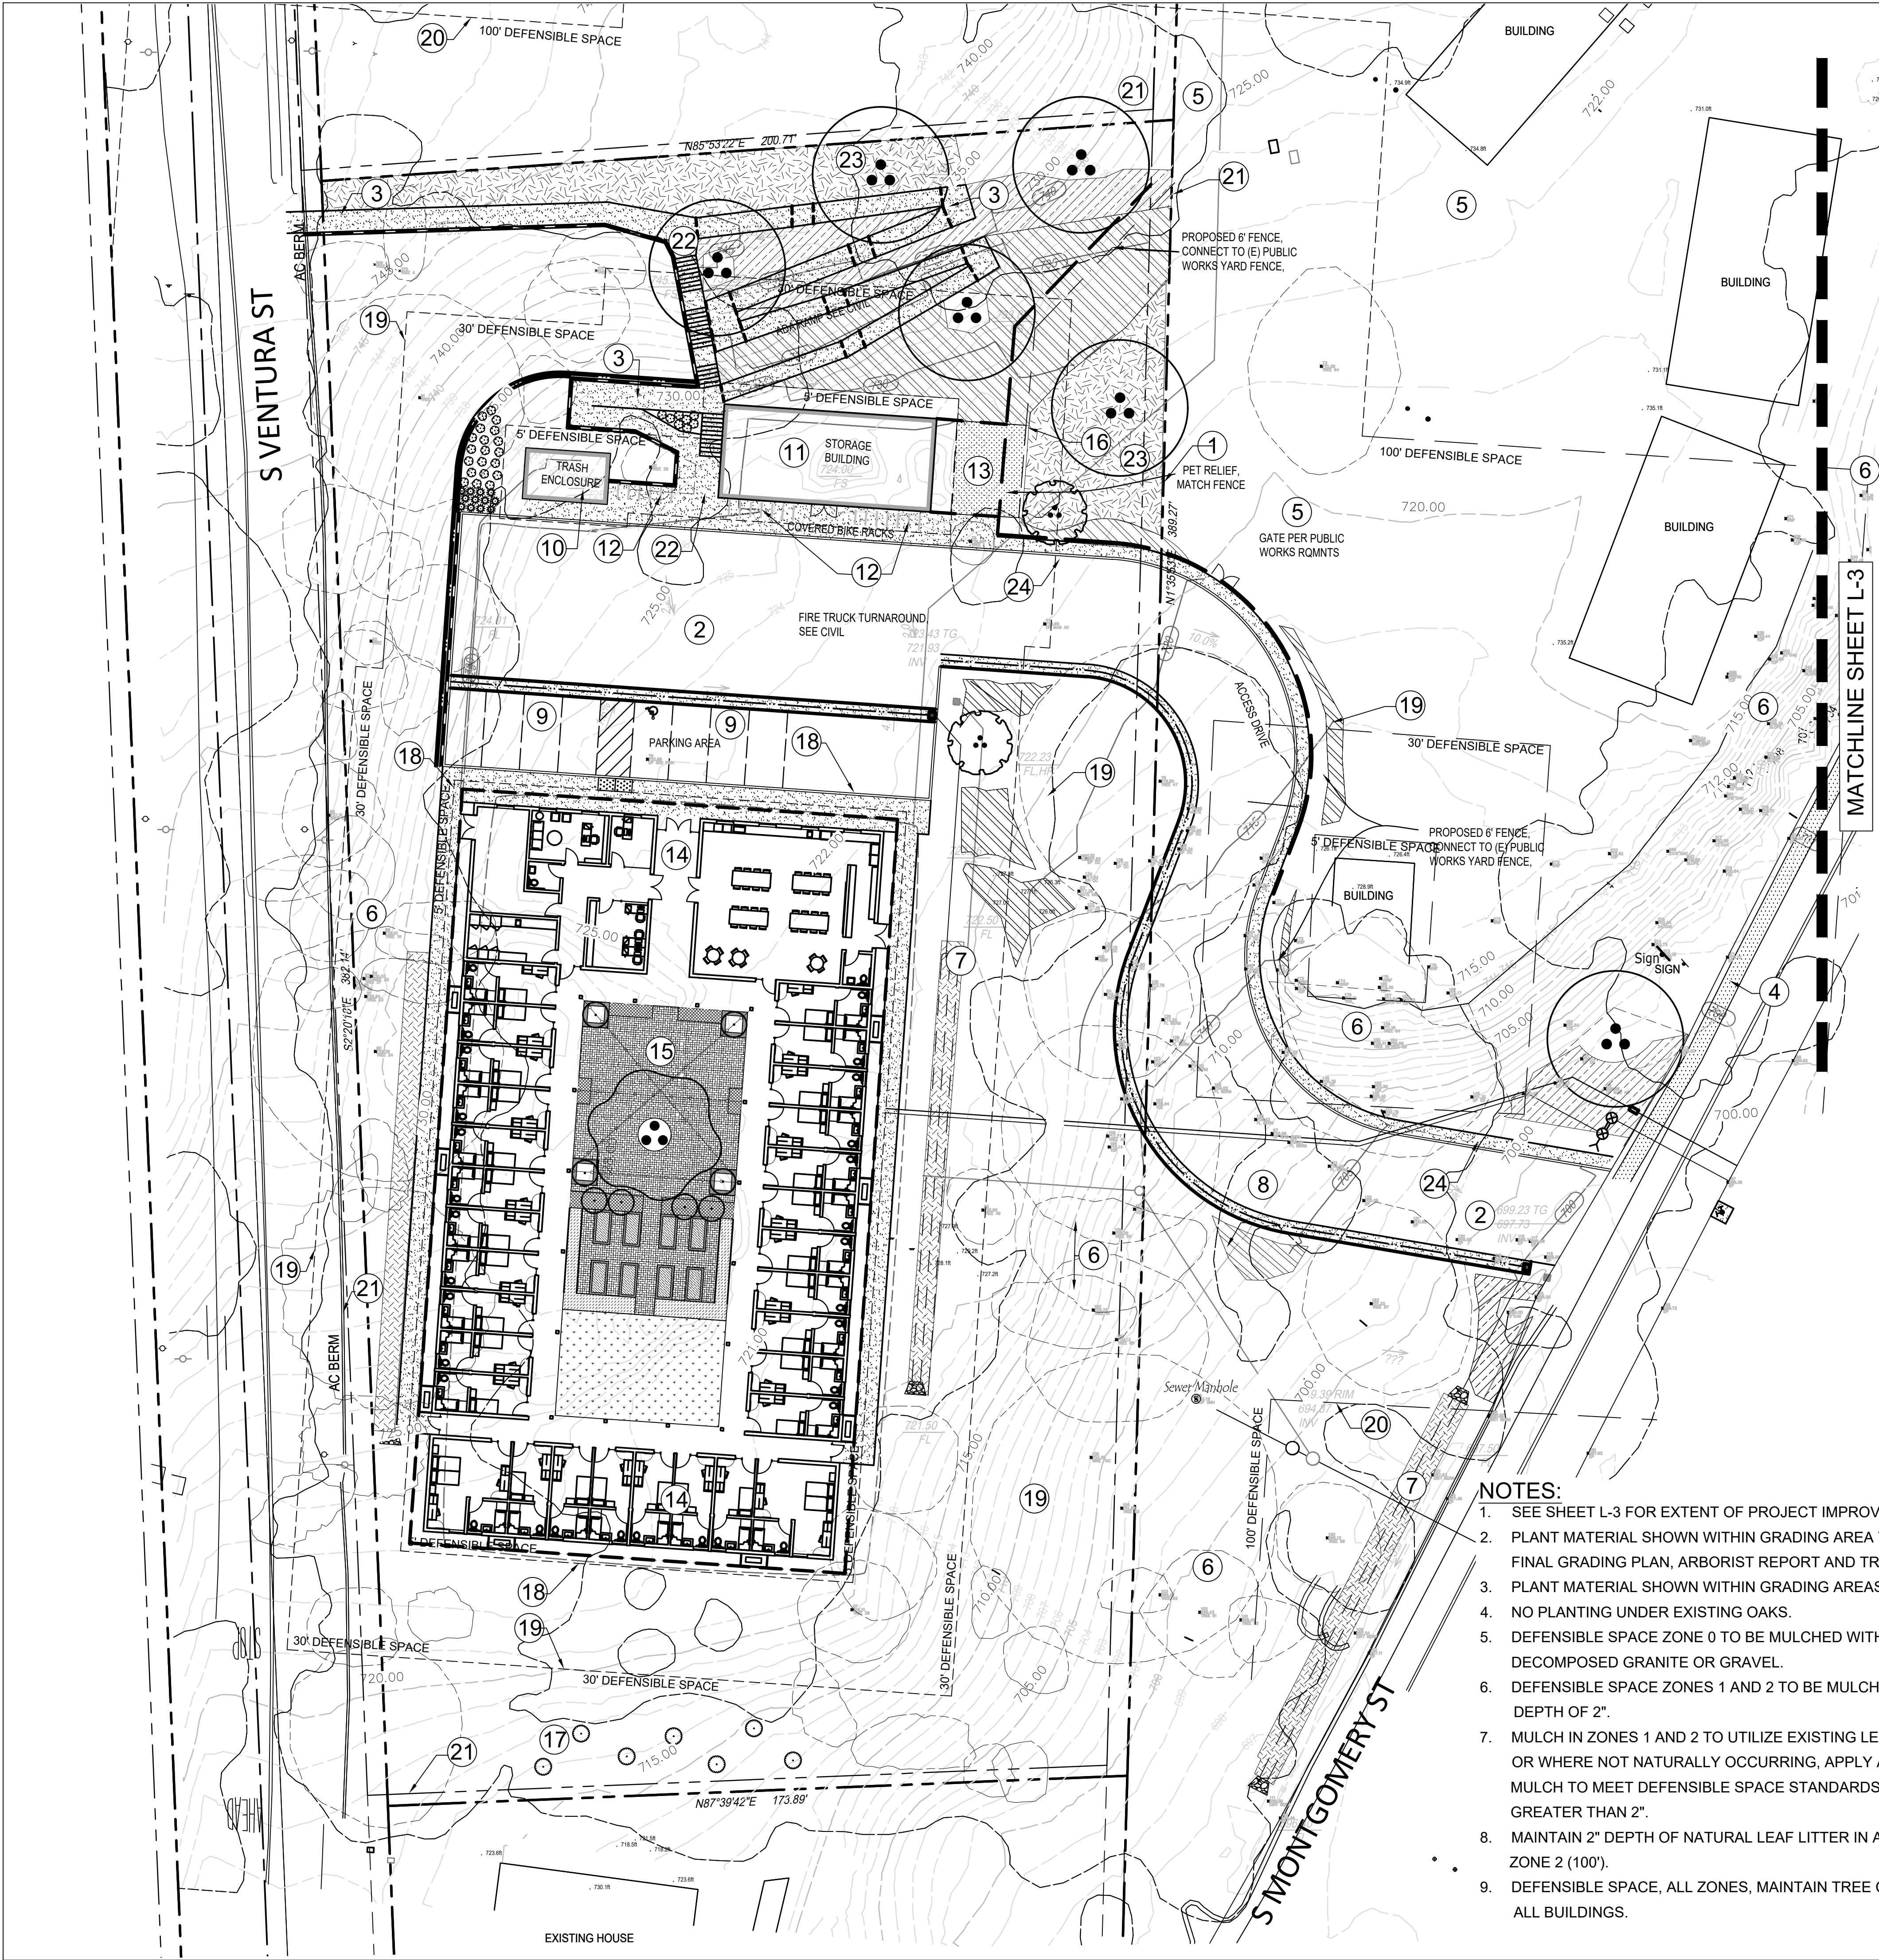
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SITE PLAN KEY NOTES:



- 1 PROJECT PARCEL
- 2 PROJECT ASPHALT ENTRY DRIVE
- 3 ADA RAMP
- 4 PERMEABLE DECOMPOSED GRANITE SIDEWALK (SITE TO OJAI VALLEY TRAIL)
- 5 PUBLIC WORKS YARD
- 6 PROTECTED OAK WOODLAND
- 7 BIOSWALE, INFILTRATION AREA
- 8 CHANNELED DRAINAGE
- 9 PARKING, INCLUDING ADA REQUIREMENTS
- 10 TRASH ENCLOSURE
- 11 STORAGE SHED
- 12 BICYCLE PARKING, COVERED AND UNCOVERED
- 13 PET RELIEF AREA
- 14 RESIDENTIAL BUILDING
- 15 INTERIOR COURTYARD, SEE SHEET L-4
- 16 NEW METAL FENCE, MATTE BRONZE FINISH, 6' HEIGHT, TIE INTO EXISTING FENCING
- 17 NATIVE SHRUB/TREES AND SCREENING, TYPICAL SYMBOL
- 18 DEFENSIBLE SPACE ZONE 0 PLANTING, TYPICAL SYMBOL
- 19 DEFENSIBLE SPACE ZONE 1 SHRUB AREA, TYPICAL SYMBOL
- 20 DEFENSIBLE SPACE ZONE 2 SHRUB AREA, TYPICAL SYMBOL
- 21 EXISTING FENCING
- 22 NEW CONCRETE PEDESTRIAN ACCESS STAIR CASE AND WALK
- 23 MULCH PER FIRE CODE SPECIFICATIONS OR NATURAL LEAF LITTER NOT TO EXCEED 2" DEPTH
- 24 NEW CONCRETE SIDEWALK

CONCEPT PLANT SCHEDULE

	COURTYARD SHADE TREE EVERGREEN, LOW WATER USE, NON-FRUITING, MODERATE SIZE AND GROWTH OLEA EUROPAEA 'SWAN HILL' / SWAN HILL FRUITLESS OLIVE	1
	COURTYARD DWARF CITRUS IN RAISED PLANTERS CITRUS RETICULATA 'SATSUMA' / SATSUMA TANGERINE CITRUS X LATIFOLIA DWARF BEARSS SEEDLESS / DWARF BEARSS SEEDLESS LIME CITRUS X LIMON 'DWARF EUREKA' / DWARF EUREKA LEMON CITRUS X SINENSIS 'CARA CARA' / CARA CARA PINK NAVEL ORANGE	16
	ACCENT TREES CERCIS OCCIDENTALIS / WESTERN REDBUD	4
	MITIGATION TREES 2" DIAMETER EQUIVALENT OR GREATER, 60" BOX @ \$6,000/00TREE QUERCUS AGRIFOLIA / COAST LIVE OAK MULTI-TRUNK	8
	BUILDING FACADE LOW SHRUB PER FIRE CODE, SPACE 4' APART MIMULUS X 'JELLY BEAN ORANGE' / JELLY BEAN ORANGE MONKEYFLOWER	28
	BUILDING FACADE GROUNDCOVER PER FIRE CODE, SPACE 1' APART DUDLEYA VIRENS HASSEI / CATALINA ISLAND LIVE-FOR-EVER	12
	HERB BED PLANT SELECTION PER RESIDENTS	512 SF
	RAISED BEDS VEGETABLES, FLOWERS, PERENNIALS PER RESIDENTS	336 SF
	COURTYARD LOW SHRUB BORDER MYRTUS COMPACTA / COMPACT MYRTLE	460 SF
	ZONE 1 BIOSWALE/RAINGARDEN ACHILLEA MILEFOLIUM / COMMON YARROW ARTEMISIA DOUGLASIANA / MUGWORT ELYMUS TRITICOIDES / CREEPING WILD RYE JUNCUS TEXTILIS / BASKET RUSH STACHYS BULLATA / HEDGE NETTLE	3,025 SF
	ZONE 1 MAX. HEIGHT 12". GROUPINGS SHALL NOT EXCEED 200 SQ. FT. SPACING = 2'-0" BACCHARIS PILLULARIS 'PIGEON POINT' / PIGEON POINT COYOTE BRUSH ZAUSSCHNERIA CALIFORNICA / CALIFORNIA FUCHSIA	9,083 SF
	ZONE 2 4'-0" SPACE MAX. HEIGHT. GROUPINGS SHALL NOT EXCEED 50 SQ. FT. SPACING = 4'-0" SALVIA X 'BEE'S BLISS' / BEE'S BLISS SAGE	4,066 SF
	LAWN FESTUCA X ORIGINAL MARATHON / ORIGINAL MARATHON	1,924 SF
	PET RELIEF MODERATE WATER USE LAWN FESTUCA X ORIGINAL MARATHON / ORIGINAL MARATHON	353 SF

NOTES:

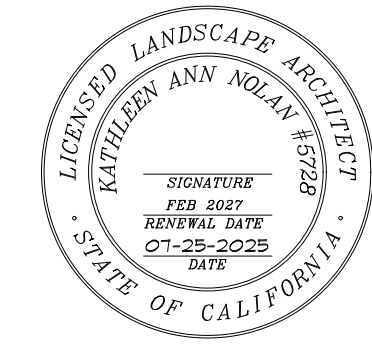- 1. SEE SHEET L-3 FOR EXTENT OF PROJECT IMPROVEMENTS.
- 2. PLANT MATERIAL SHOWN WITHIN GRADING AREA TO BE MODIFIED WITH FINAL GRADING PLAN, ARBORIST REPORT AND TREE PROTECTION PLAN.
- 3. PLANT MATERIAL SHOWN WITHIN GRADING AREAS IS DIAGRAMMATIC.
- 4. NO PLANTING UNDER EXISTING OAKS.
- 5. DEFENSIBLE SPACE ZONE 0 TO BE MULCHED WITH UNSTABILIZED DECOMPOSED GRANITE OR GRAVEL.
- 6. DEFENSIBLE SPACE ZONES 1 AND 2 TO BE MULCHED TO A MAXIMUM DEPTH OF 2".
- 7. MULCH IN ZONES 1 AND 2 TO UTILIZE EXISTING LEAF LITTER AS MULCH OR WHERE NOT NATURALLY OCCURRING, APPLY APPROVED BARK MULCH TO MEET DEFENSIBLE SPACE STANDARDS AT A DEPTH NO GREATER THAN 2".
- 8. MAINTAIN 2" DEPTH OF NATURAL LEAF LITTER IN ALL AREAS BEYOND ZONE 2 (100').
- 9. DEFENSIBLE SPACE, ALL ZONES, MAINTAIN TREE CANOPIES 10' FROM ALL BUILDINGS.

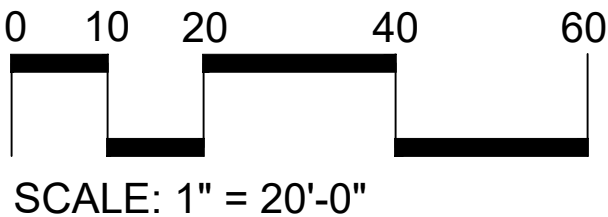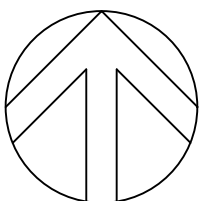

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LANDSCAPE  
SITE PLAN


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NAME	DATE

PHASE  
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SHEET	3 OF 14


L-2



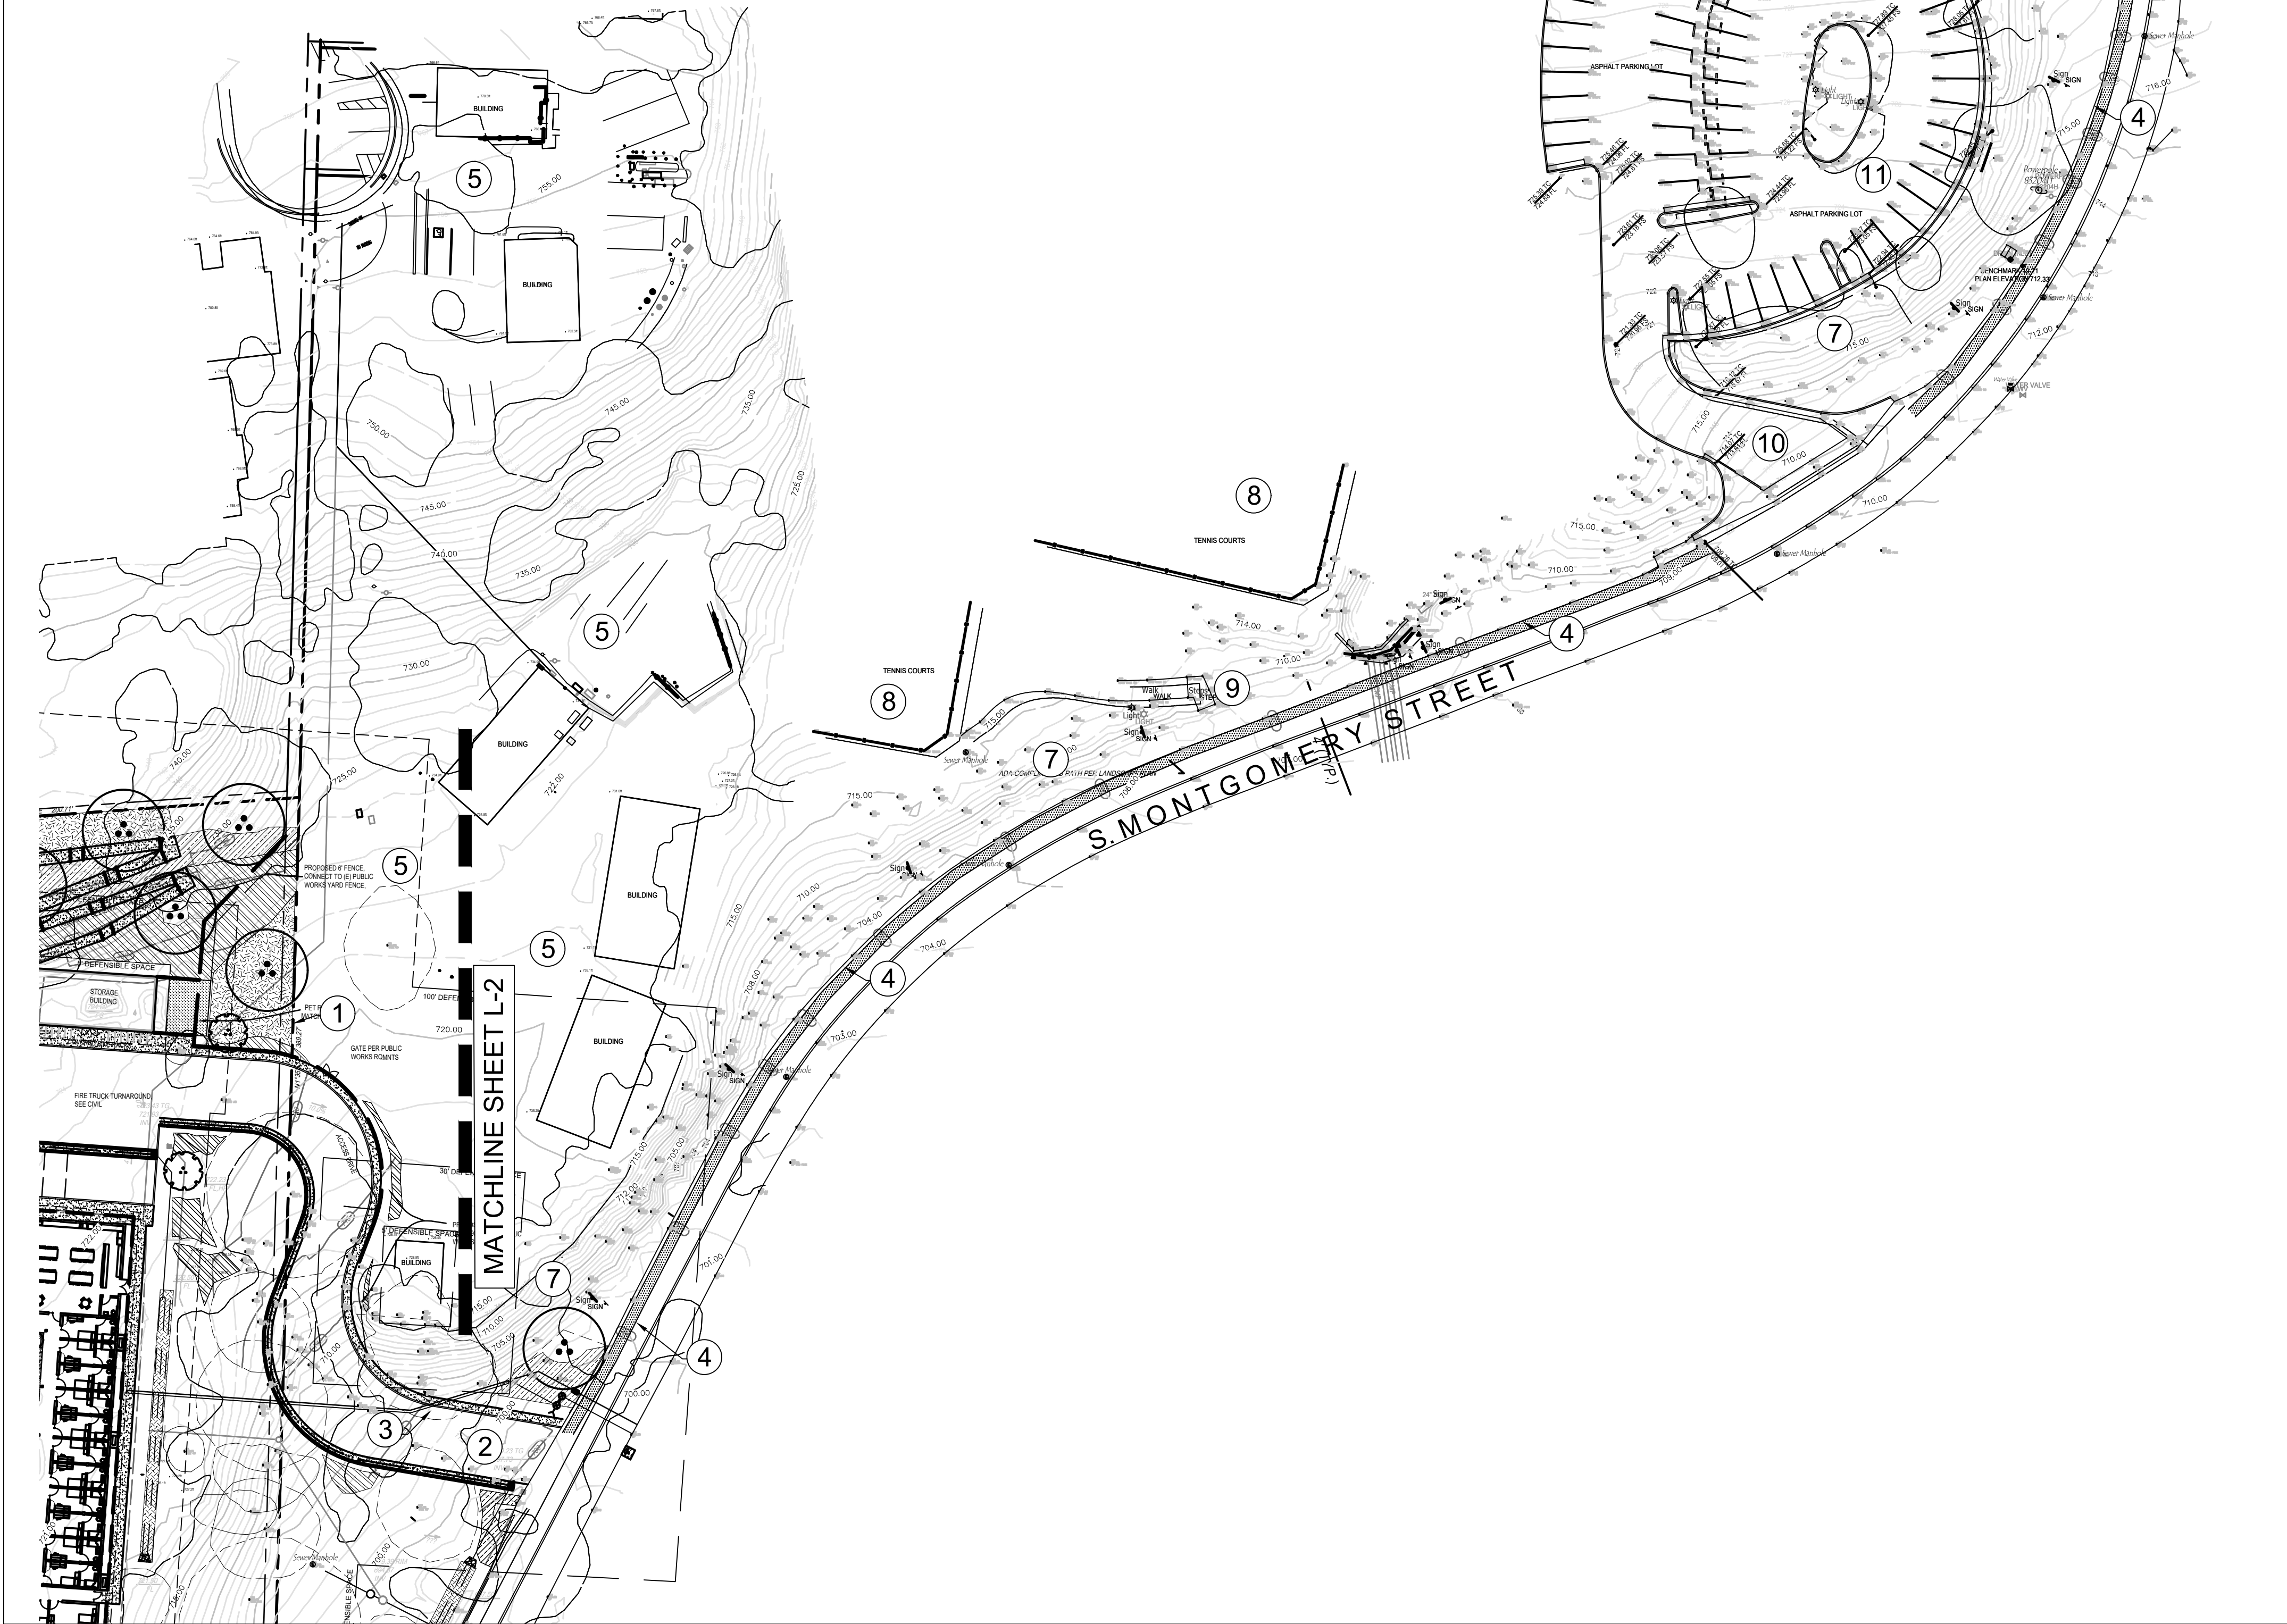

- SITE PLAN KEY NOTES:**
- ① PROJECT PARCEL
  - ② PROJECT ENTRY DRIVE
  - ③ CONCRETE SIDEWALK
  - ④ PERMEABLE DECOMPOSED GRANITE SIDEWALK (SITE TO OJAI VALLEY TRAIL)
  - ⑤ PUBLIC WORKS YARD
  - ⑥ OJAI VALLEY TRAIL
  - ⑦ PROTECTED OAK WOODLAND
  - ⑧ LIBBEY PARK LOWER TENNIS COURTS
  - ⑨ LIBBEY PARK ENTRY STEPS TO LOWER TENNIS COURTS
  - ⑩ ENTRY DRIVE TO LOWER LIBBEY PARK PARKING
  - ⑪ LOWER LIBBEY PARK PARKING

- NOTES:**
- SEE SHEET THIS SHEET I-3 ,FOR EXTENT OF PROJECT IMPROVEMENTS.
  - PLANT MATERIAL SHOWN WITHIN GRADING AREA TO BE MODIFIED WITH FINAL GRADING PLAN, ARBORIST REPORT AND TREE PROTECTION PLAN.
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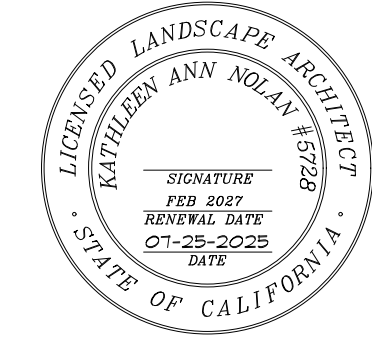
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L-3	
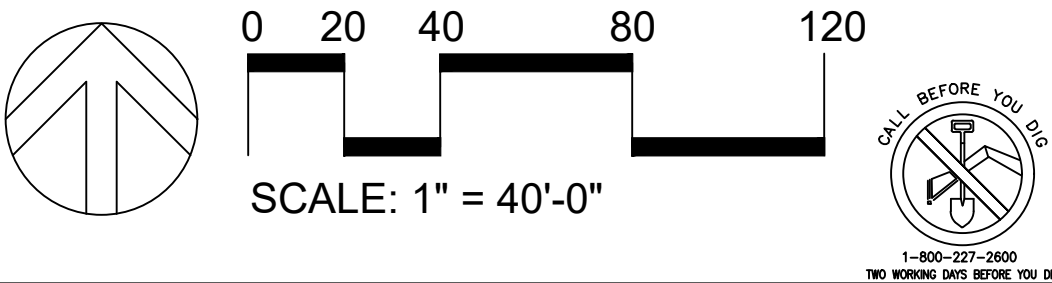
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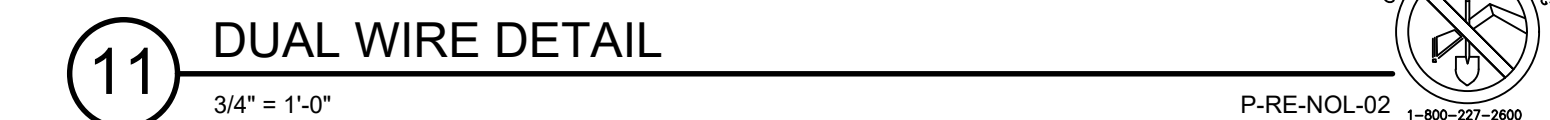
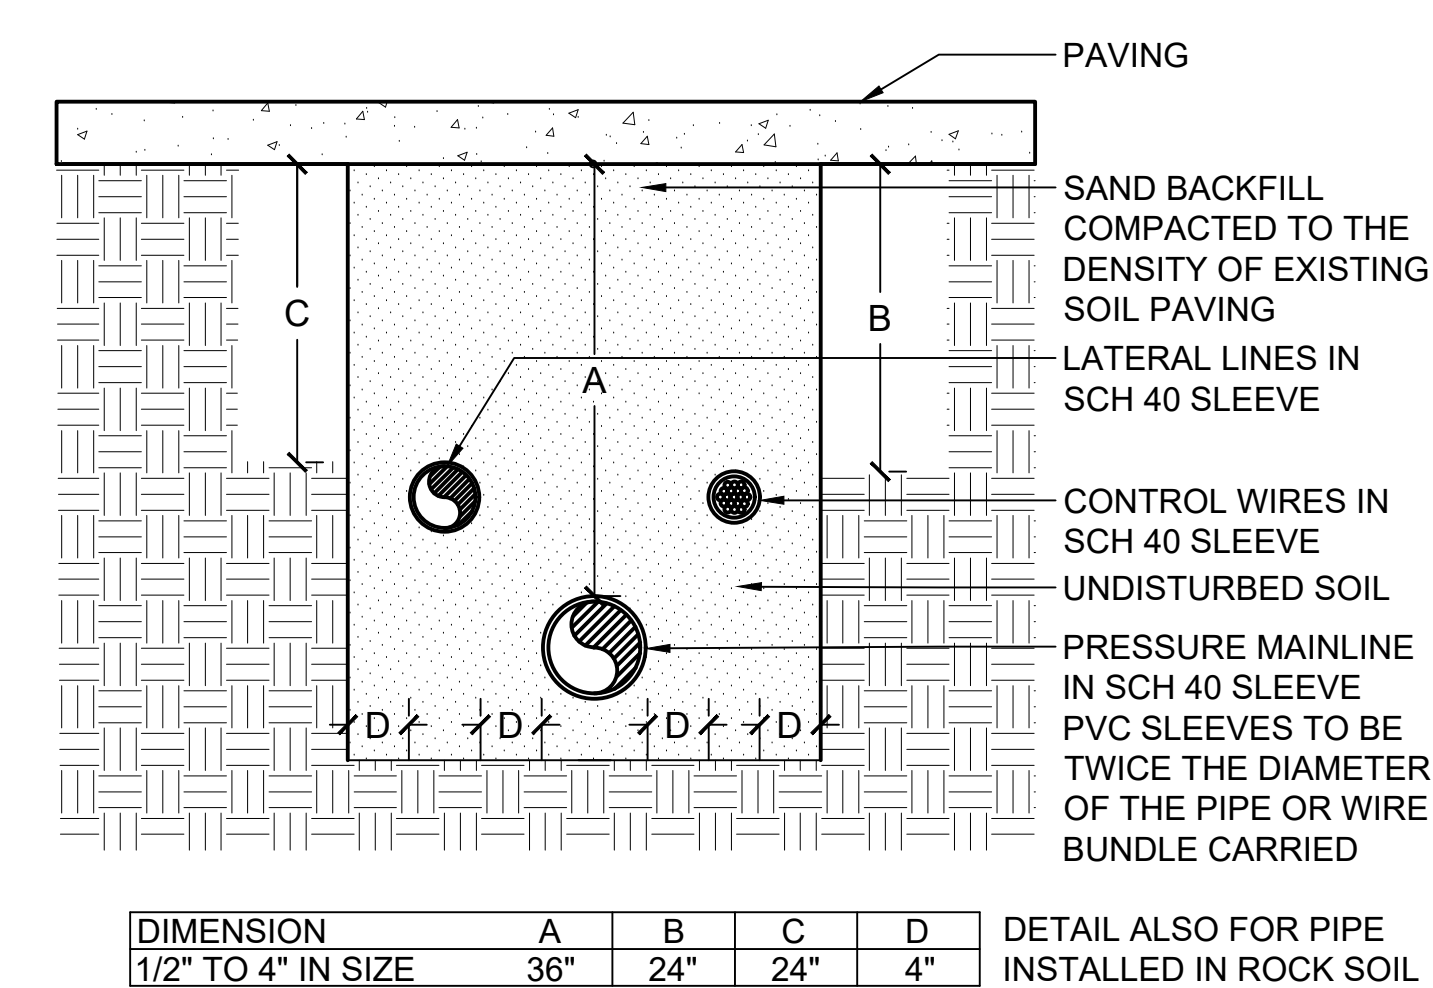
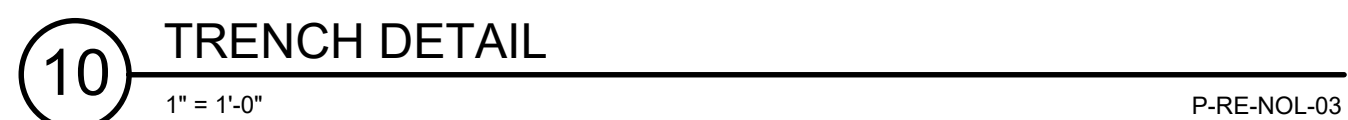
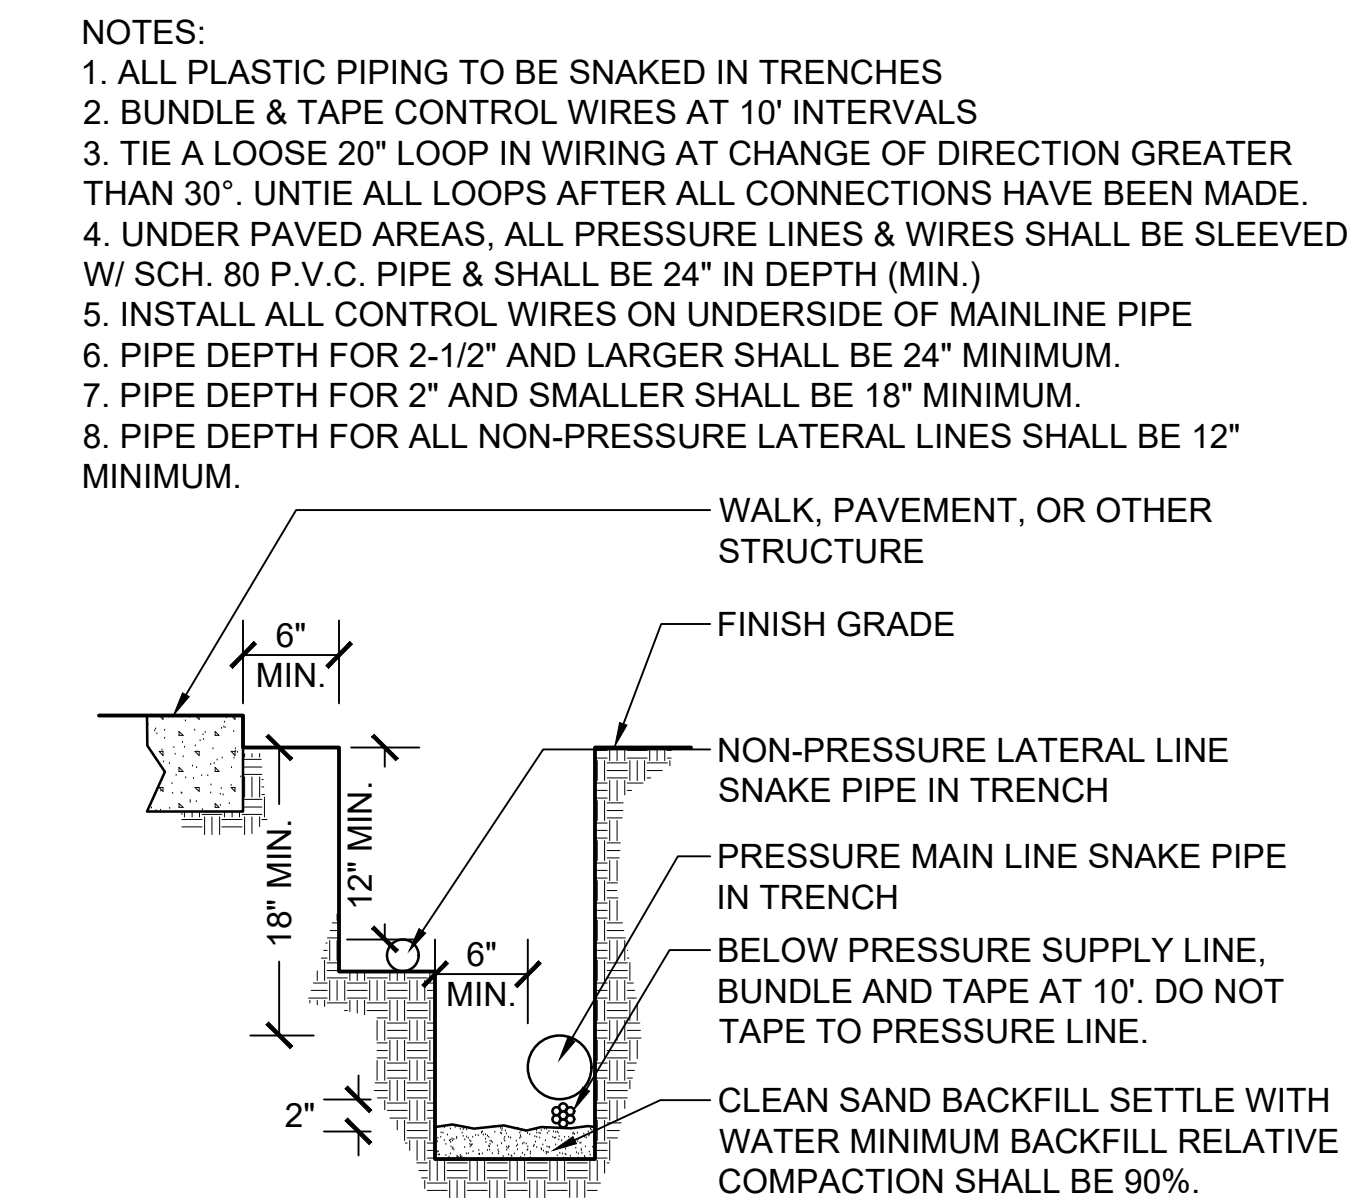
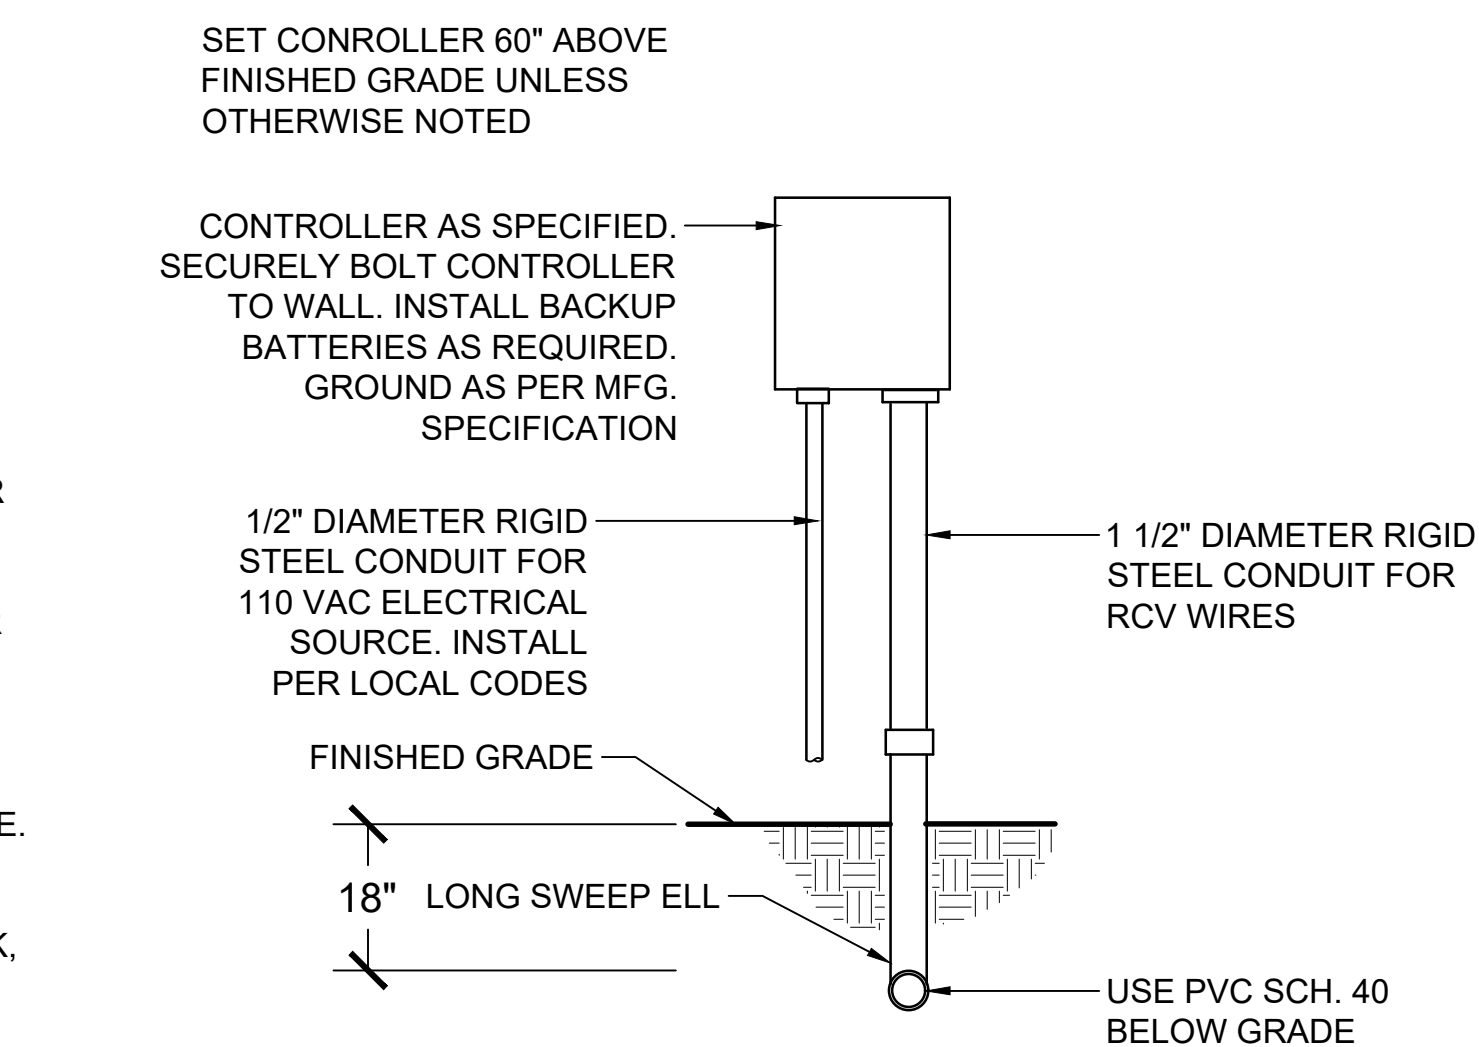
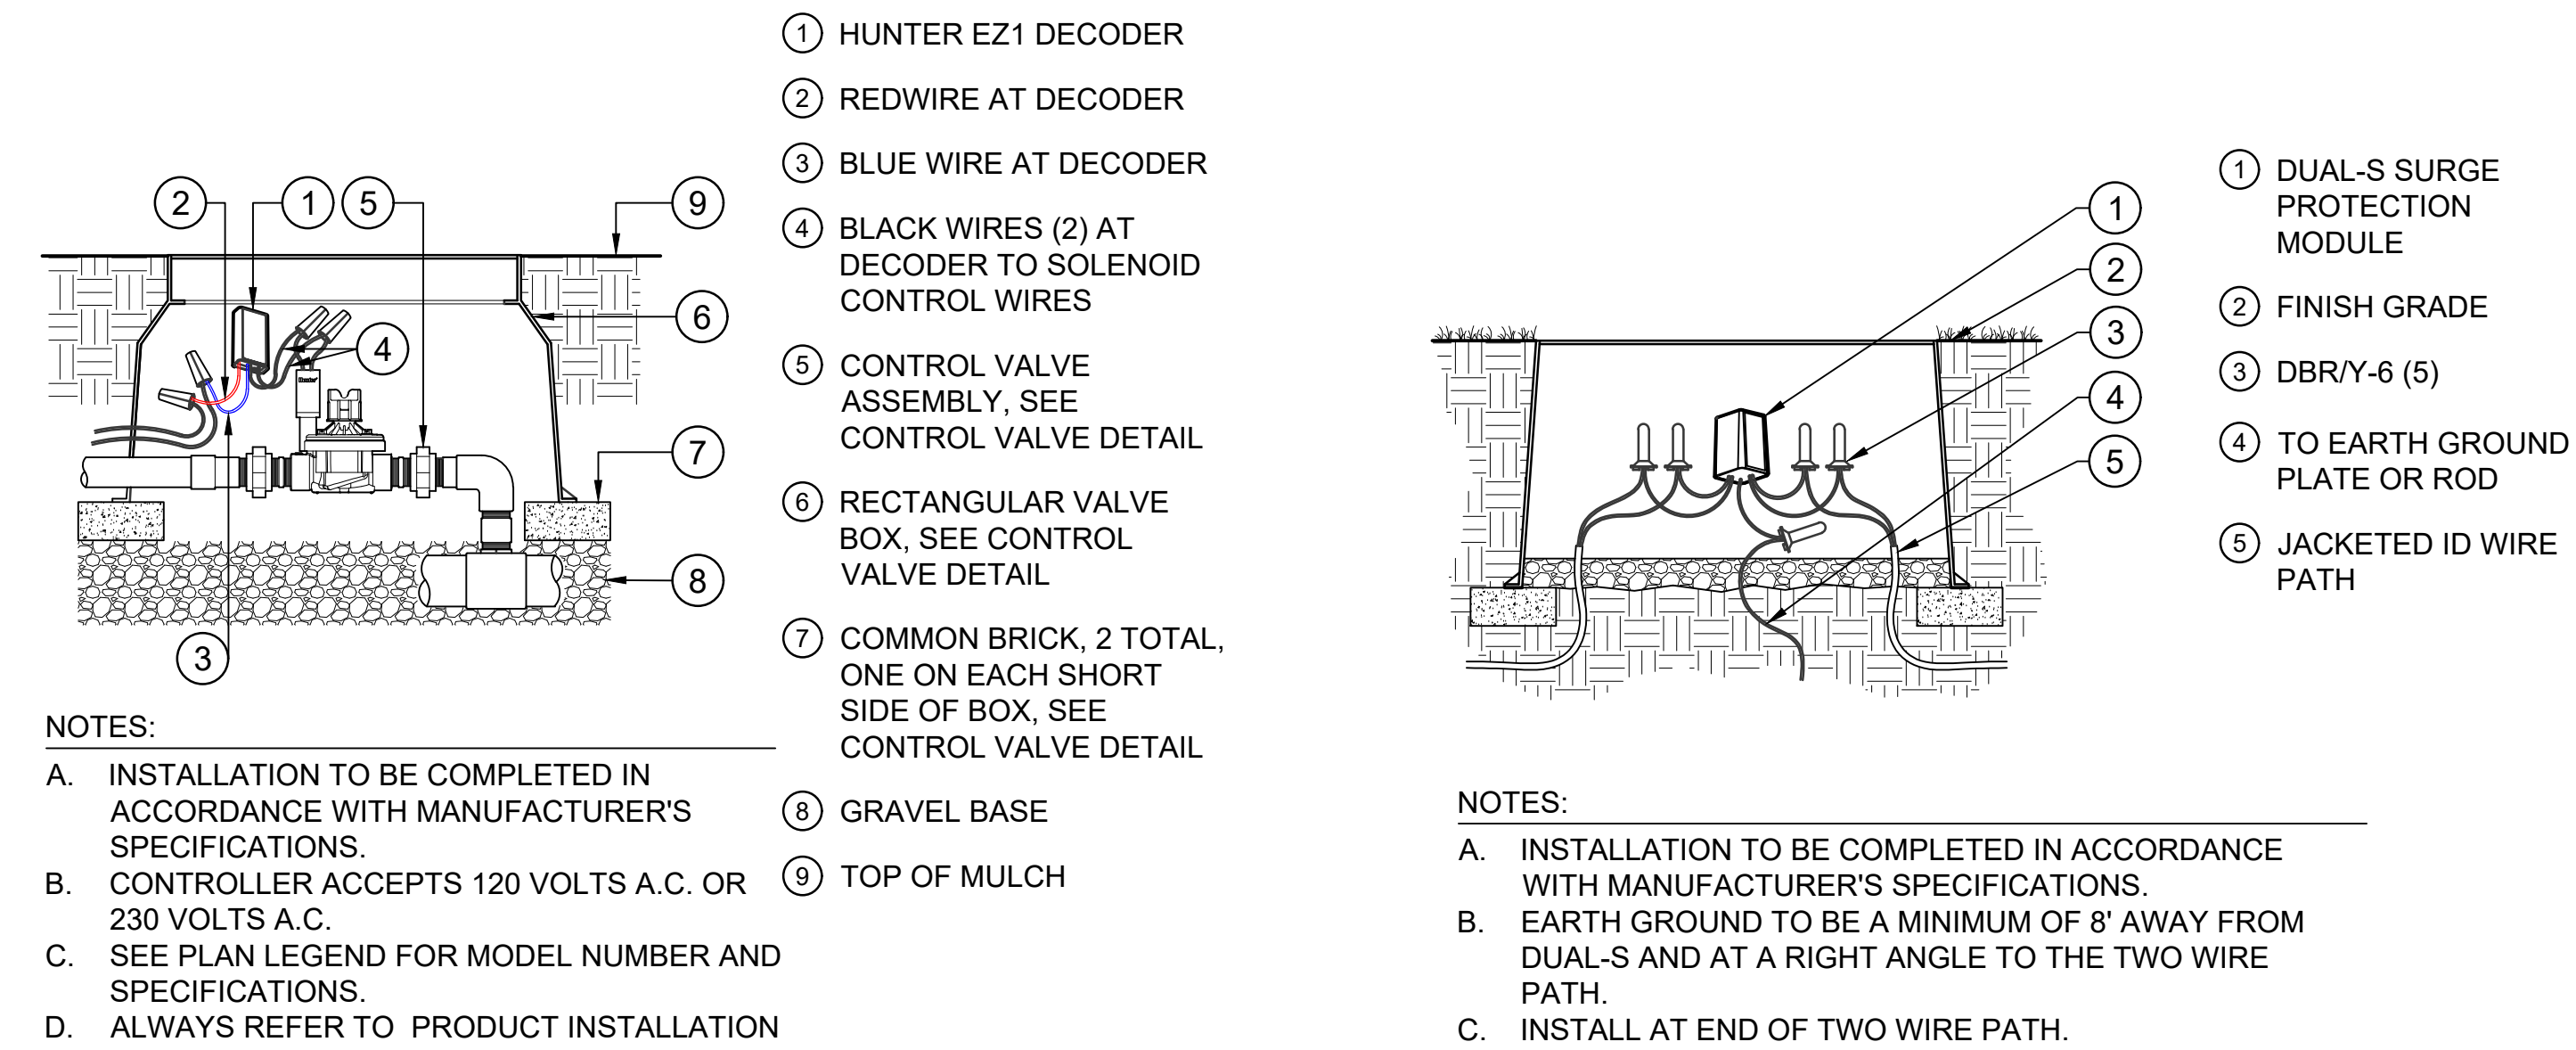
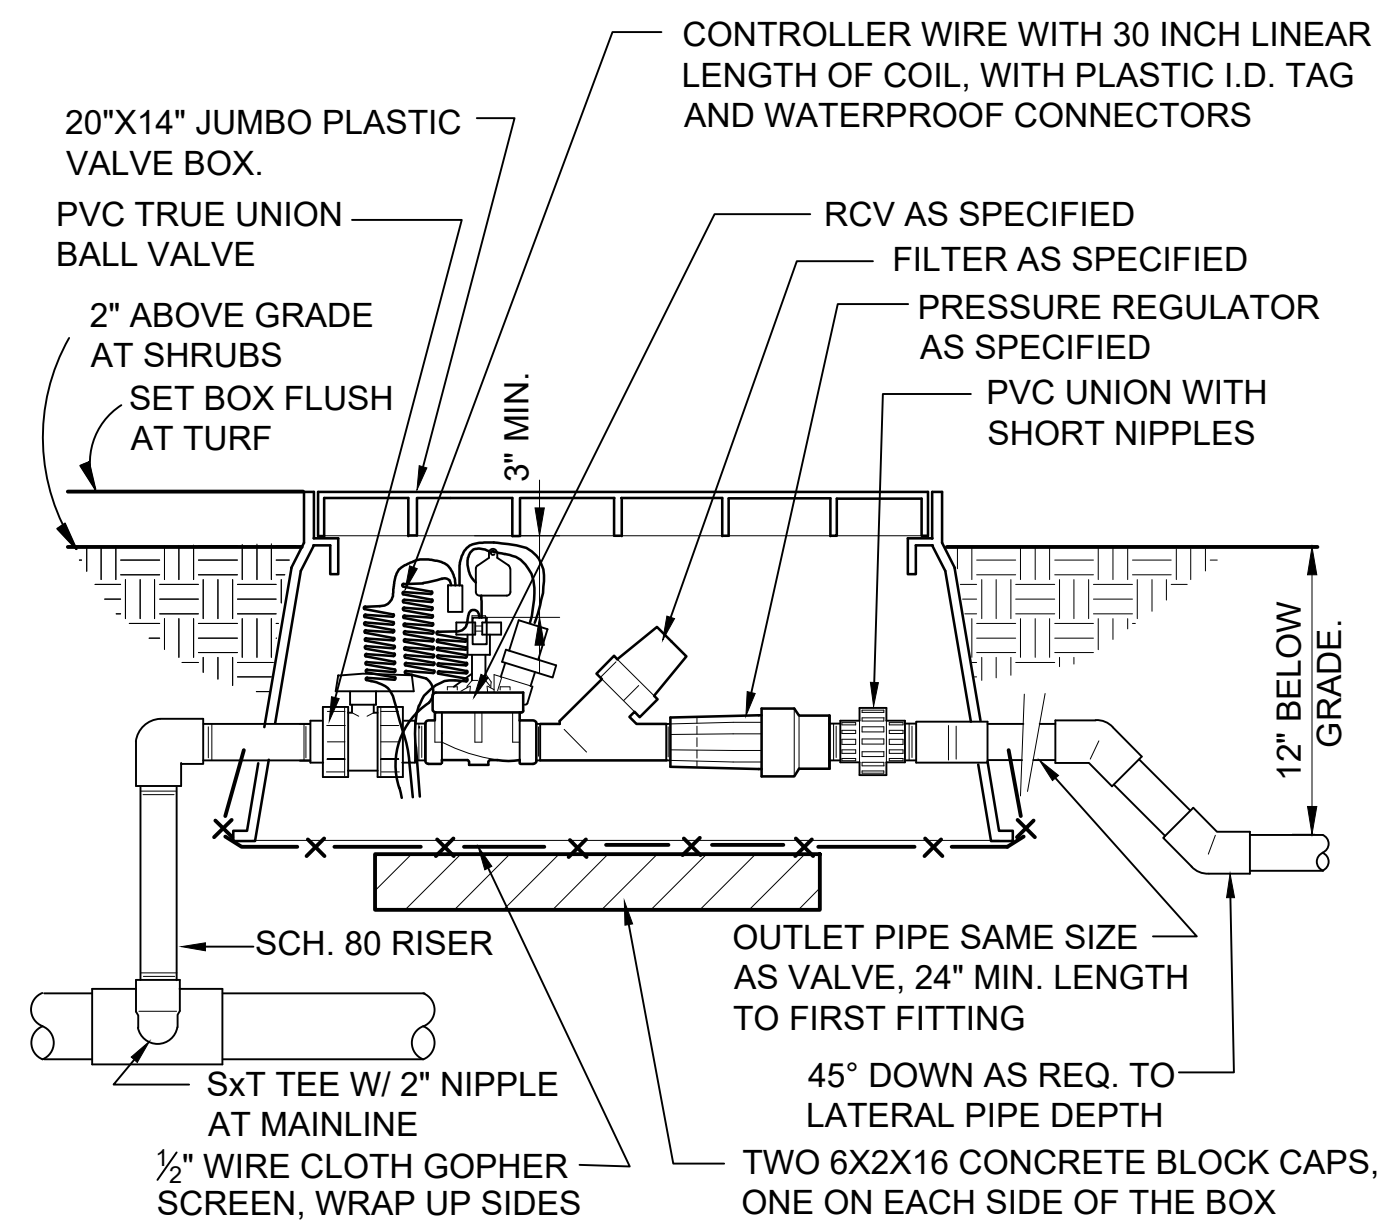
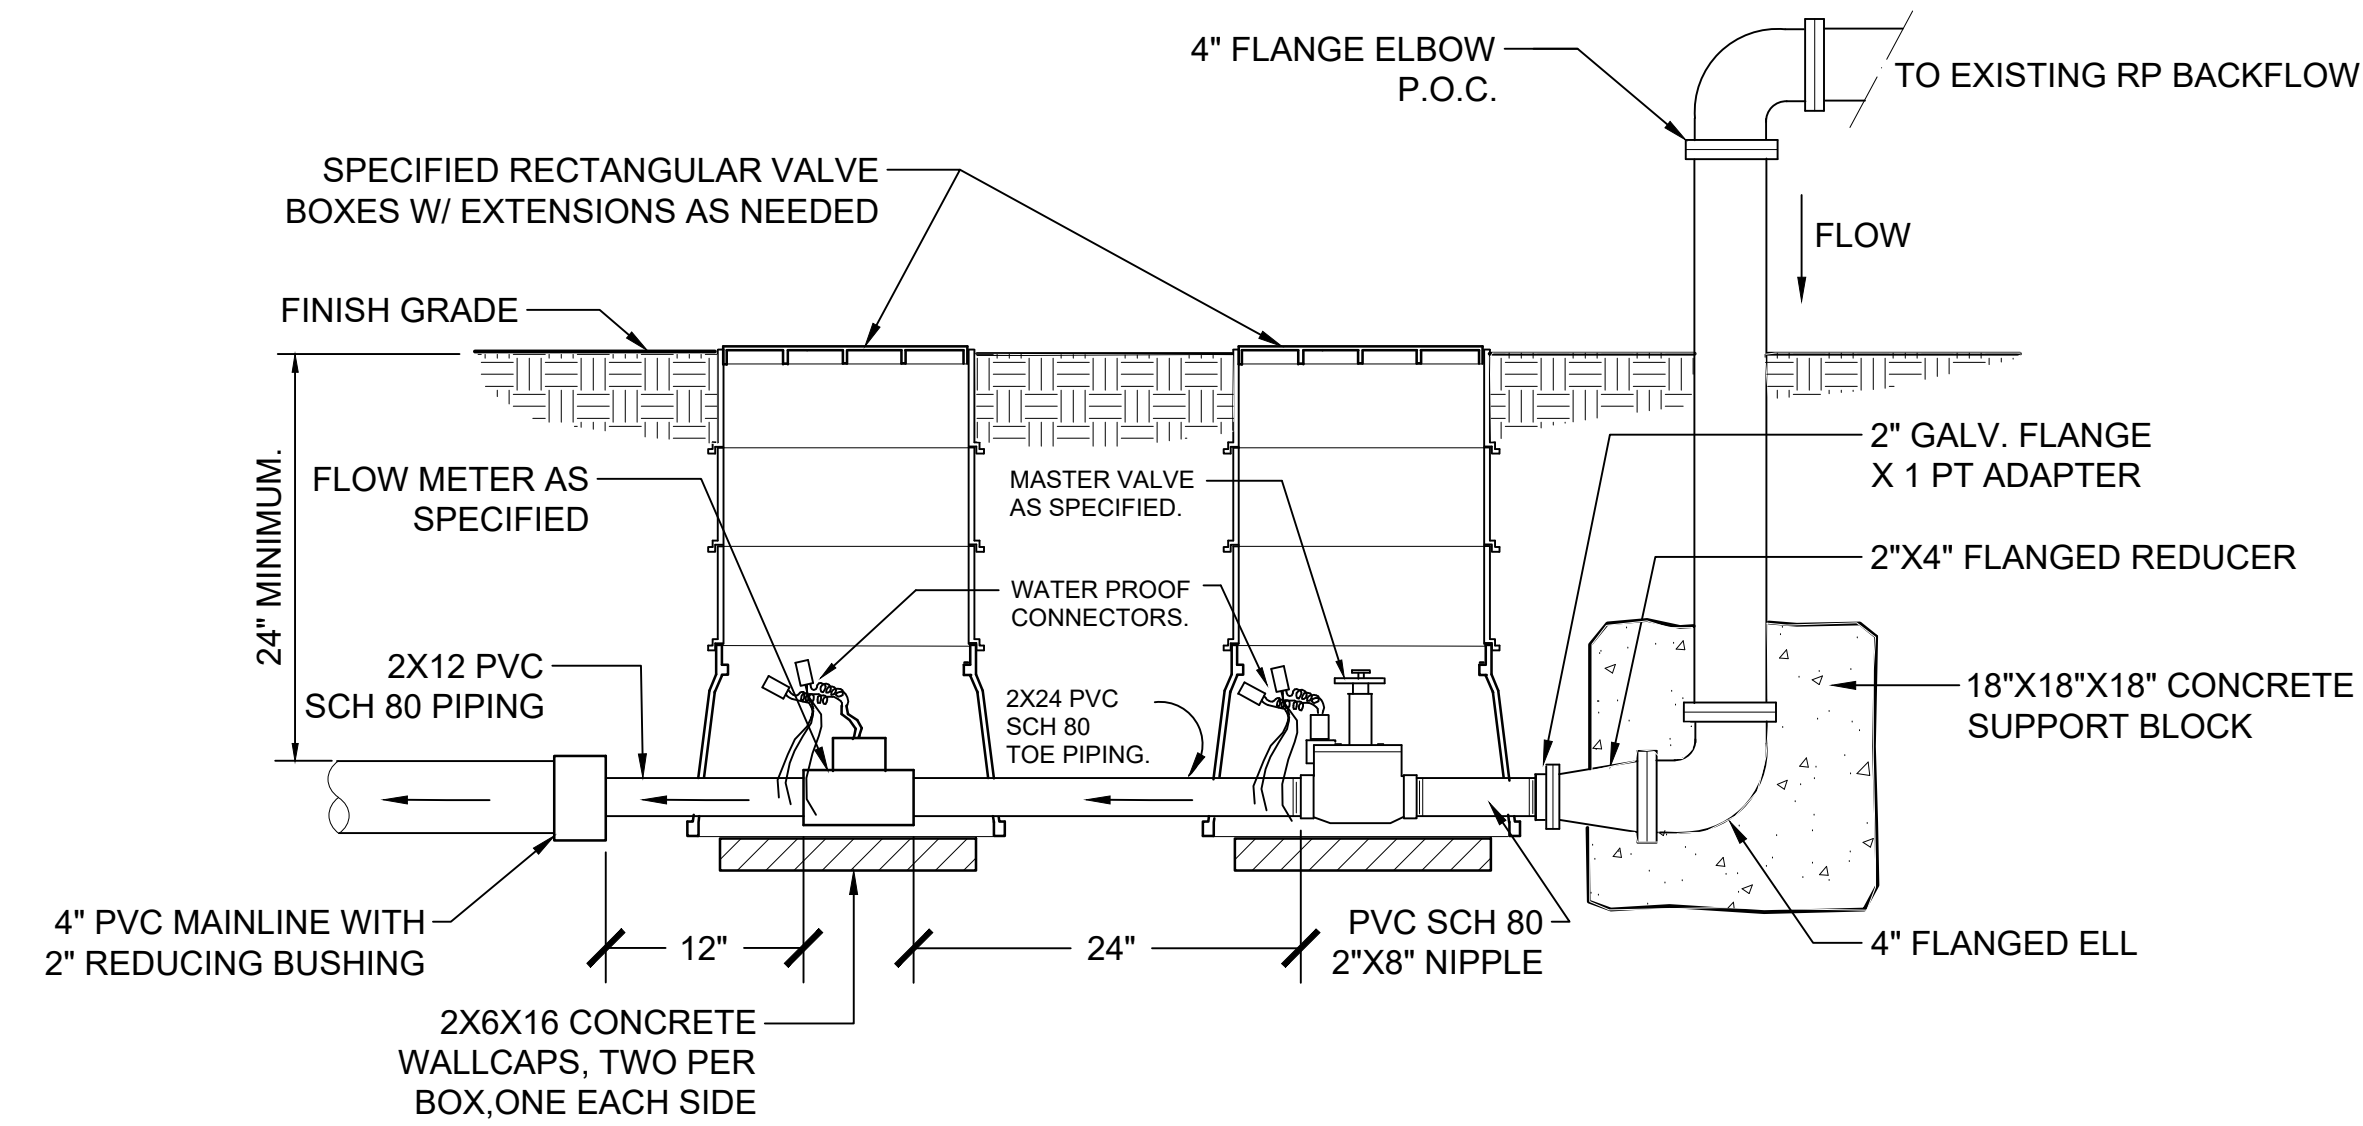
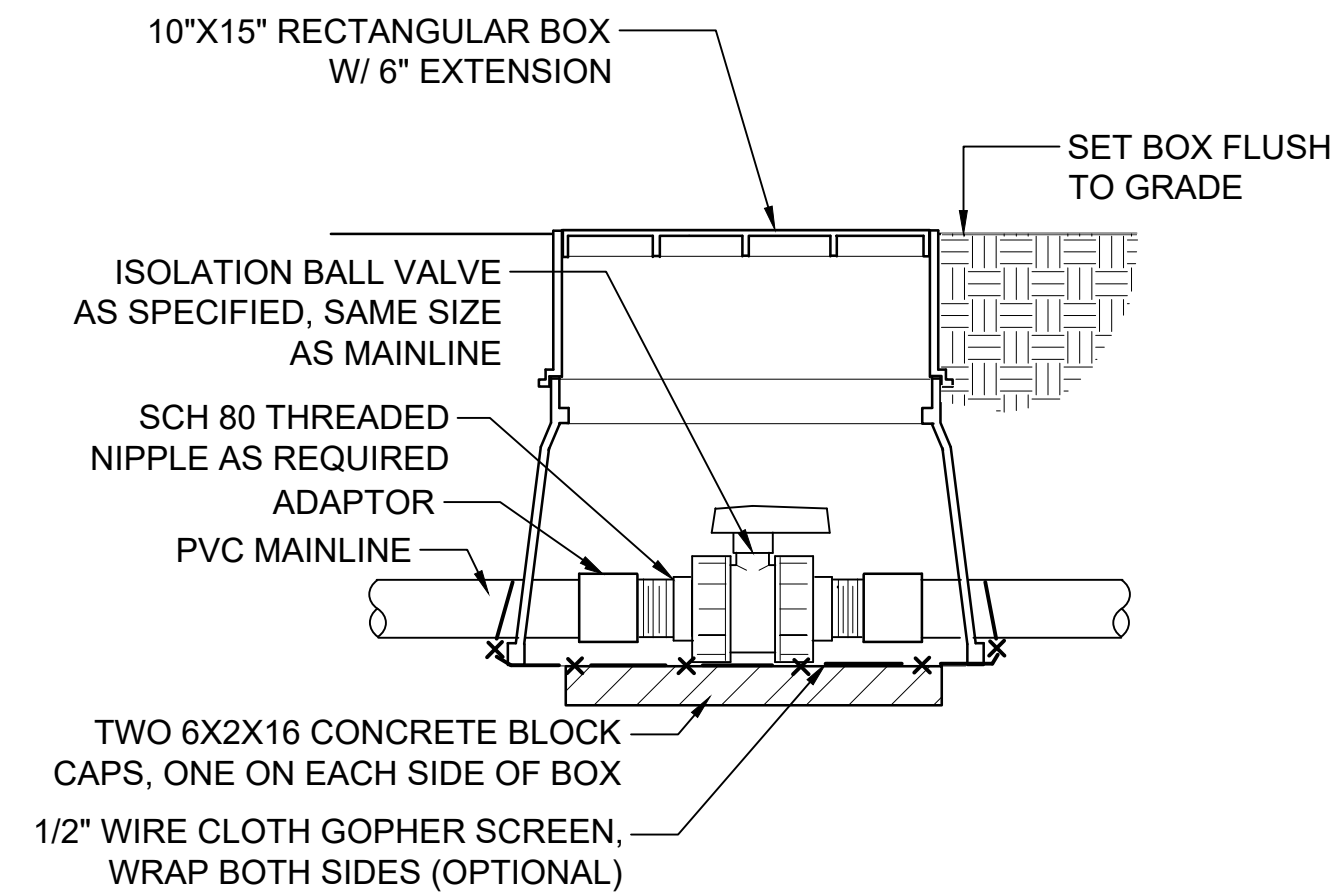

















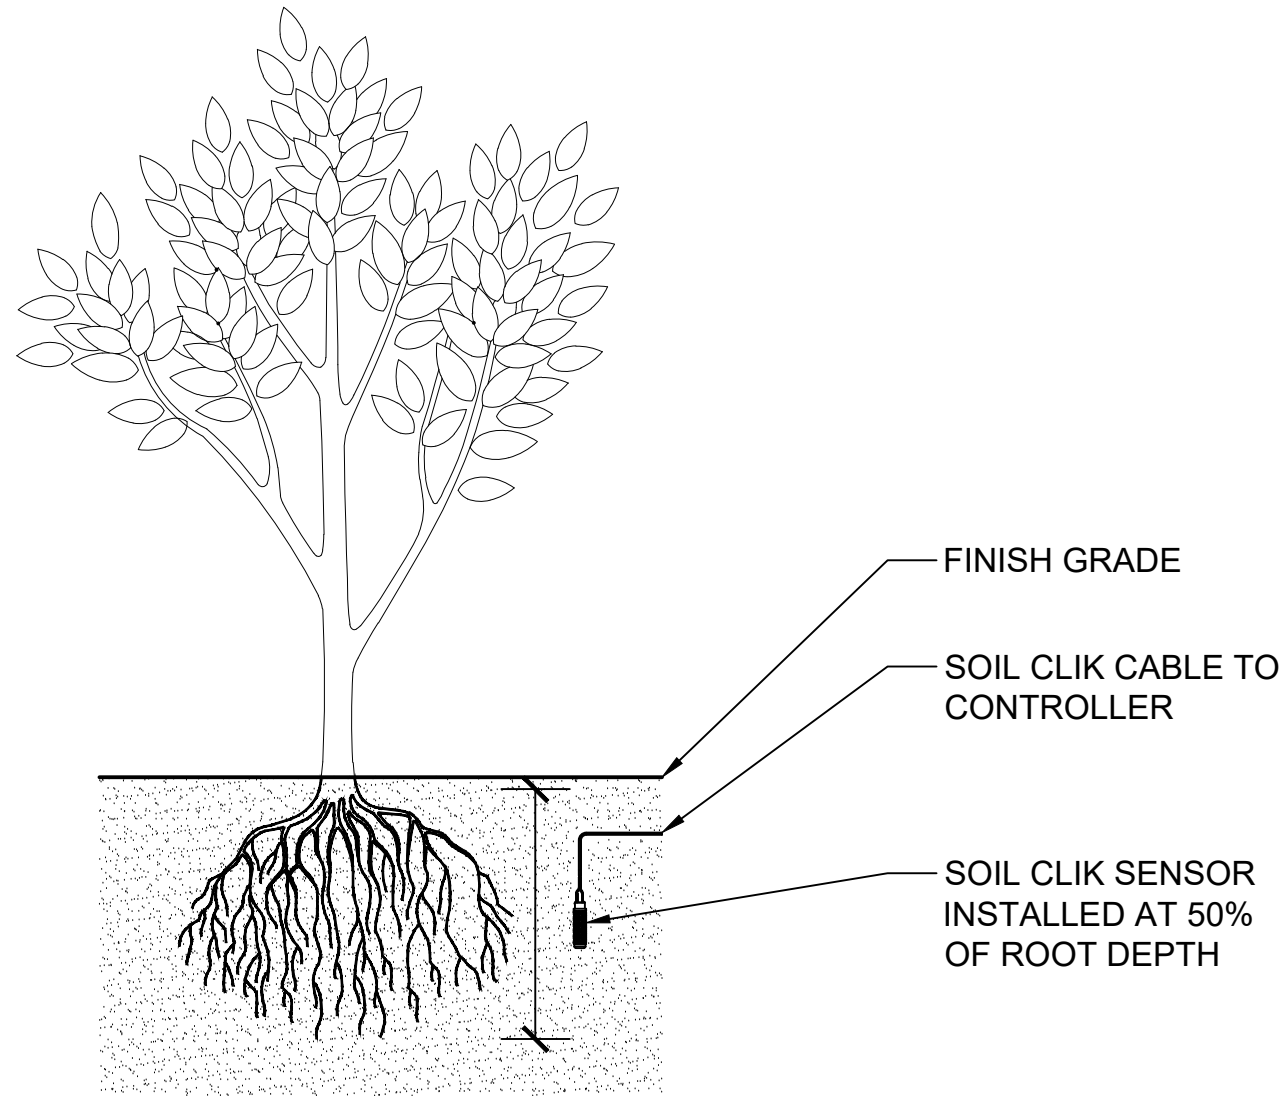


12 SOIL CLIK SENSOR  
1" = 1'-0" P-RE-NOL-18

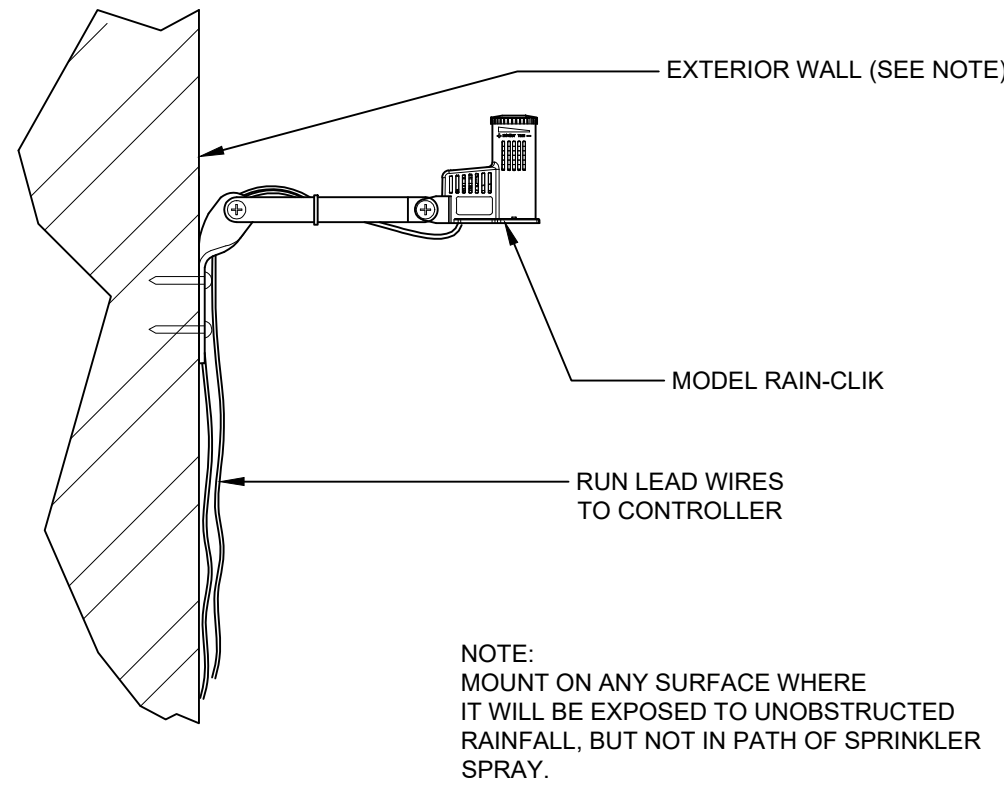


13 RAIN-CLIK  
3" = 1'-0" P-CO-DIG-16

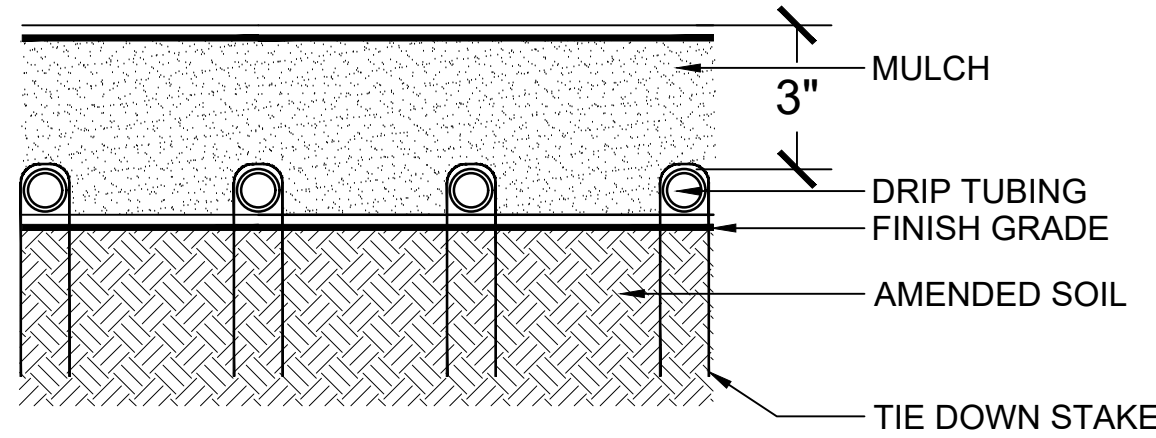


14 ABOVE GRADE DRIP LINE TRANSITION & CONNECTION  
3" = 1'-0" P-CO-OVI3-IRRI-14

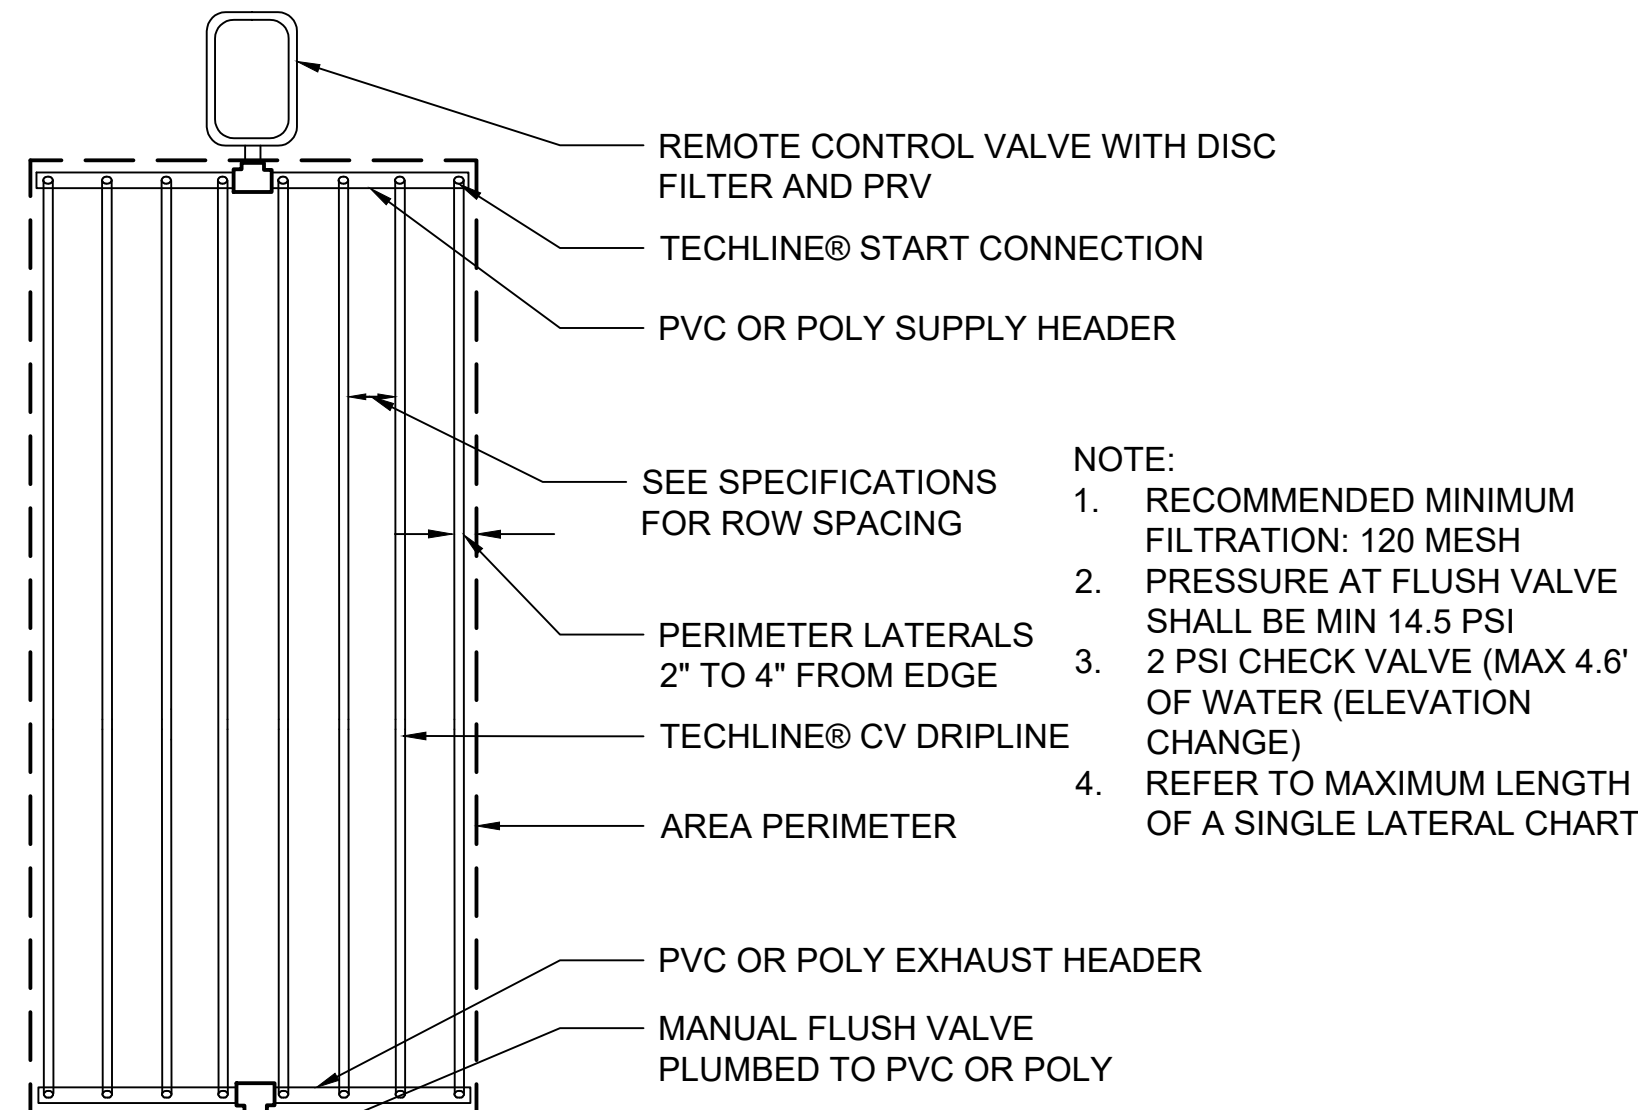


15 NETAFIM TECHLINE CV END FEED LAYOUT (SURFACE & SUBSURFACE)  
NOT TO SCALE 15

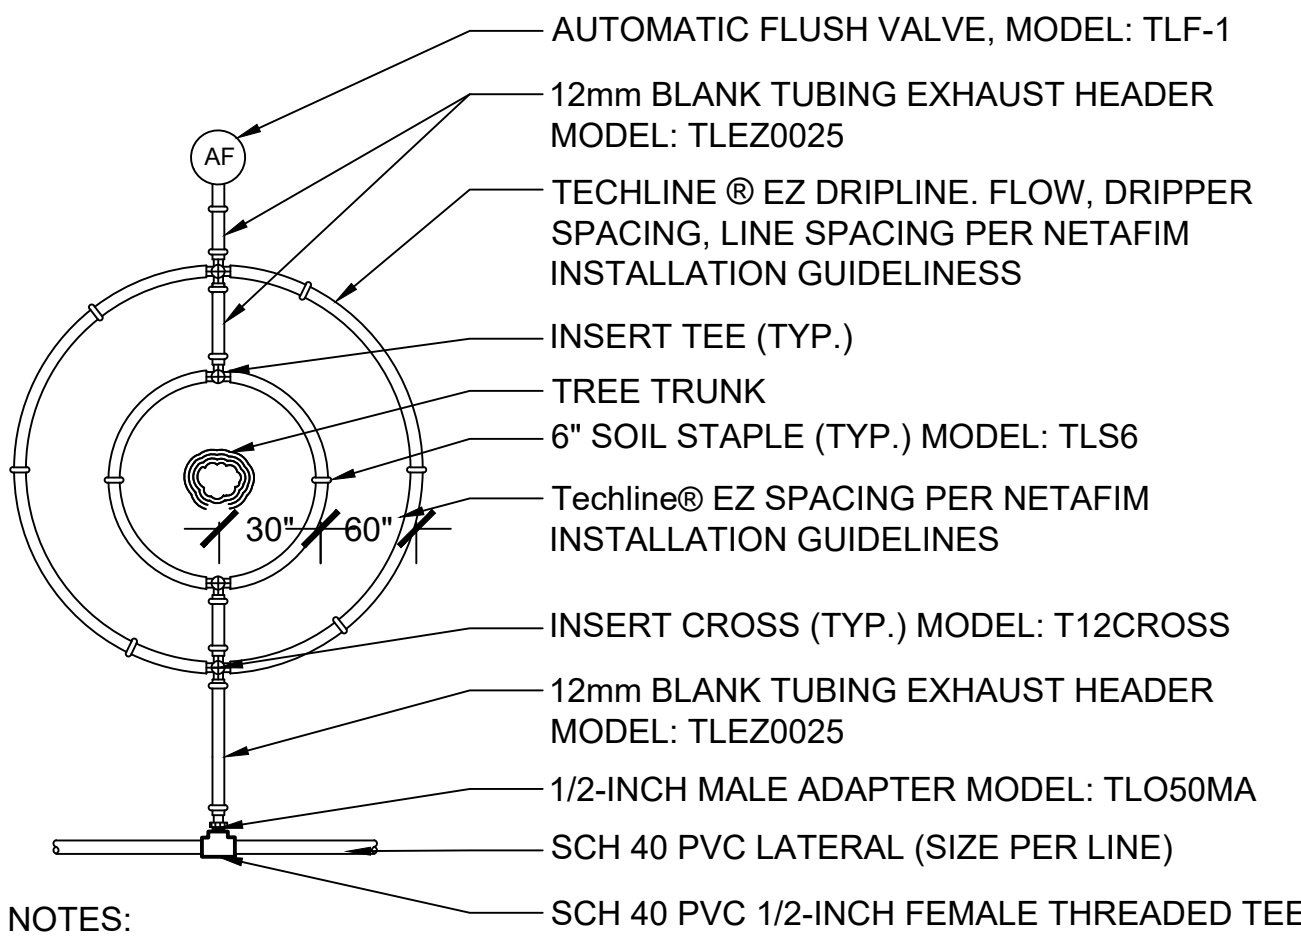


16 DRIP LINE INSTALLATION  
3" = 1'-0" P-CO-OVI3-IRRI-15

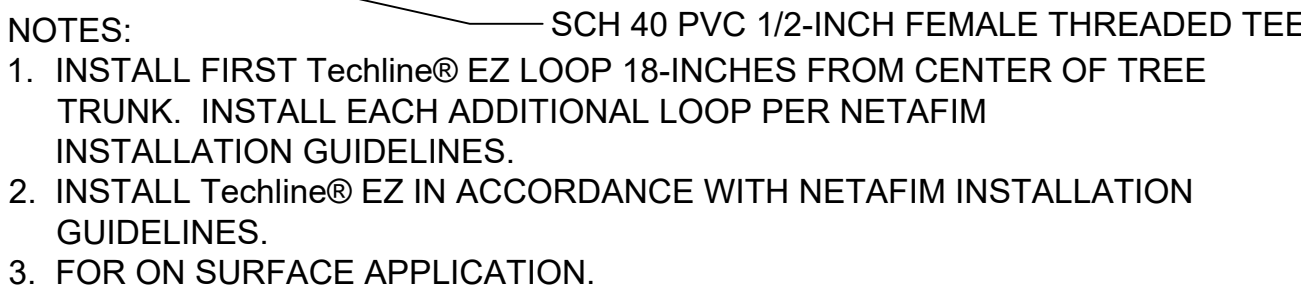


17 TECHLINE® EZ TWO TREE RING LAYOUT  
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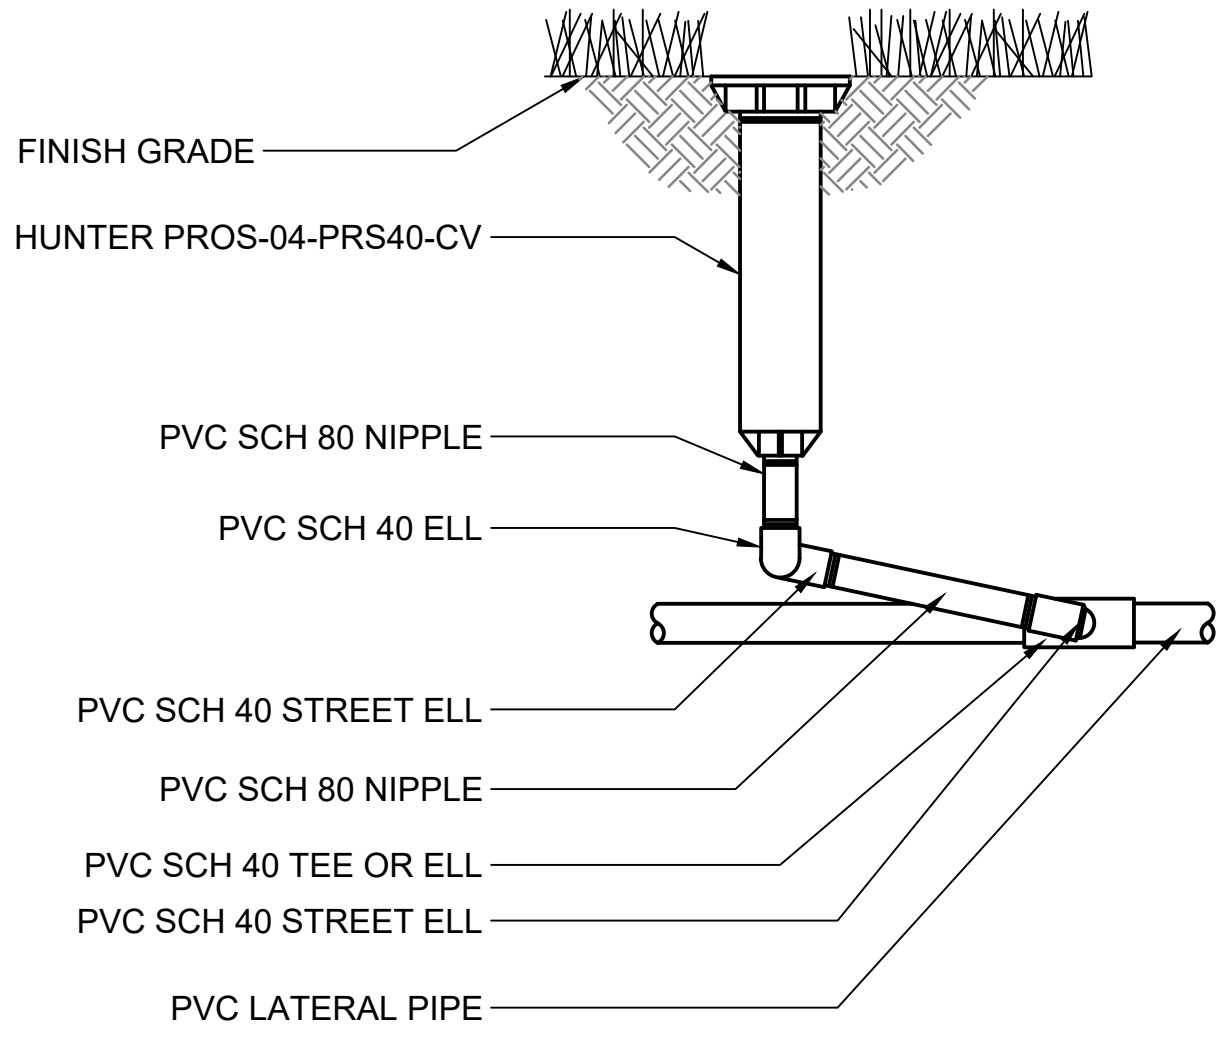
18 TECHLINE® EZ MULTIPLE TREE RING LAYOUT  
NOT TO SCALE P-CO-OVI3-IRRI-18

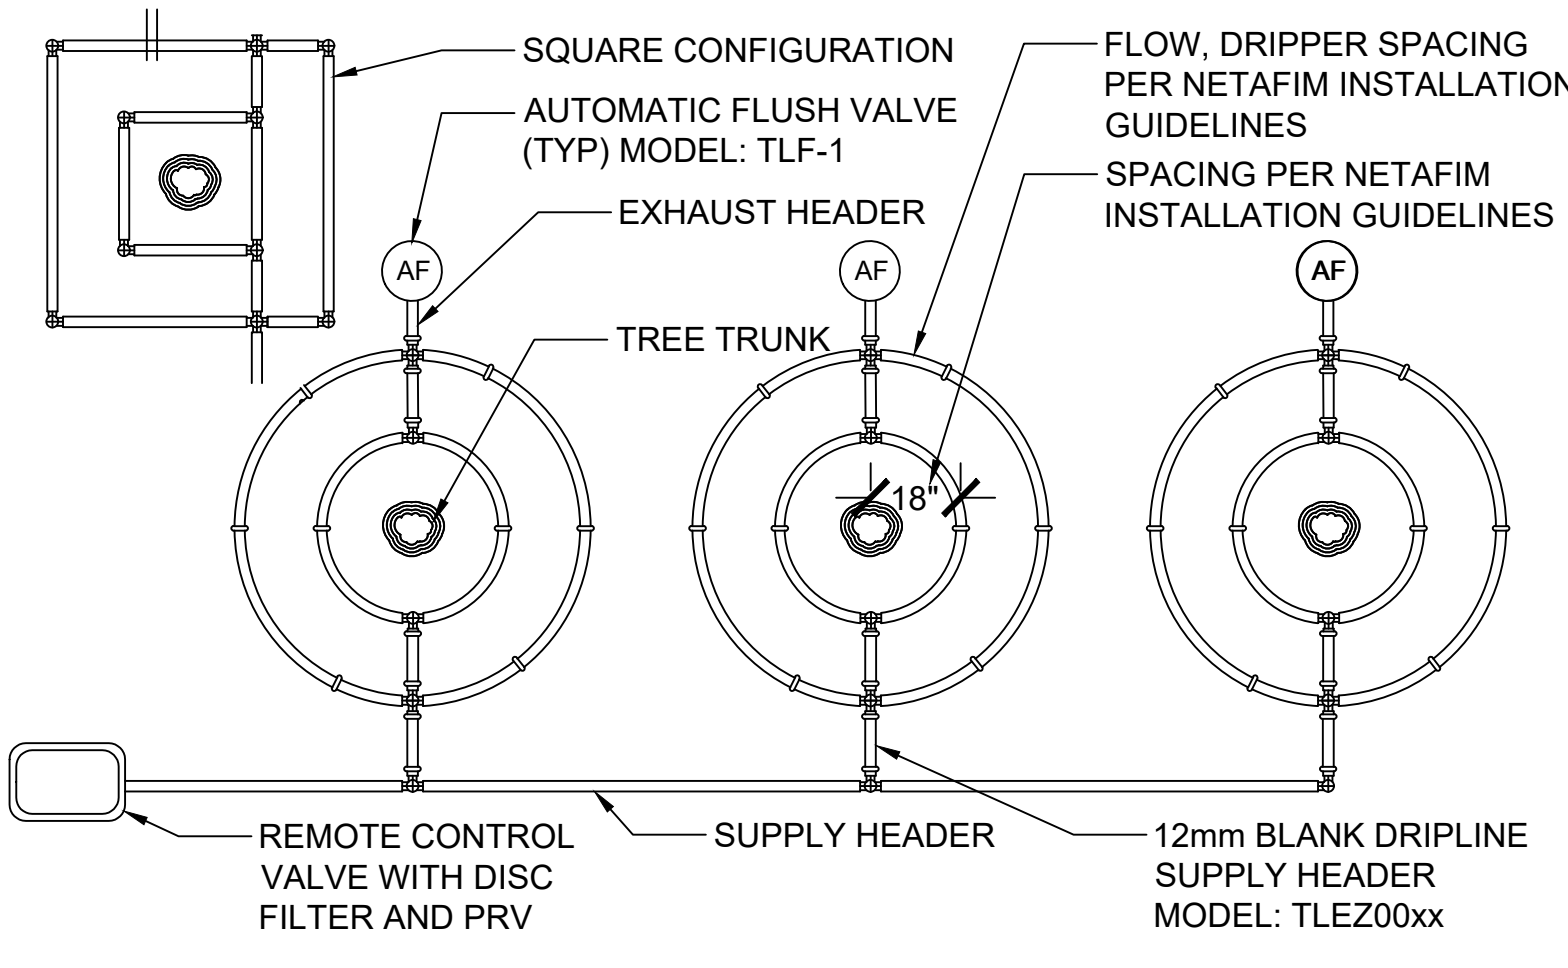


19 SUBSURFACE DRIP PIPE TRANSITION  
3" = 1'-0" P-CO-OVI3-IRRI-21

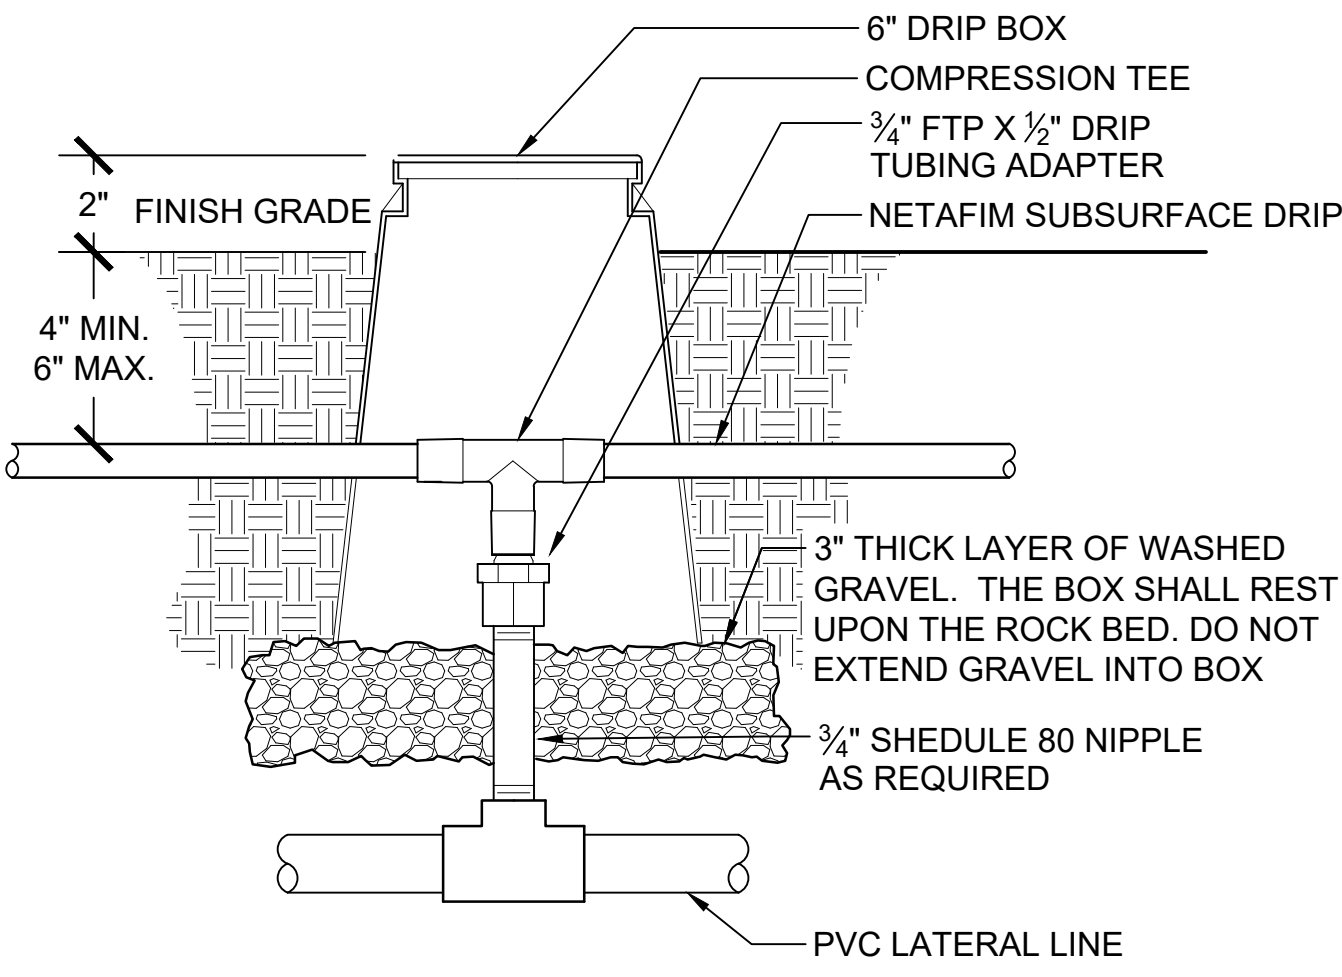


20 TECHLINE® OPERATION PRESSURE INDICATOR STAKE  
NOT TO SCALE P-CO-OVI3-IRRI-32

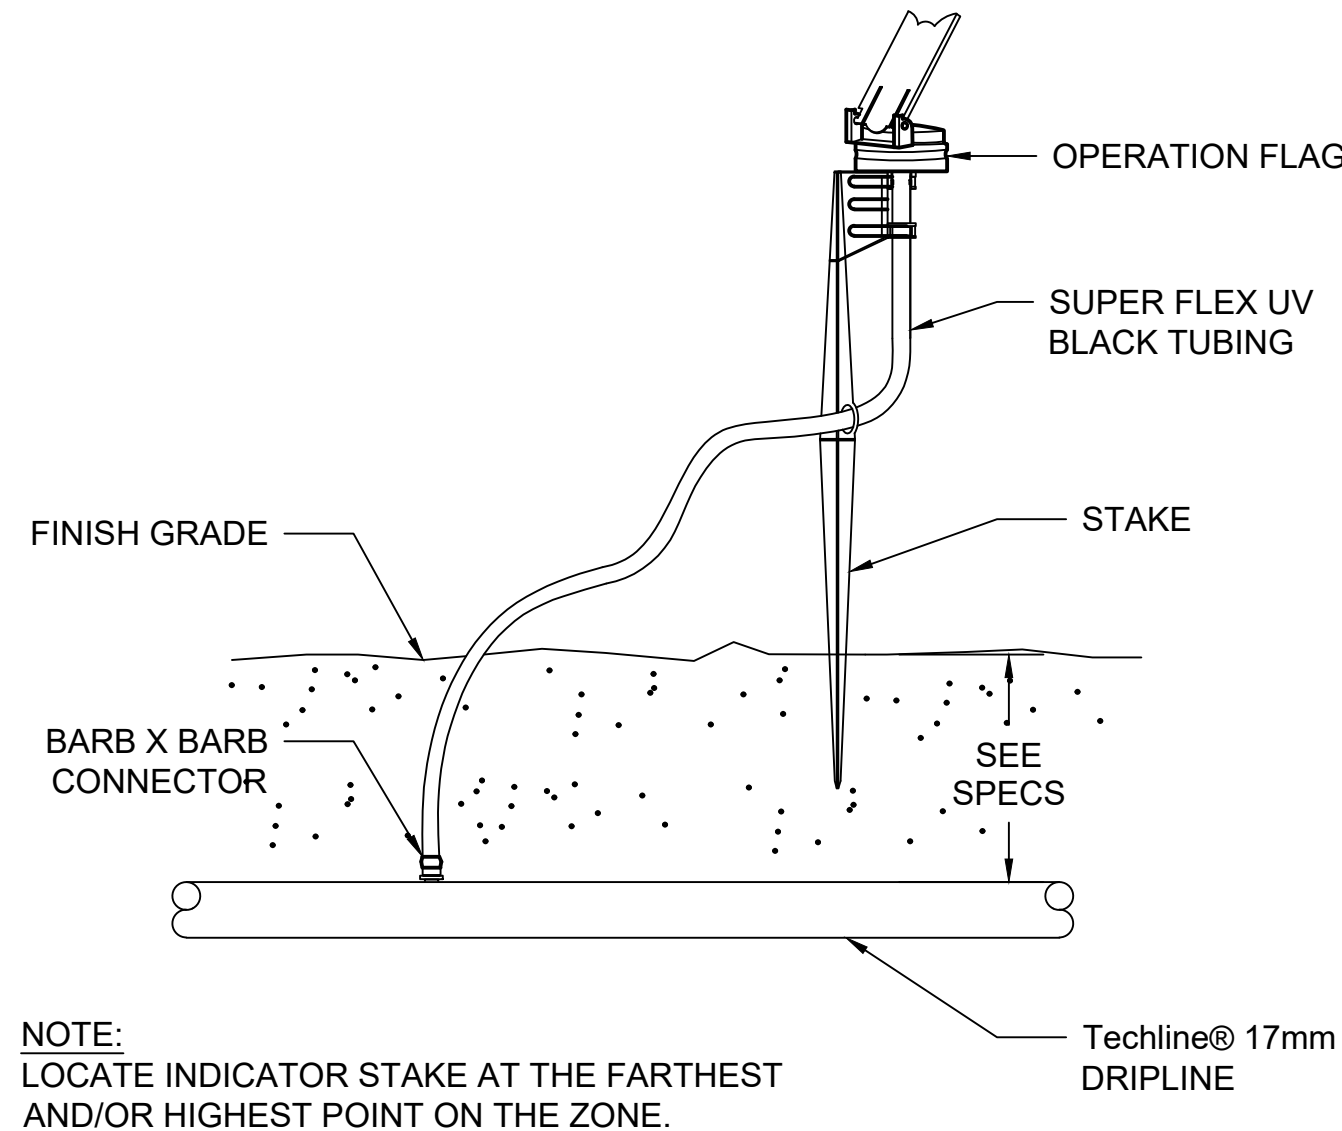


21 HUNTER PROS-4-PRS40-CV  
3" = 1'-0" P-CO-OVI3-IRRI-13

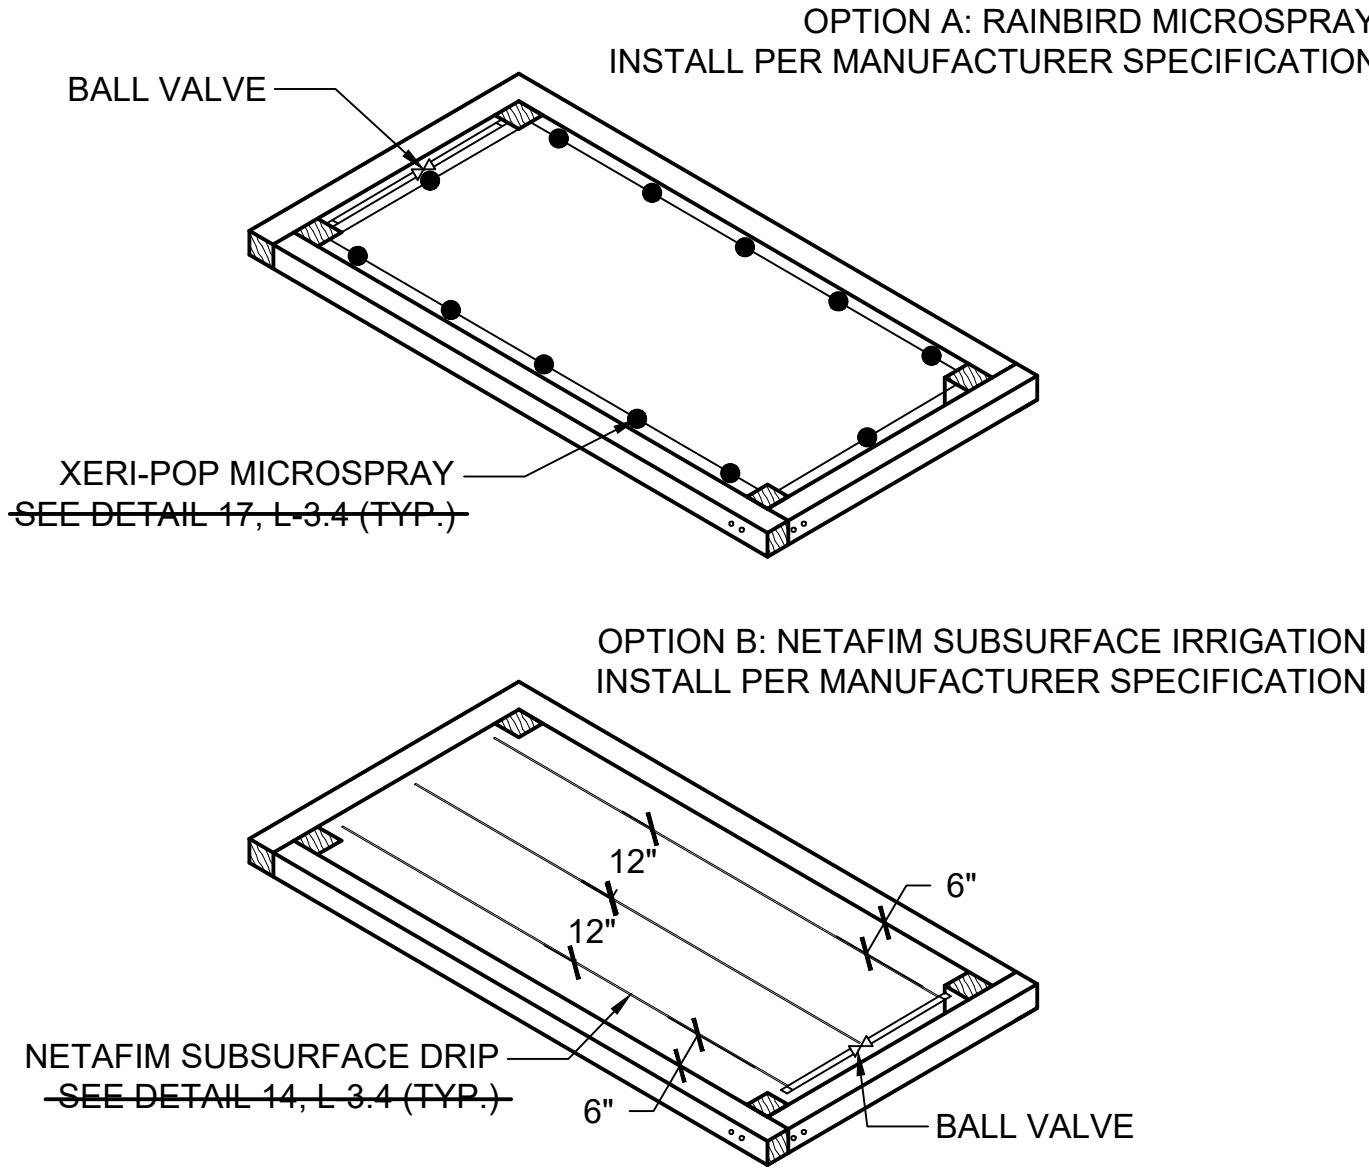

22 RAISED BED IRRIGATION  
NOT TO SCALE P-CO-OVI1-IRRI-41

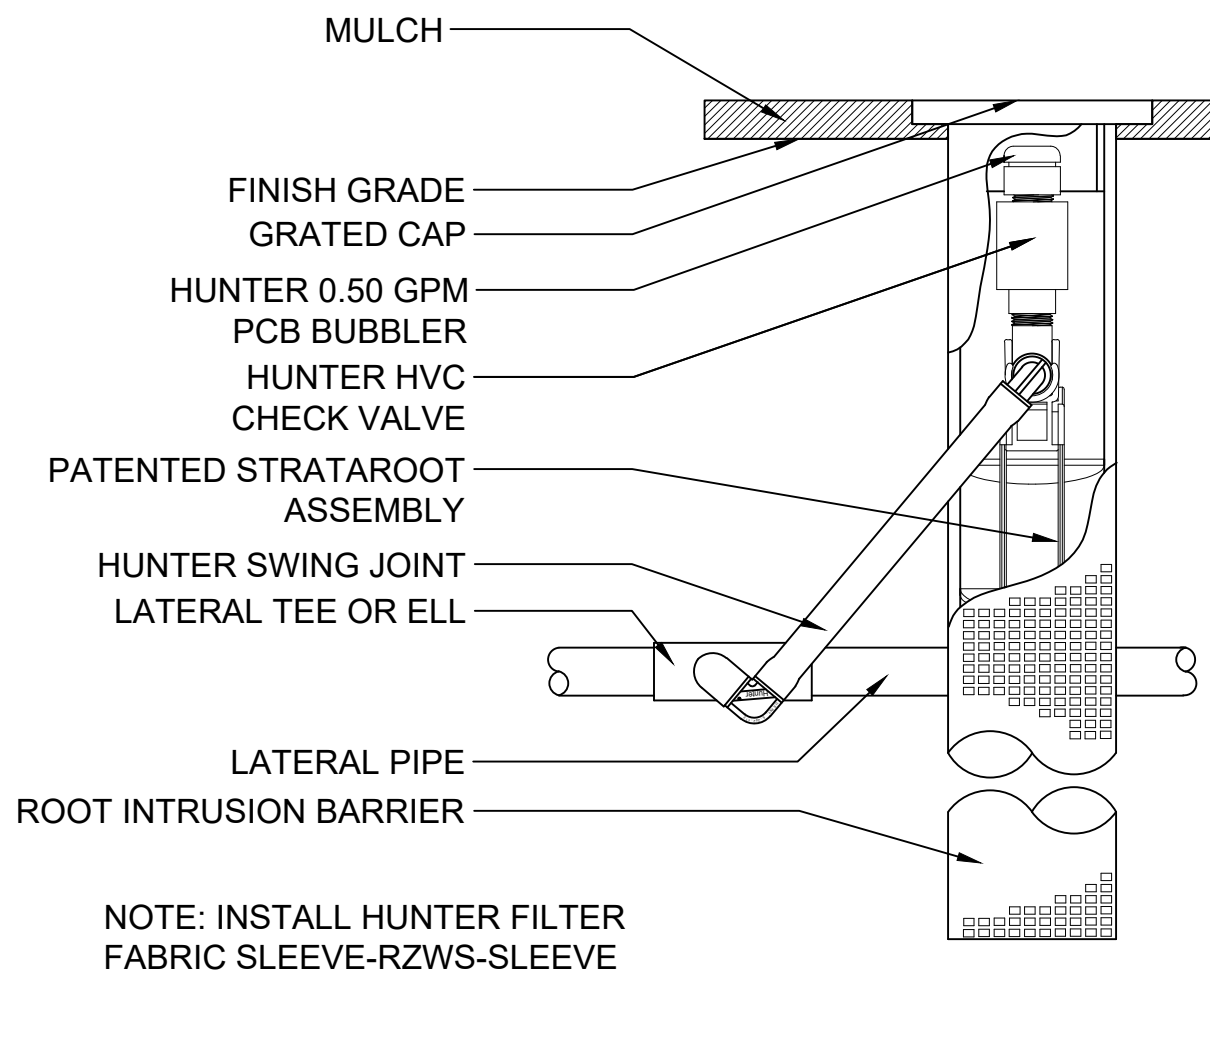

23 HUNTER ROOT ZONE WATERING SYSTEM  
3" = 1'-0" P-RE-LAN-04

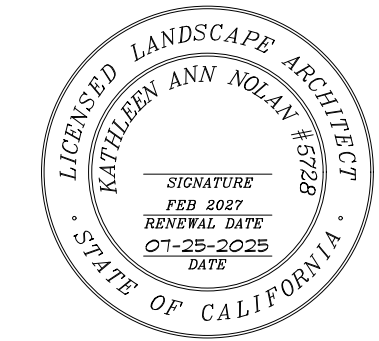

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SHEET	8 OF 14



LANDSCAPE PLANT IMAGERY

TREES



QUERCUS AGRIFOLIA / COAST LIVE OAK



CERCIS OCCIDENTALIS / WESTERN REDBUD

COURTYARD PLANTING



OLEA EUROPAEA 'SWAN HILL' / SWAN HILL FRUITLESS OLIVE



ASSORTED CITRUS



MYRTUS COMPACTA / COMPACT MYRTLE

ZONE 0



DIPLACUS AURANTIACUS 'JELLY BEAN ORANGE' / JELLY BEAN ORANGE MONKEYFLOWER



DUDLEYA VIRENS HASSEI / CATALINA ISLAND LIVE-FOREVER

BIOSWALE/RAINGARDEN



ACHILLEA MILLEFOLIUM / COMMON YARROW



ARTEMISIA DOUGLASIANA / MUGWORT



ELYMUS TRITICOIDES / CREEPING WILD RYE



JUNCUS TEXTILIS / BASKET RUSH



STACHYS BULLATA / HEDGE NETTLE

SCREENING SHRUBS



FRANGULA CALIFORNICA / COFFEEBERRY



HETEROMELES ARBUTIFOLIA / TOYON




PRUNUS ILICIFOLIA / HOLLYLEAF CHERRY



SAMBUCUS MEXICANA / ELDERBERRY

LANDSCAPE MATERIALS & IMAGERY


BICYCLE RACK

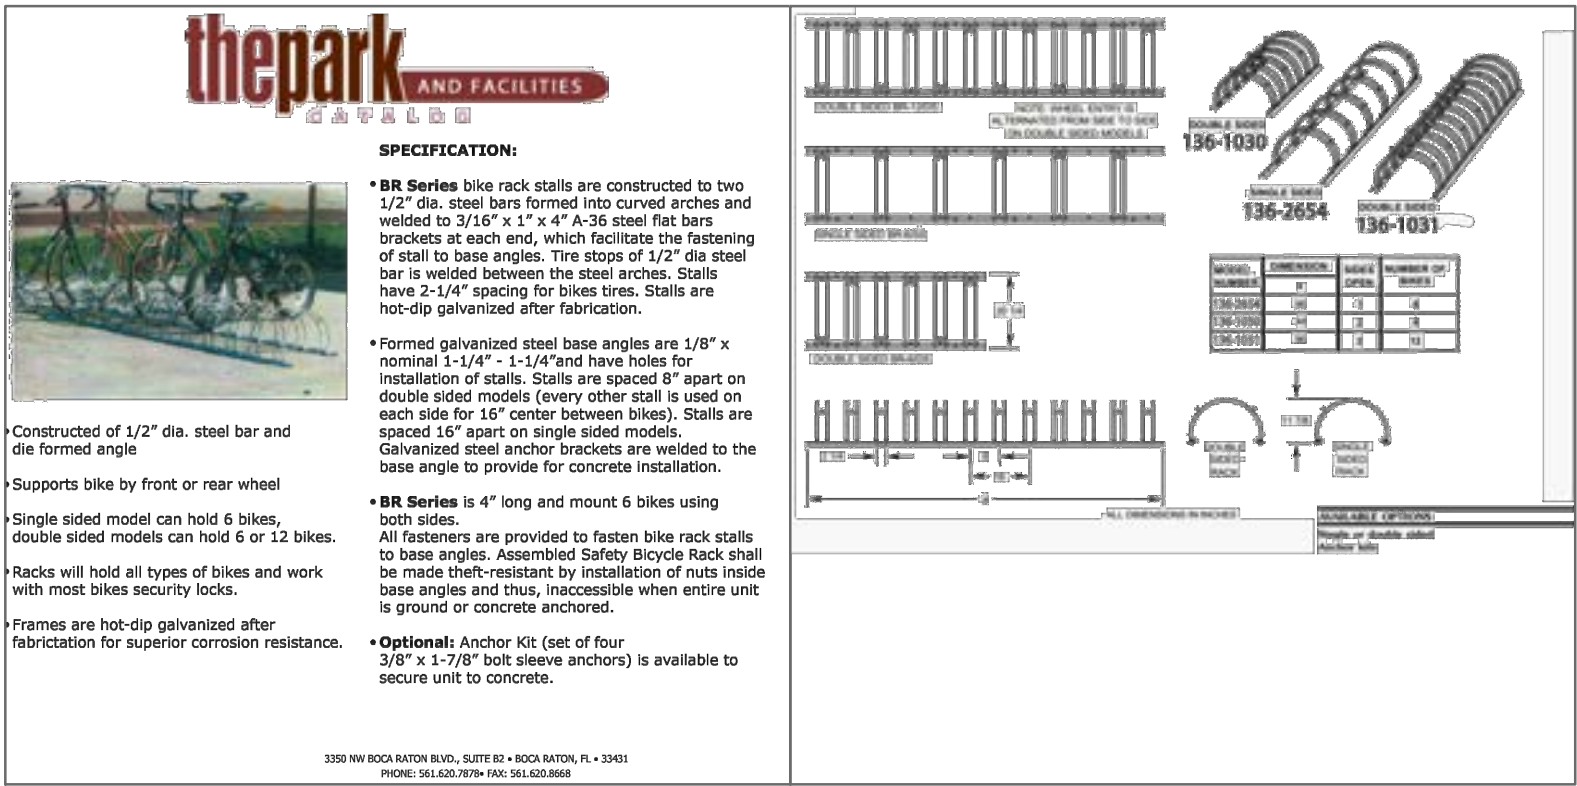

6'-0" IRON FENCE - MATTE BRONZE FINISH



ORGANIC-LOCK PERMEABLE ADA COMPLIANT DECOMPOSED GRANITE

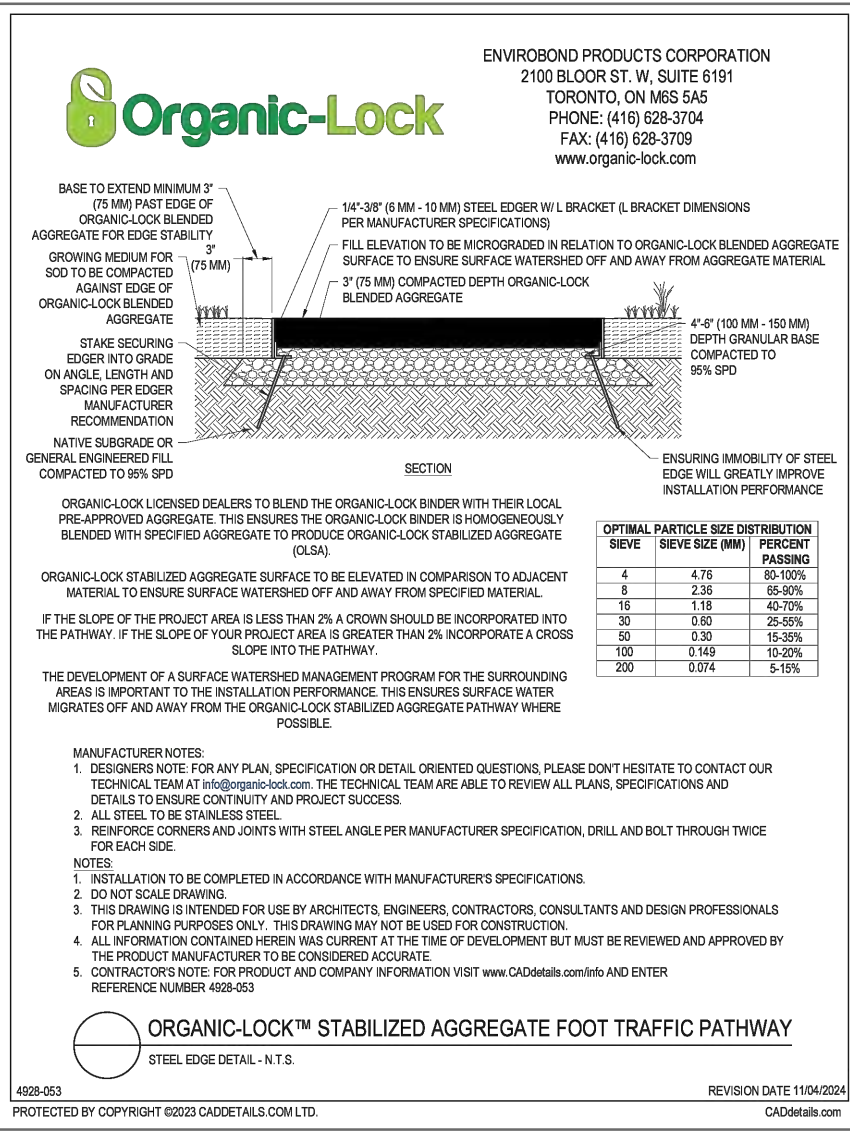

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LANDSCAPE MATERIALS & IMAGERY

REVISIONS

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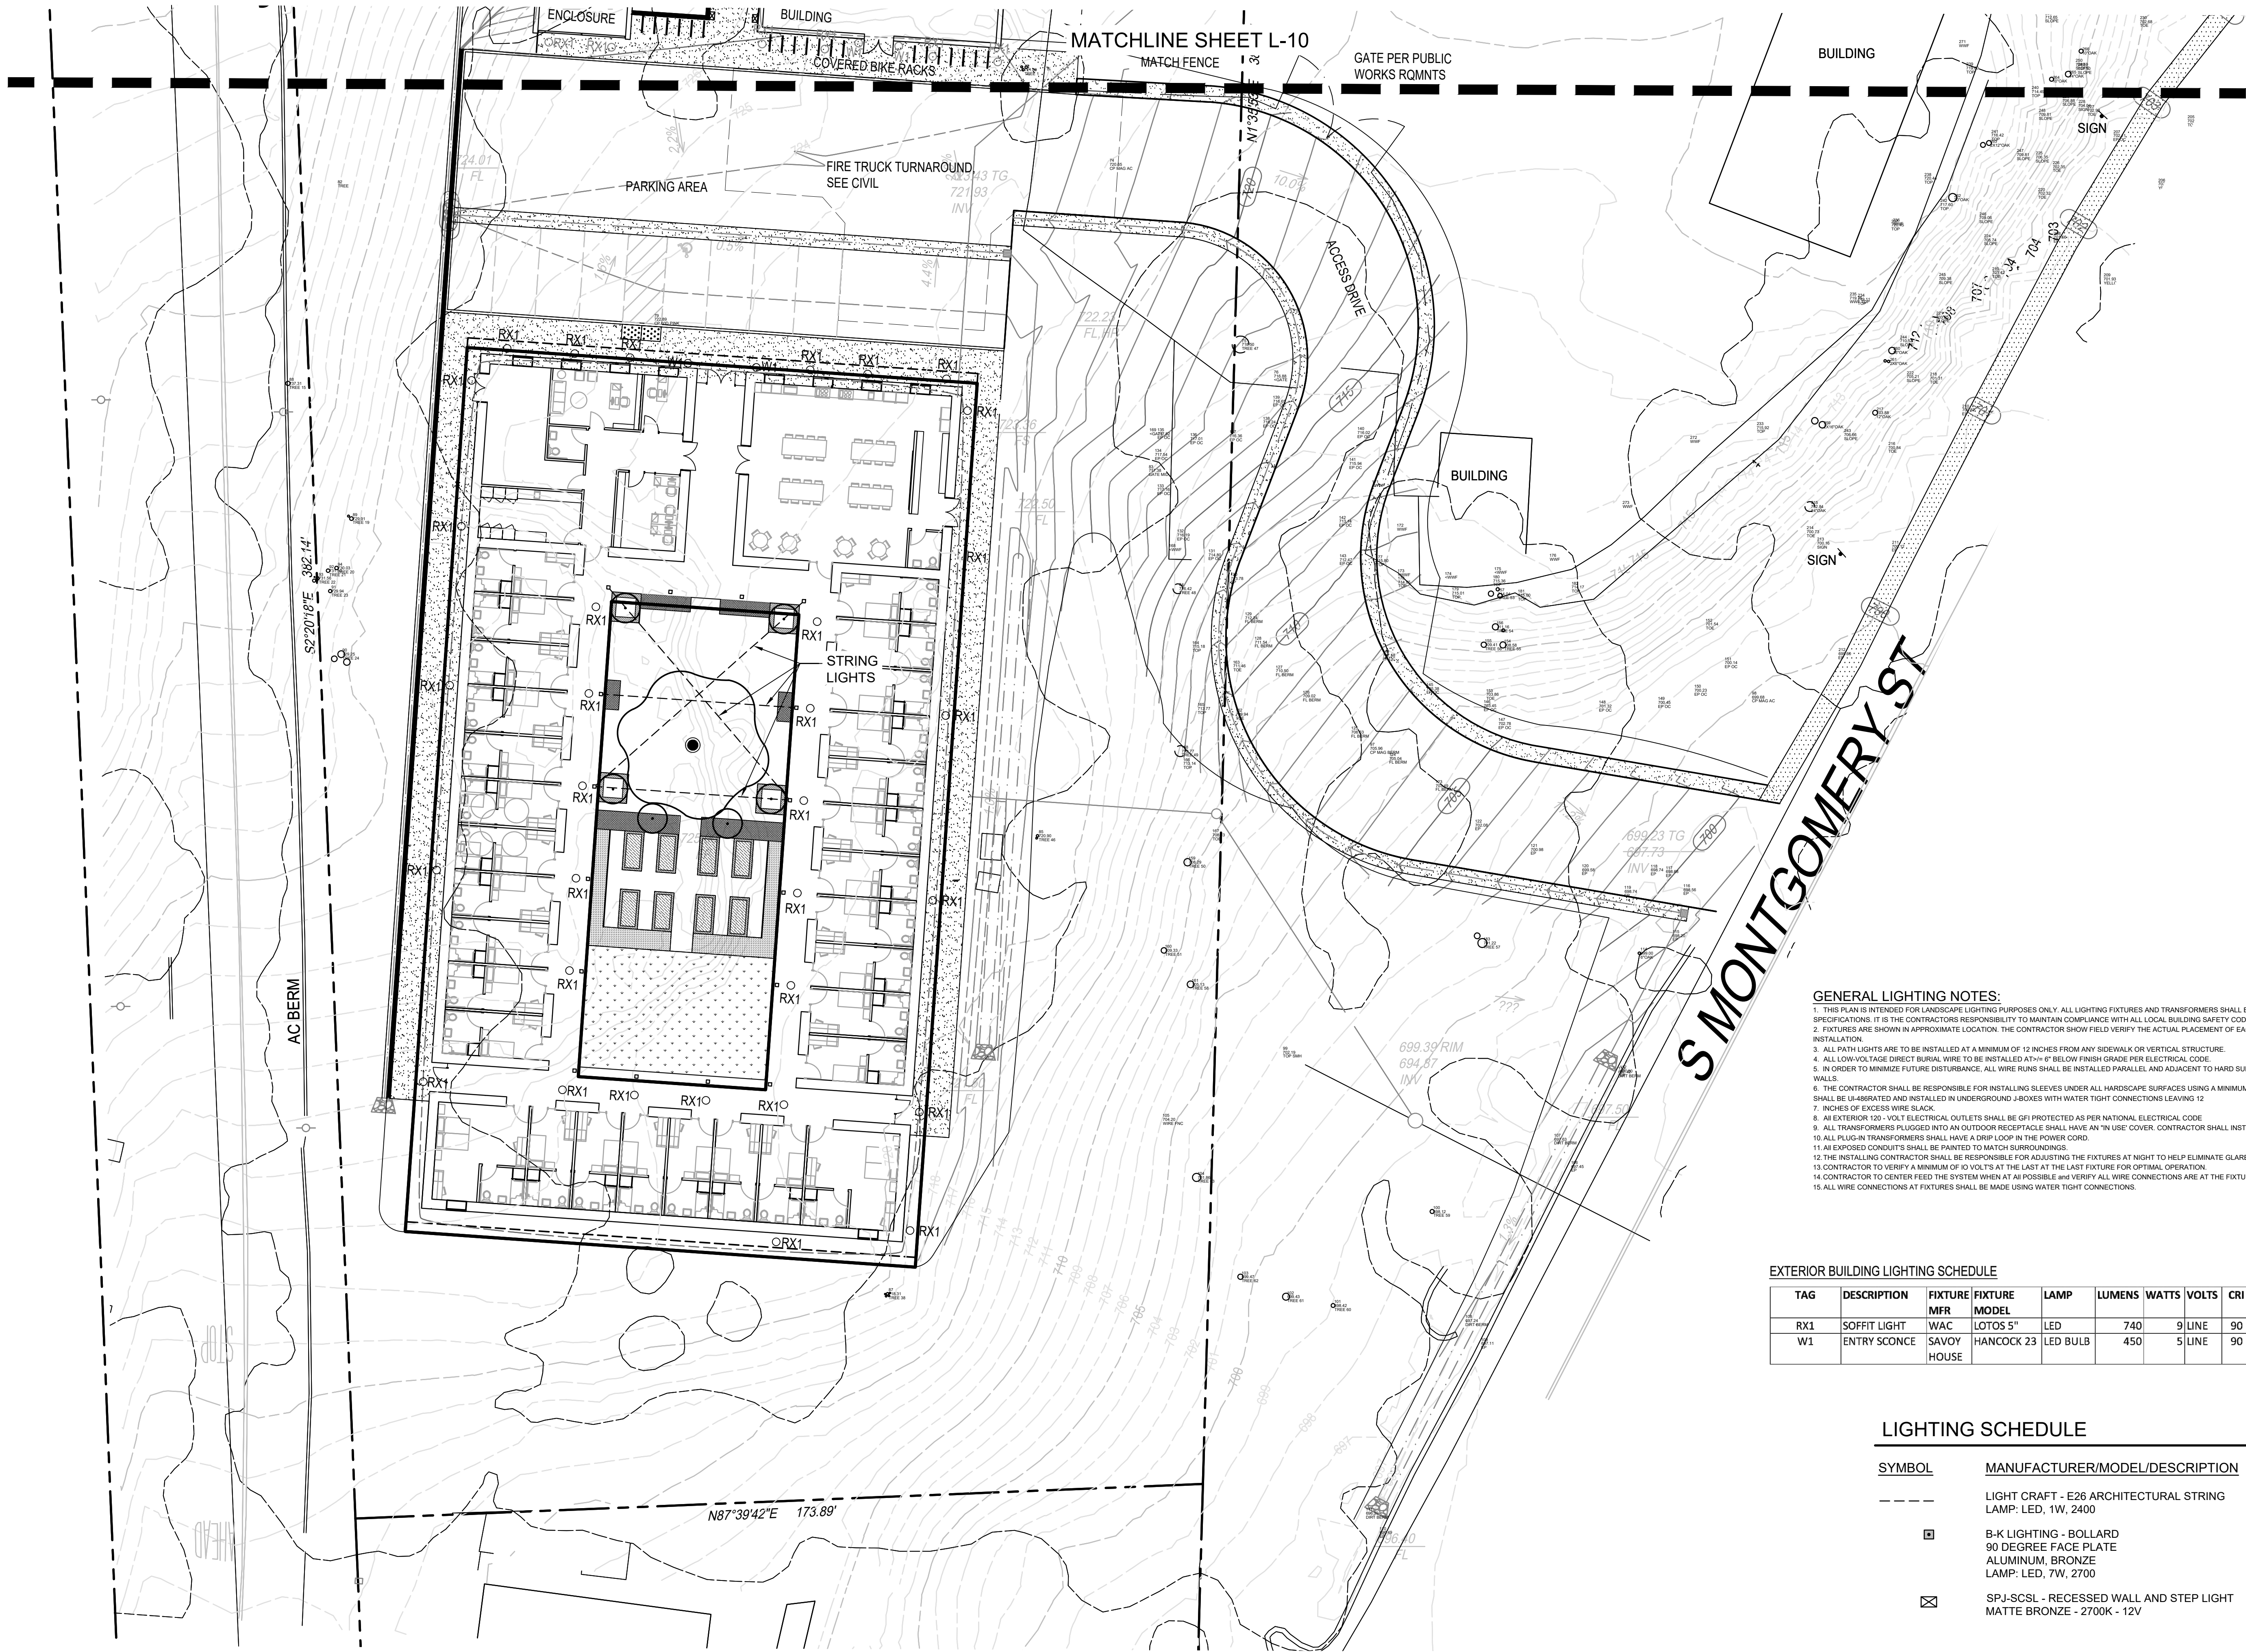
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SHEET 9 OF 14

L-8





- GENERAL LIGHTING NOTES:
- THIS PLAN IS INTENDED FOR LANDSCAPE LIGHTING PURPOSES ONLY. ALL LIGHTING FIXTURES AND TRANSFORMERS SHALL BE INSTALLED PER MANUFACTURERS SPECIFICATIONS. IT IS THE CONTRACTORS RESPONSIBILITY TO MAINTAIN COMPLIANCE WITH ALL LOCAL BUILDING SAFETY CODES AND ORDINANCES.
  - FIXTURES ARE SHOWN IN APPROXIMATE LOCATION. THE CONTRACTOR SHOW FIELD VERIFY THE ACTUAL PLACEMENT OF EACH FIXTURE UPON COMPLETION OF LANDSCAPE INSTALLATION.
  - ALL PATH LIGHTS ARE TO BE INSTALLED AT A MINIMUM OF 12 INCHES FROM ANY SIDEWALK OR VERTICAL STRUCTURE.
  - ALL LOW-VOLTAGE DIRECT BURIAL WIRE TO BE INSTALLED AT ± 6" BELOW FINISH GRADE PER ELECTRICAL CODE.
  - IN ORDER TO MINIMIZE FUTURE DISTURBANCE, ALL WIRE RUNS SHALL BE INSTALLED PARALLEL AND ADJACENT TO HARD SURFACES SUCH AS SIDEWALKS DRIVEWAYS AND WALLS.
  - THE CONTRACTOR SHALL BE RESPONSIBLE FOR INSTALLING SLEEVES UNDER ALL HARDSCAPE SURFACES USING A MINIMUM 1 INCH PVC PIPE. ALL UNDERGROUND SPICES SHALL BE 1/4-ABBRATED AND INSTALLED IN UNDERGROUND J-BOXES WITH WATER TIGHT CONNECTIONS LEAVING 12 INCHES OF EXCESS WIRE SLACK.
  - AN EXTERIOR 120 -VOLT ELECTRICAL OUTLETS SHALL BE GFI PROTECTED AS PER NATIONAL ELECTRICAL CODE.
  - ALL TRANSFORMERS PLUGGED INTO AN OUTDOOR RECEPTACLE SHALL HAVE AN "IN USE" COVER. CONTRACTOR SHALL INSTALL TAYMAC TYPE COVERS AT ALL OUTLETS.
  - ALL PLUG-IN TRANSFORMERS SHALL HAVE A DRIP LOOP IN THE POWER CORD.
  - ALL EXPOSED CONDUITS SHALL BE PAINTED TO MATCH SURROUNDINGS.
  - THE INSTALLING CONTRACTOR SHALL BE RESPONSIBLE FOR ADJUSTING THE FIXTURES AT NIGHT TO HELP ELIMINATE GLARE AND TO ENSURE OPTIMUM LIGHTING EFFECT.
  - CONTRACTOR TO VERIFY A MINIMUM OF 10 VOLTS AT THE LAST AT THE LAST FIXTURE FOR OPTIMAL OPERATION.
  - CONTRACTOR TO CENTER FEED THE SYSTEM WHEN AT ALL POSSIBLE AND VERIFY ALL WIRE CONNECTIONS ARE AT THE FIXTURES.
  - ALL WIRE CONNECTIONS AT FIXTURES SHALL BE MADE USING WATER TIGHT CONNECTIONS.

EXTERIOR BUILDING LIGHTING SCHEDULE									
TAG	DESCRIPTION	FIXTURE MFR	FIXTURE MODEL	LAMP	LUMENS	WATTS	VOLTS	CRI	COLOR TEMP
RX1	SOFFIT LIGHT	WAC	LOTOS 5"	LED	740	9	LINE	90	3000K
W1	ENTRY SCONCE	SAVOY HOUSE	HANCOCK 23	LED BULB	450	5	LINE	90	2700K

LIGHTING SCHEDULE

SYMBOL	MANUFACTURER/MODEL/DESCRIPTION	QTY	DETAIL
---	LIGHT CRAFT - E26 ARCHITECTURAL STRING LAMP: LED, 1W, 2400	200LF	
■	B-K LIGHTING - BOLLARD 90 DEGREE FACE PLATE ALUMINUM, BRONZE LAMP: LED, 7W, 2700	40	
☒	SPJ-SCSL - RECESSED WALL AND STEP LIGHT MATTE BRONZE - 2700K - 12V	48	

- LIGHTING NOTES:
- ALL PROPOSED EXTERIOR LIGHTING TO MEET DARK SKY CODE COMPLIANCE.
  - LIGHTING FIXTURE LOCATIONS SHOWN ARE DIAGRAMMATIC ONLY.
  - ALL LANDSCAPE LIGHTING TO BE LOW VOLTAGE LED LAMPS.
  - ALL EXTERIOR BUILDING WALL SCONCES AND SOFFITS TO BE 120V.
  - FINAL SELECTIONS PER CITY OF OJAI APPROVAL.



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OJAI PERMANENT SUPPORTIVE HOUSING  
PUBLIC WORKS YARD  
611 S. MONTGOMERY ST, OJAI, CA. 93023  
APN # 023-0-120-020



LANDSCAPE LIGHTING PLAN

REVISIONS	
NAME	DATE

PHASE  
DESIGN  
DEVELOPMENT

NOT FOR CONSTRUCTION

JOB NUMBER: 25-01 DM

ORIGIN DATE 12.23.24

PLOT DATE 07.25.25


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SHEET 10 OF 14

L-9







#### GENERAL LIGHTING NOTES:

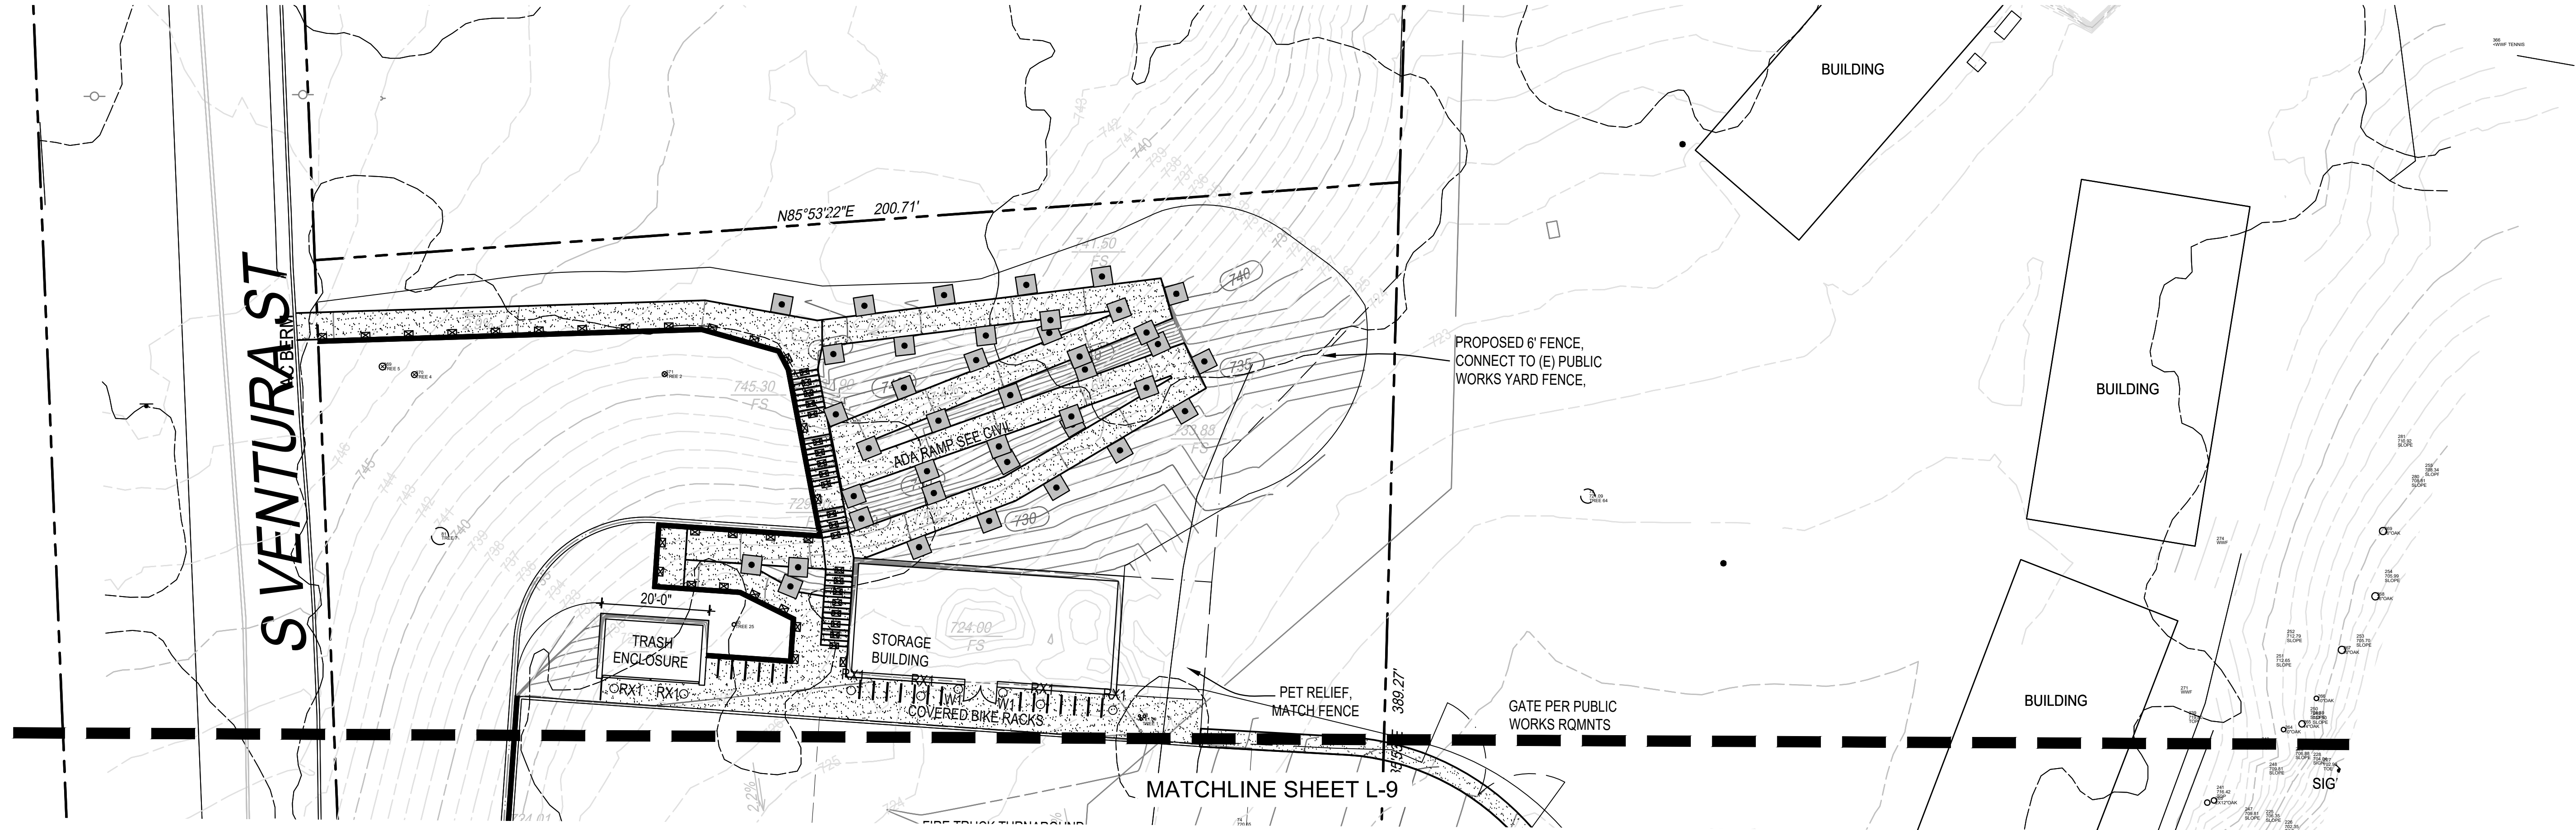- THIS PLAN IS INTENDED FOR LANDSCAPE LIGHTING PURPOSES ONLY. ALL LIGHTING FIXTURES AND TRANSFORMERS SHALL BE INSTALLED PER MANUFACTURERS SPECIFICATIONS. IT IS THE CONTRACTORS RESPONSIBILITY TO MAINTAIN COMPLIANCE WITH ALL LOCAL BUILDING SAFETY CODES AND ORDINANCES.
- FIXTURES ARE SHOWN IN APPROXIMATE LOCATION. THE CONTRACTOR SHALL FIELD VERIFY THE ACTUAL PLACEMENT OF EACH FIXTURE UPON COMPLETION OF LANDSCAPE INSTALLATION.
- ALL PATH LIGHTS ARE TO BE INSTALLED AT A MINIMUM OF 12 INCHES FROM ANY SIDEWALK OR VERTICAL STRUCTURE.
- ALL LOW-VOLTAGE DIRECT BURIAL WIRE TO BE INSTALLED AT 4" BELOW FINISH GRADE PER ELECTRICAL CODE.
- IN ORDER TO MINIMIZE FUTURE DISTURBANCE, ALL WIRE RUNS SHALL BE INSTALLED PARALLEL AND ADJACENT TO HARD SURFACES SUCH AS SIDEWALKS, DRIVEWAYS AND WALLS.
- THE CONTRACTOR SHALL BE RESPONSIBLE FOR INSTALLING SLEEVES UNDER ALL HARDSCAPE SURFACES USING A MINIMUM 1 INCH PVC PIPE. ALL UNDERGROUND SPLICES SHALL BE UL-RATED AND INSTALLED IN UNDERGROUND JUNCTIONS WITH WATER TIGHT CONNECTIONS LEAVING 12 INCHES OF EXCESS WIRE SLACK.
- ALL EXTERIOR 120 - VOLT ELECTRICAL OUTLETS SHALL BE GFI PROTECTED AS PER NATIONAL ELECTRICAL CODE.
- ALL TRANSFORMERS PLUGGED INTO AN OUTDOOR RECEPTACLE SHALL HAVE AN "IN USE" COVER. CONTRACTOR SHALL INSTALL TAYMAC TYPE COVERS AT ALL OUTLETS.
- ALL PLUG-IN TRANSFORMERS SHALL HAVE A DRIP LOOP IN THE POWER CORD.
- ALL EXPOSED CONDUITS SHALL BE PAINTED TO MATCH SURROUNDINGS.
- THE INSTALLING CONTRACTOR SHALL BE RESPONSIBLE FOR ADJUSTING THE FIXTURES AT NIGHT TO HELP ELIMINATE GLARE AND TO ENSURE OPTIMUM LIGHTING EFFECT.
- CONTRACTOR TO VERIFY A MINIMUM OF 10 VOLTS AT THE LAST AT THE LAST FIXTURE FOR OPTIMAL OPERATION.
- CONTRACTOR TO CENTER FEED THE SYSTEM WHEN AT ALL POSSIBLE and VERIFY ALL WIRE CONNECTIONS ARE AT THE FIXTURES.
- ALL WIRE CONNECTIONS AT FIXTURES SHALL BE MADE USING WATER TIGHT CONNECTIONS.

#### EXTERIOR BUILDING LIGHTING SCHEDULE

TAG	DESCRIPTION	FIXTURE MFR	FIXTURE MODEL	LAMP	LUMENS	WATTS	VOLTS	CRI	COLOR TEMP	FINISH	MOUNTING INFO
RX1	SOFFIT LIGHT	WAC	LOTOS 5"	LED	740	9	LINE	90	3000K	BLACK	18" FROM WALL
W1	ENTRY SCENCE	SAVOY HOUSE	HANCOCK 23	LED BULB	450	5	LINE	90	2700K	BRONZE	90" TO TOP OF FIXTURE

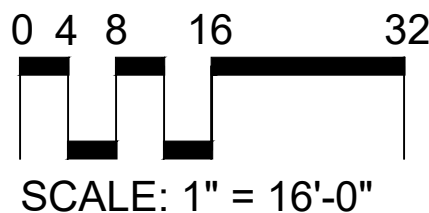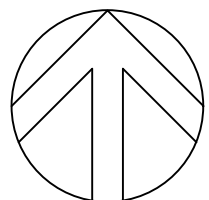

#### LIGHTING SCHEDULE

SYMBOL	MANUFACTURER/MODEL/DESCRIPTION	QTY	DETAIL
---	LIGHT CRAFT - E26 ARCHITECTURAL STRING LAMP: LED, 1W, 2400	200LF	
■	B-K LIGHTING - BOLLARD 90 DEGREE FACE PLATE ALUMINUM, BRONZE LAMP: LED, 7W, 2700	40	
☒	SPJ-SCSL - RECESSED WALL AND STEP LIGHT MATTE BRONZE - 2700K - 12V	48	

#### LIGHTING NOTES:

- ALL PROPOSED EXTERIOR LIGHTING TO MEET DARK SKY CODE COMPLIANCE.
- LIGHTING FIXTURE LOCATIONS SHOWN ARE DIAGRAMMATIC ONLY.
- ALL LANDSCAPE LIGHTING TO BE LOW VOLTAGE LED LAMPS.
- EXTERIOR BUILDING WALL SCONCES AND SOFFITS TO BE 120V.
- FINAL SELECTIONS PER CITY OF OJAI APPROVAL.



DESIGN DEVELOPMENT, NOT FOR CONSTRUCTION

#### LANDSCAPE LIGHTING PLAN

##### REVISIONS

NAME	DATE

##### PHASE

DESIGN  
DEVELOPMENT

NOT FOR CONSTRUCTION

JOB NUMBER: 25-01 DM

ORIGIN DATE 12.23.24

PLOT DATE 07.25.25

DRAWN BY: KD

CHECKED BY: KN

SHEET 11 OF 14


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


LANDSCAPE LIGHTING FIXTURES:

LOUVERED BOLLARD STAR LED

DATE: PROJECT: TYPE: IP66 RATED

CATALOG NUMBER: LOGIC

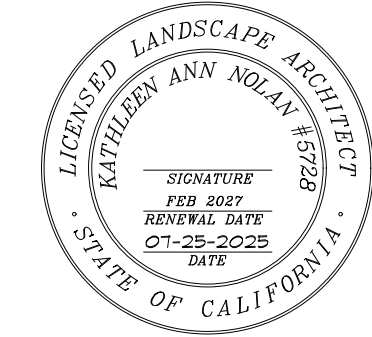

\*Designed for use with 12 VAC LED Transformer

\*Requires magnetic low voltage dimmer

\*Please use Adjust or Lume philosophy to determine desired intensity

CATALOG NUMBER: LOGIC

Example: BSL - LED - e100 - A7 - BLU - C - 24 - TR620

MATERIAL

Aluminum

SERIES

BSL - Louvered Bollard Star

SOURCE

LED - with Integral Dimming Driver (25W min. load when dimmed)\*

LED TYPE

e100 - 5W LED/2700K e104 - 5W LED/2700K 90CRI  
e101 - 5W LED/3000K e105 - 5W LED/3000K 90CRI  
e102 - 5W LED/4000K e106 - 5W LED/3500K 90CRI  
e103 - 5W LED/Amber

ADJUSTABLE LUMINE OUTPUT INTENSITY\*\*\*

A5 (Standard), A6, A7, A8, A9, A4, A3, A2, A1

FINISH (See page 2 for full-color swatches)

Standard Finishes (BZP, BZW, BLF, BLK, WHP, WHW, SAP, VER)  
Premium Finish (ABP, AMG, AQW, BCM, BOC, BPP, CAP, CMG, CRM, HUS, NBP, OCP, PMG, SDS, SMG, TFX, WCR, WRS)

LOUVER

C - 30° Angle, Round Pattern

OVERALL HEIGHT


12"

OPTIONS

Add set of 10' increments for 18", 24" or 30"  
TR620 - TR620 Electronic Transformer (105-300 VAC, 50/60 Hz, non-dimming)  
PP - Standard Aluminum Base with 12" Power Pole Stake  
SF - Stability Range (For use with Power Pipe)

LOUVERED BOLLARD STAR LED

DATE: PROJECT: TYPE: IP66 RATED

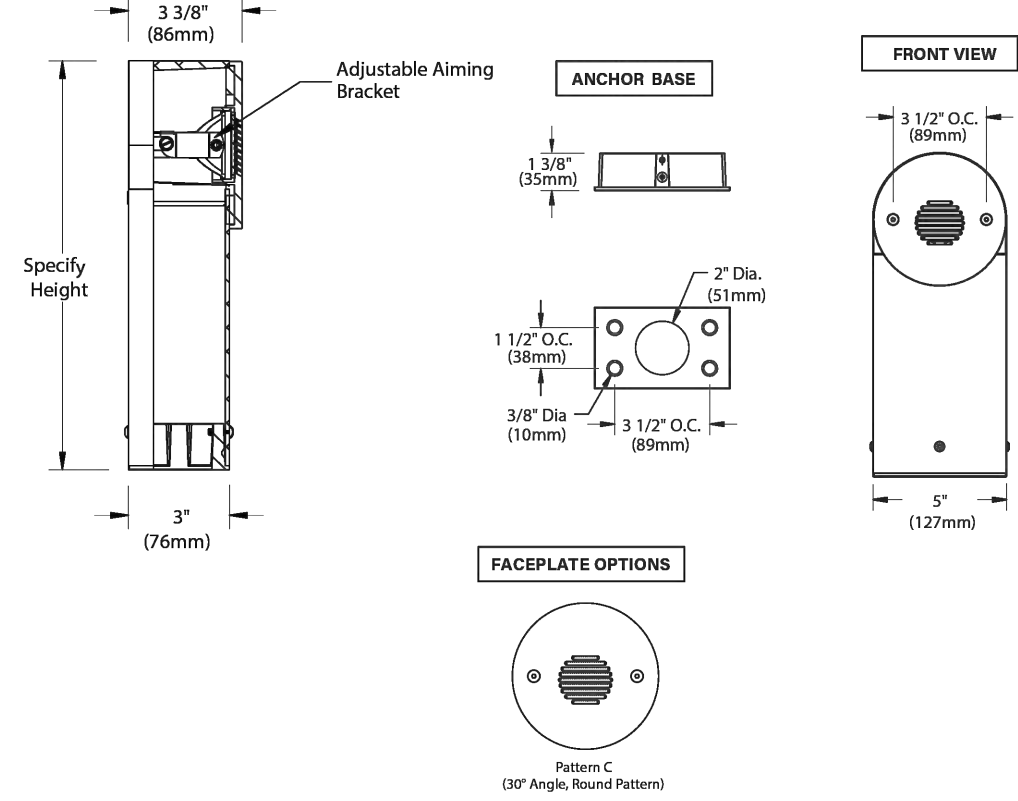

Specify Height

Adjustable Aiming Bracket

ANCHOR BASE

FRONT VIEW

FACEPLATE OPTIONS

STANDARD FINISHES

Satin Black (BLP)

Satin Bronze (BZP)

Satin White (WHP)

Satin Aluminum

Black Chrome (BCM)

Bronze Winkle (BZW)

White Winkle (WHW)

Vende (VER)

Artificial Brass Powder (ABP)

Cream (CRM)

PREMIUM FINISHES

Cascade Mtn. Granite (CMG)

Rocky Mtn. Granite (RMG)

Sierra Mtn. Granite (SMG)

Alaskan Mtn. Granite (AMG)

Textured Forest (TFP)

Black Chrome (BCM)

Beige (BOE)

Weathered Copper (WCW)

Old Copper (OCW)

Hunter Green (HUG)

Sagebrush Desert Sandstone (SDS)

Weathered Iron (WRI)

Clear Anodized Powder (CAP)

Antique White (AQW)

Natural Brass Powder (NBP)

Click Here to view larger, full-color swatches of all available finishes on our website.

B-K LIGHTING


MADE IN THE USA

818.418.5880 | INFO@BKLIGHTING.COM | BKLIGHTING.COM

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
BISTRO COLLECTION



PROJECT: DATE: TYPE: CATALOG #

E26 ARCHITECTURAL STRING

BK-E26



STRING DIMENSIONS

SOCKET DIMENSIONS

SOCKET TOP VIEW


+ String and lamps are sold separately

KEY FEATURES

PRODUCT SPECIFICATIONS


CERTIFICATION

BISTRO COLLECTION



PROJECT: DATE: TYPE: CATALOG #

S14 LAMPS (OUTDOOR/INDOOR RATED)



12V FILAMENT LED

120V FILAMENT LED

S14 LAMP DIMENSIONS

LED-BK-S14-1-12-FIL

LED-BK-S14-1-120-FIL

DECORATIVE BISTRO SHADES

PETAL SHADE

HAMMERED SHADE

PYRAMID SHADE

B-K LIGHTING - BOLLARD - BRONZE WINKLE - 2700K - 12V

EXTERIOR BUILDING LIGHTING FIXTURES:


SPJ LIGHTING Inc.

ARCHITECTURAL, LANDSCAPE & OUTDOOR LIGHTING

SPECIFICATION SHEET

Recessed Light

SPJ-SCSL



MODEL: SPJ-SCSL  
MATERIAL: Cast Brass  
FINISH OPTION: Black  
ELECTRICAL: 12V or 120V  
ENGINE: Specify  
WATTAGE: Specify  
LUMENS: Specify

FINISHES

Matte Bronze (MBR)

Vende (V)

Moss (M)

Black (B)

Rusty (R)

Satin Brass (SB)

Agate Brass (AG)

Rose Copper (RC)

Natural Copper (NC)

PVD Polished (PVD)

PVD Satin (PVD)

PVD Graphite (PVD)

PVD Bronze (PVD)

PVD Black (PVD)

COLOR TEMPERATURE

2500K

2700K

3000K

4000K

5000K

6000K

Amber

Custom options are available upon request


ELECTRICAL

12V

120V

Custom luminaire packages are available upon request

Wet Listed



Hancock 1-Light Outdoor Wall Lantern in Matte Black

Size: 3-41/2" H x 9-1/4" W

UPC: 822023063209

RE STOCK

Create a subtle first impression outside your home with this Savoy House Hancock 1-light outdoor wall lantern. Crafted in a timeless classic style, it features a boldly sloped roof, amphiprotic hood detailing and panes of clear seeded glass that ensure a beautiful, dramatic glow. A generously sized backplate helps to cover any hole left from replacing previous fixtures and the versatile black finish means that Hancock goes well with anything. Use this lantern beside your front and side doors or above your garage door. This fixture is 8.5" wide and 22.75" tall. It extends 9.25" from the wall. Uses one standard size light bulb of up to 60 watts not included.

Specifications

Product Information

Model

8-4112-01

UPC

822023063209

Finish

Matte Black

Finish Category

Black

Product Dimensions

Item Weight

4.650000

Item Height

22.75

Item Width

8.50

Item Length

9.25

Backplate Height

9.25

Backplate Width	9.25
Backplate Length	9.25
Bulb Information	
Bulb Included	No
Bulb Type	Incandescent/LED
Bulb Base	E26
Recommended Bulb Shape	A19
Bulb Wattage	60W
Dimmable	Yes
Shade Information	
Shade Included	Yes
Other Details	
Voltage	120V
Material	Aluminum, Glass
Lighting Rating	ETL-ULCS
Style	Traditional
Assembly Required	Minimal Required
Country of Manufacture	China

WAC LIGHTING

Lotos R 4"

Adjustable Downlight SCCT

Model

Q R4BA2R

Beam

Q W 50

Color Temp & CRI

Q R4S 2700K/5000K/3500K/4000K/5000K - 90

Lumens

775

CRI

90

Finish

Q WT White

Example: R4BA2R-WRCS-BK

FEATURES

5-SCCT Switchable between 2700K and 5000K

Multiple LED array for uniform illumination

Rotatable multi-axis gimbal ring

Driver included

5-year warranty

SPECIFICATIONS

Construction

Steel with frosted TIR lens

Power

9W

Input

120-277 VAC, 50/60Hz

Dimming

ELV: 100-9V, TRAC: 100-9V

Light Source

Integrated LED

Lens

Translucent acrylic diffuser

Rated Life

50,000 Hours

Mounting

Heavy gauge retention clips secures fixture to ceiling

Cut Out

4"

Finish

Electrostatically powder coated White, Electrostatically powder coated Black

Coating Thickness

1/2" - 1"

Operating Temp

-41°F to 141°F (-40°C to 60°C)

Standards


ETL, cETL, Wet Location Listed, TIR, 24 JdB Compliant, Airtight, IC

FINISHES:

Black

White

LINE DRAWING:

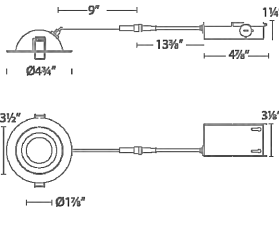

WAC LIGHTING

Lotos R 4"

Adjustable Downlight SCCT

Model

Q R4BA2R

Beam

Q W 50

Color Temp & CRI

Q R4S 2700K/5000K/3500K/4000K/5000K - 90

Lumens

775

CRI

90

Finish

Q WT White

Example: R4BA2R-WRCS-BK

FEATURES

5-SCCT Switchable between 2700K and 5000K

Multiple LED array for uniform illumination

Rotatable multi-axis gimbal ring

Driver included

5-year warranty

SPECIFICATIONS

Construction

Steel with frosted TIR lens

Power

9W

Input

120-277 VAC, 50/60Hz

Dimming

ELV: 100-9V, TRAC: 100-9V

Light Source

Integrated LED

Lens

Translucent acrylic diffuser

Rated Life

50,000 Hours

Mounting

Heavy gauge retention clips secures fixture to ceiling

Cut Out

4"

Finish

Electrostatically powder coated White, Electrostatically powder coated Black

Coating Thickness

1/2" - 1"

Operating Temp

-41°F to 141°F (-40°C to 60°C)

Standards


ETL, cETL, Wet Location Listed, TIR, 24 JdB Compliant, Airtight, IC

FINISHES:

Black

White

LINE DRAWING:

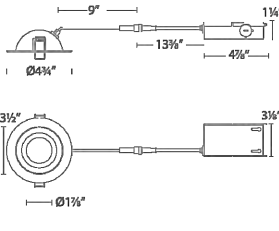

SPJ - RECESSED WALL AND STEP LIGHT - MATTE BRONZE - 2700K - 12V

ENTRY SCNCE

LIGHTING NOTES:

- LIGHTING FIXTURES MEET DARK SKIES FRIENDLY REQUIREMENTS.
- ALL LANDSCAPE LIGHTING TO BE LOW VOLTAGE LED LAMPS.
- ALL EXTERIOR BUILDING WALL SCONCES AND SOFFITTS TO BE 120V.

SOFFITT LIGHTS

DESIGN DEVELOPMENT, NOT FOR CONSTRUCTION

LICENSED LANDSCAPE ARCHITECT

SIGNATURE: FEB 2022

RENEWAL DATE: 07-25-2025

DATE: KATHLEEN ANN NOLAN

STATE OF CALIFORNIA

STUDIO LANDSCAPE CORPORATION

KATHLEEN NOLAN, PLA, ASLA


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LIGHTING SPEC. SHEETS

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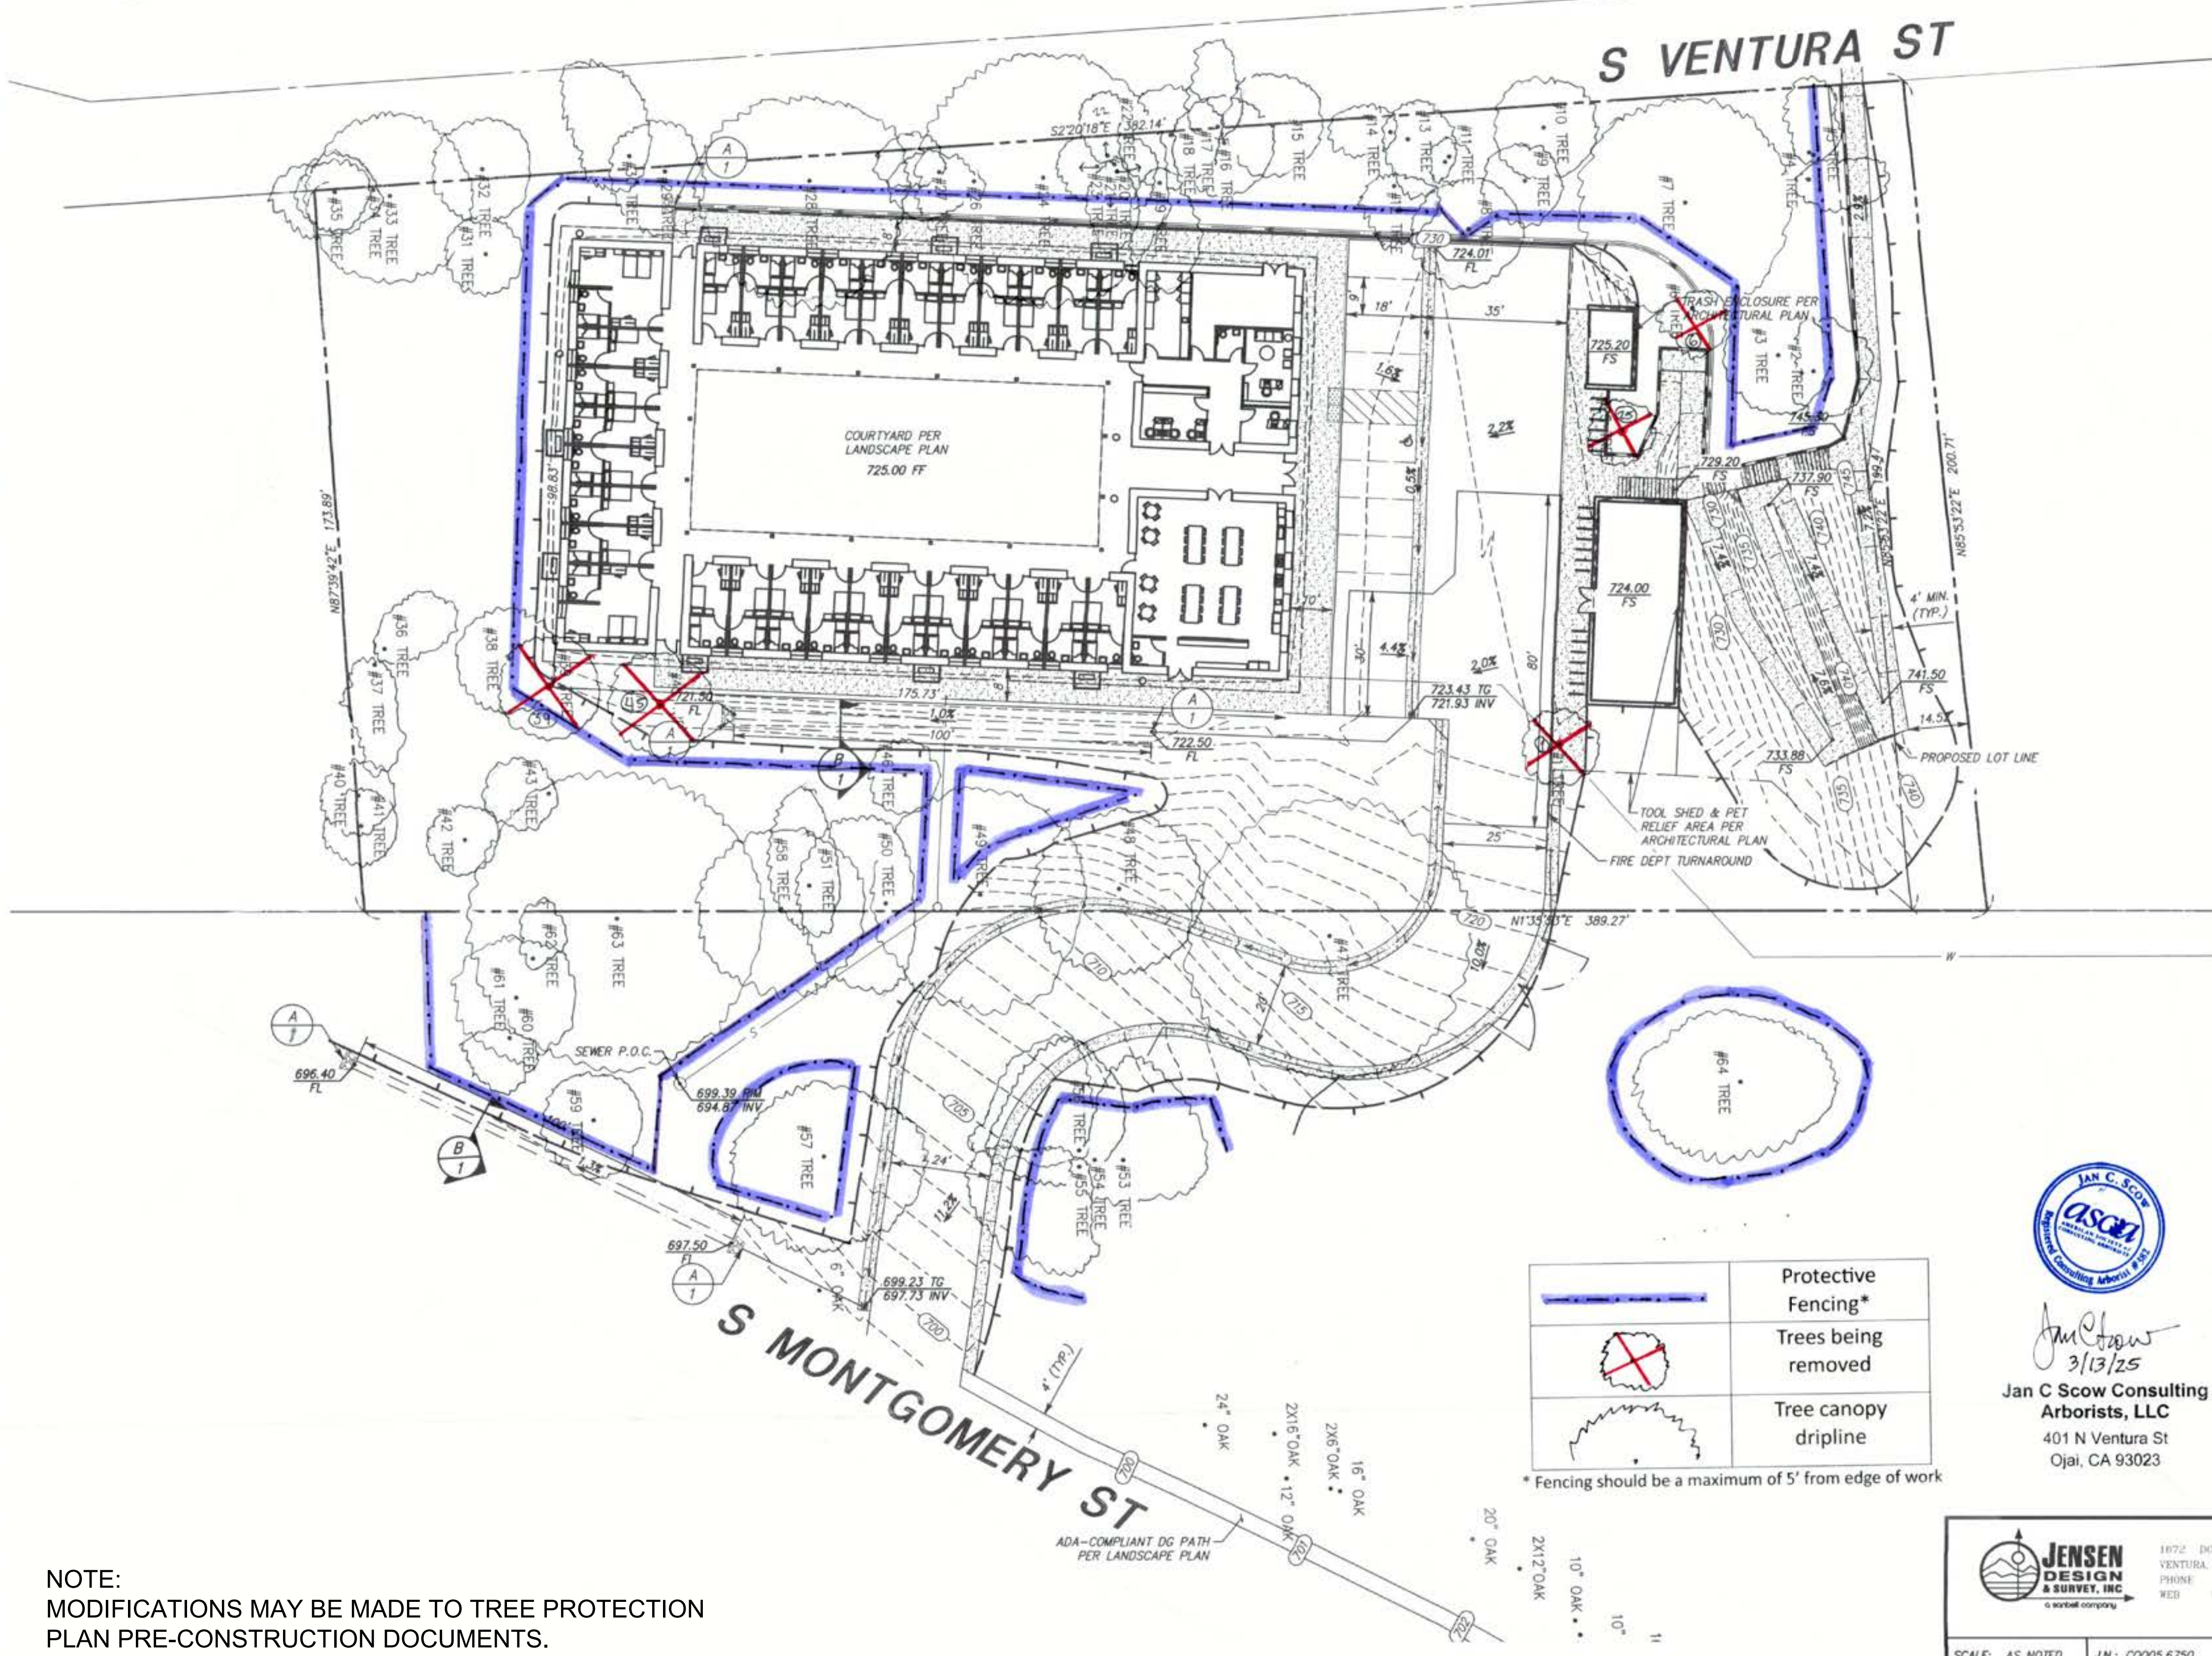
SHEET 12 OF 14

L-11

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TREE PROTECTION PLAN




LEGEND

PROPOSED	EXISTING
W WATER	STORM DRAIN
S SEWER	WATER
SD STORM DRAIN	SEWER
SM SEWER MANHOLE	GAS
SI STORM INLET	TELEPHONE
RR RIP-RAP	OVERHEAD ELEC.
FL FLOWLINE	WATER VALVE
TS TOP/TOE OF SLOPE	FIRE HYDRANT
RG RIBBON GUTTER	STREET LIGHT
CL CONTOUR LINE	CONTOUR LINE
DL DAYLIGHT LINE	STREET SIGN
F FENCE	
C CONCRETE	
AC AC PAVING	
DP DG PATH PER LANDSCAPE PLAN	


  

ABBREVIATIONS	
FS	FINISH SURFACE
FG	FINISH GRADE
INV	INVERT
TG	TOP OF GRATE
SW	SIDEWALK
EX	EXISTING
FL	FLOW LINE

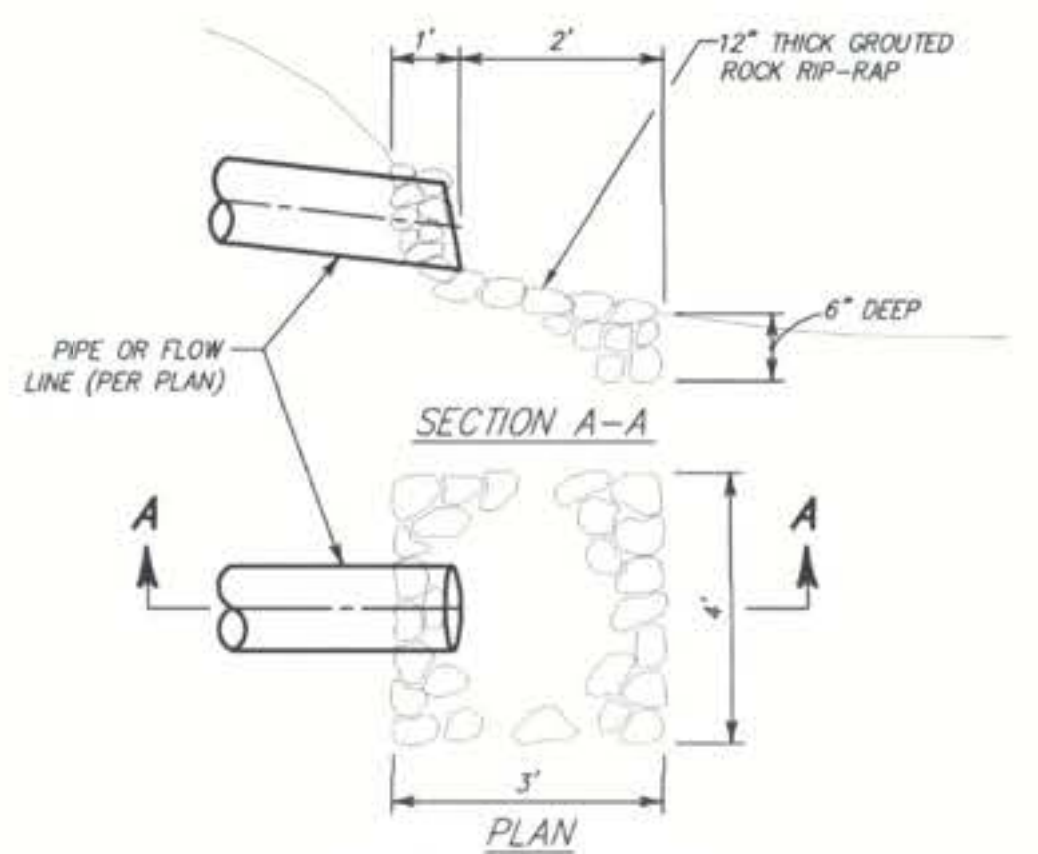

NOTE: ROCK SHALL BE FACING CLASS PER SECTION 200-1.6.2 OF STD. LAND DEVELOPMENT SPECIFICATIONS

**A RIP-RAP OUTLET DETAIL**  
NOT TO SCALE

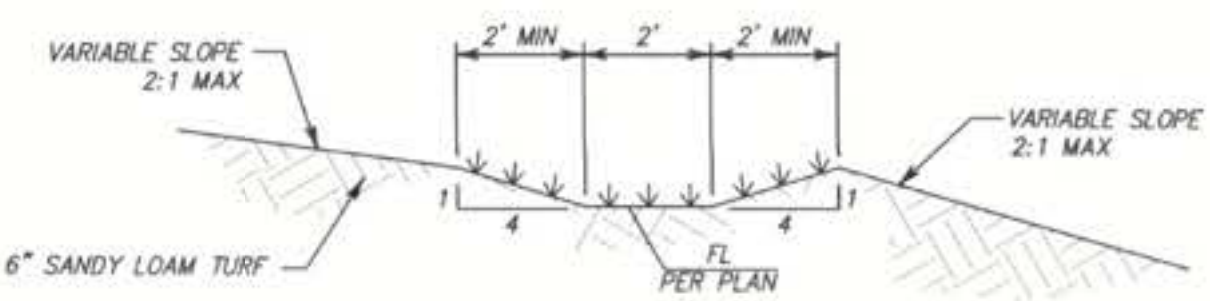

**B BIOSWALE DETAIL**  
NOT TO SCALE

	Protective Fencing*
	Trees being removed
	Tree canopy dripline

\* Fencing should be a maximum of 5' from edge of work



Jan C. Scow  
3/13/25  
Jan C Scow Consulting  
Arborists, LLC  
401 N Ventura St  
Ojai, CA 93023

**JENSEN DESIGN & SURVEY, INC.**  
1672 DONLON STREET  
VENTURA, CALIF. 93003  
PHONE: 805/654-6977  
WEB: WWW.JDSURV.COM

SCALE: AS NOTED J.N.: C0005.6750  
DATE: 3/13/25 DWG. NAME: 6750-01\_02-PGP.dwg

CONCEPT GRADING PLAN  
FOR  
OJAI DIGNITY MOVES

APN: 023-0-120-020  
City of Ojai

COUNTY OF VENTURA STATE OF CALIFORNIA

SHEET  
1  
OF 2

NOTE:  
MODIFICATIONS MAY BE MADE TO TREE PROTECTION  
PLAN PRE-CONSTRUCTION DOCUMENTS.

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**TREE PROTECTION PLAN**

REVISIONS	
NAME	DATE

PHASE  
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NOT FOR CONSTRUCTION

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CHECKED BY: KN  
SHEET 13 OF 14

**L-12**



PRELIMINARY TREE REMEDIATION VALUE	
EXISTING SPECIES	QUERCUS AGRIFOLIA (5)
REPLACEMENT COST	\$34,200.00
APPROVED COST	TBD

REPLACEMENT TREES	
SPECIES	
QUERCUS AGRIFOLIA	

REPLACEMENT VALUE		
TREE SIZE	VALUE	NUMBER OF TREES
24" BOX	\$500.00	0
36" BOX	\$1,400.00	0
48" BOX	\$2,700.00	0
60" BOX	\$6,000.00	6

The diagram illustrates the Tree Protection Zone (TPZ) for a tree. It shows the canopy dripline, the TPZ (5' from the dripline), the fence line (1' from the TPZ), and the tree protection fence (Chain Link). The fence is supported by 2" x 6" steel posts installed at 8' o.c. and is topped with a 5" thick layer of mulch. The fence is to be maintained at the existing grade unless otherwise indicated on the plans. The diagram also shows the trenching details, including the trench width (4') and the trench depth (4'). The trench is to be filled with mulch and the existing grade is to be maintained. The diagram is labeled "SECTION VIEW" and "See 'Trenching' in Report".

Canopy dripline

5'

TPZ, Tree Protection Zone, 5' from dripline

Fence line, 1' from TPZ or as shown on plan.

Tree Protection fence: Chain Link.

2" x 6" steel posts installed at 8' o.c.

5" thick layer of mulch.

Maintain existing grade with the tree protection fence unless otherwise indicated on the plans.

4'

4'

SECTION VIEW


See "Trenching" in Report

Outside of the tree canopy dripline, the contractor can open trench.

**A** **TREE PROTECTION ZONE**

NOT TO SCALE

1. TREES WITH REDUCED ROOT SYSTEMS WILL NEED SUPPLEMENTAL IRRIGATION DURING CONSTRUCTION AND AFTER IF WINTER RAINS ARE NOT ADEQUATE.

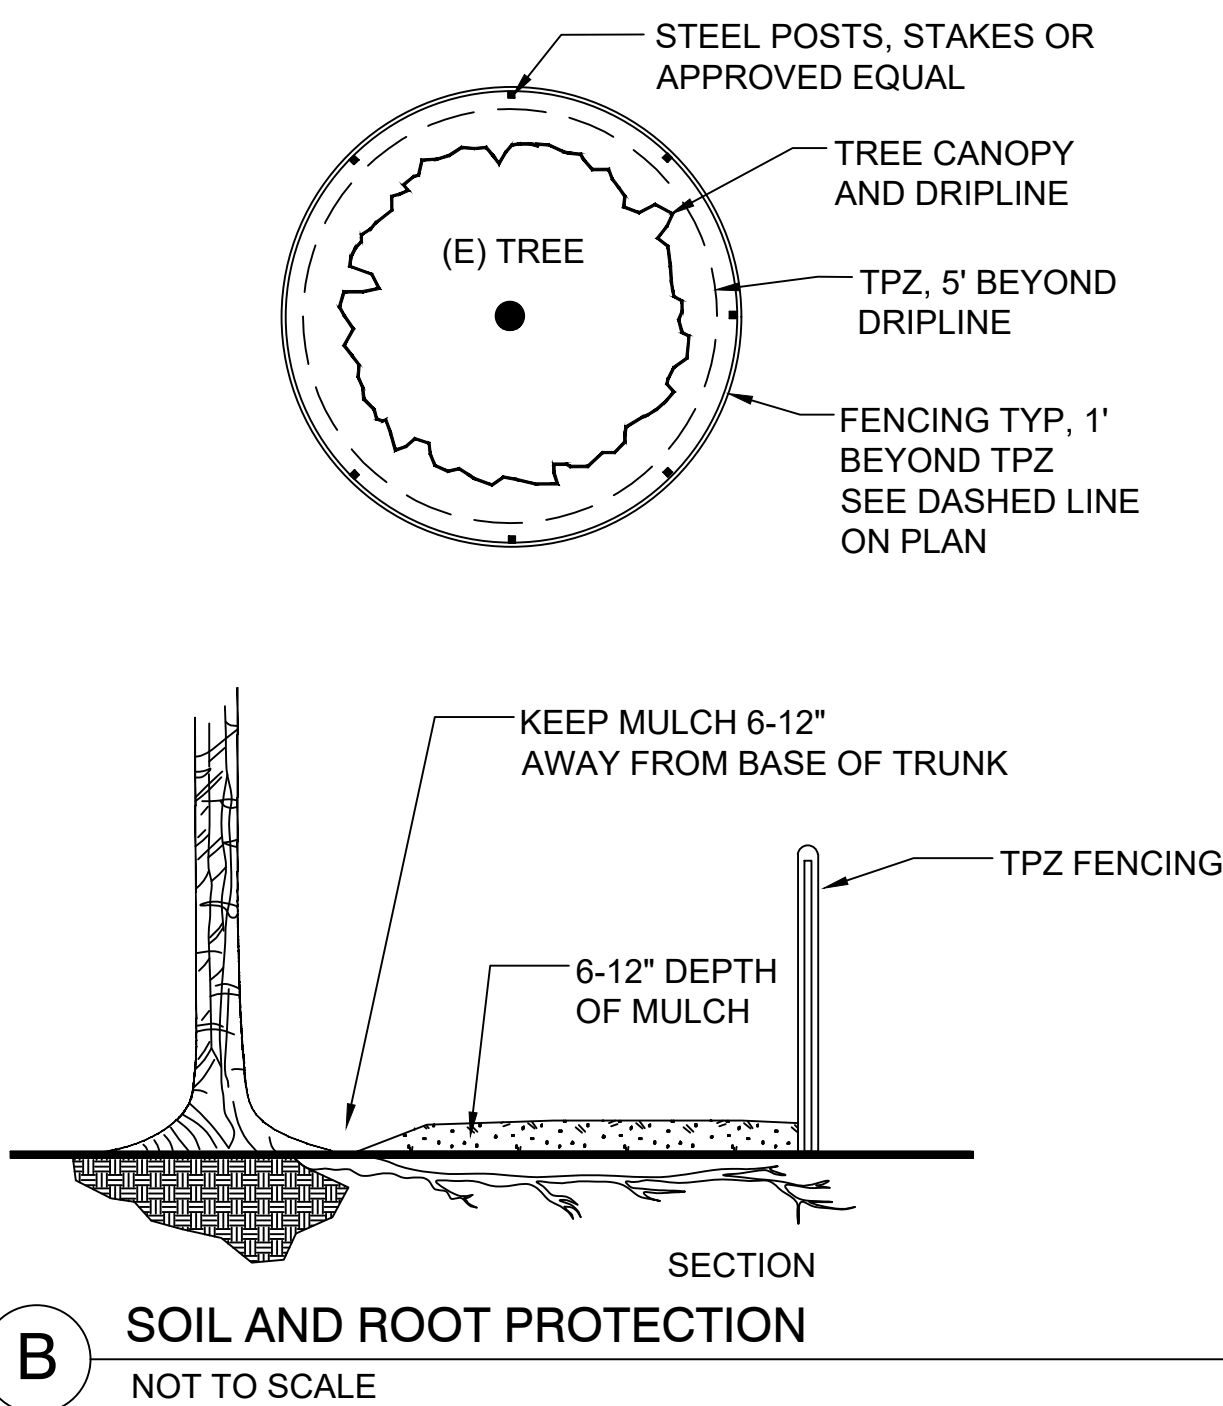[illegible]

1-800-227-2600  
TWO WORKING DAYS BEFORE YOU DIG

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DRAWN BY: KD

CHECKED BY: KN

SHEET 14 OF 14

# L-13



ABBREVIATIONS

AB	ANCHOR BOLT	E	EXISTING	KO	KNOCK OUT	S	SOUTH
ABV	ABOVE	EA	EACH	KT	KITCHEN	SAF	SELF ADHERED FLASHING
AC	ACOUSTIC CEILINGS	EB	EXPANSION BOLT			SC	SOILD CORE
ACC	ACCESS	EJ	EXPANSION JOINT	LAM	LAMINATED	SC	SHADING COEFFICIENT
ACP	ASPHALT CONCRETE PAVEMENT	EL	ELEVATION	LAV	LAVATORY	SCHED	SCHEDULE
ACST	ACOUSTIC	ELEC	ELECTRICAL	LF	LINEAL FEET	SCP	SOLID COMPOSITE PANEL
ACT	ACOUSTIC CEILING TILE	ELEV	ELEVATOR	LHND	LEFT HAND	SD	SMOKE DETECTOR
ACW	ALUMINUM CURTAIN WALLS	EMER	EMERGENCY	LIQ	LIQUID	SEC	SECTION
AD	AREA DRAIN	EMF	ENTRANCE MATS AND FRAMES	LL	LIVE LOAD	SED	SEE ELECTRICAL DRAWINGS
ADD	ADDITIVE	ENCL	ENCLOSURE	LOC	LOCATION	SF	SQUARE FEET; SQUARE FOOT
ADJ	ADJUSTABLE	EQ	EQUAL	LP	LOW POINT	SG	SAFETY GLASS
AFF	ABOVE FINISHED FLOOR	EQIP	EQUIPMENT	LT	LIGHT	SH	SHELF
AGG	AGGREGATE	EST	ESTIMATE			SHR	SHOWER
ALT	ALTERNATE	EW	EACH WAY	MANUF	MANUFACTURED	SHT	SHEET
ALUM	ALUMINUM	EXP	EXPANDED/EXPANSION	MAS	MASONRY	SHTG	SHEATHING
AP	ACCESS PANEL	EXPO	EXPOSED	MAT.	MATERIAL	SI	SQUARE INCH(ES)
APPL	APPLIED/APPLYING	EXT	EXTERIOR	MAX	MAXIMUM	SIM	SIMILAR
APPROX	APPROXIMATE			MB	MACHINE BOLT	SLD	SEALED
ARCH	ARCHITECTURAL	F/F	FINISH TO FINISH	MC	MEDICINE CABINET	SM	SHEET METAL
ASPH	ASPHALT	FA	FIRE ALARM	MDO	MEDIUM DENSITY OVERLAY	SMD	SEE MECHANICAL DRAWINGS
AUTO	AUTOMATIC	FB	FLAT BAR	MECH	MECHANICAL	SMS	SHEET METAL SCREW
		FD	FLOOR DRAIN	MEMB	MEMBRANE	SOG	SLAB ON GRADE
BD	BOARD	FDC	FIRE DEPARTMENT CONNECTION	MEZZ	MEZZANINE	SPEC	SPECIFICATION
BD	BITUMINOUS DAMPPROOFING	FDN	FOUNDATION	MFR	MANUFACTURER	SS	STAINLESS STEEL
BITUM	BITUMINOUS	FE	FIRE EXTINGUISHER	MFS	METAL FRAMED SKYLIGHTS	SSD	SEE STRUCTURAL DRAWINGS
BLDG	BUILDING	FEC	FIRE EXTINGUISHER CABINET	MH	MAN HOLE	STA	STATION
BLK	BLOCK	FFE	FINISHED FLOOR ELEVATION	MIN	MINIMUM	STD	STANDARD
BLKG	BLOCKING	FH	FIRE HYDRANT/FULL HEIGHT	MIR	MIRROR	STL	STEEL
BM	BEAM	FHC	FIRE HOSE CABINET	MISC	MISCELLANEOUS	STOR	STORAGE
BO	BOTTOM OF	FHMS	FLAT HEAD MACHINE SCREW	MNT	MOUNTED	STRCT	STRUCTURAL
BOT	BOTTOM	FHS	FIRE HOSE STATION	MO	MASONRY OPENING	SUSP	SUSPENDED
BP	BUILDING PAPER	FHWS	FLAT HEAD WOOD SCREW	MTL	METAL	SYM	SYMMETRICAL
BRG	BEARING	FIN.	FINISH	MUL	MULLION		
BRK	BRICK	FLOUR	FLOURESCENT	MWP	METAL WALL PANEL	T	TREAD
BSMT	BASEMENT	FLSH'G	FLASHING			T & G	TOUNGE AND GROOVE
BW	BENTONITE WATERPROOFING	FOC	FACE OF COLUMN/CONCRETE			T.O.	TOP OF
BYND	BEYOND	FOF	FACE OF FINISH			T.O.P.	TOP OF PAVEMENT
		FOIC	FURNISHED BY OWNER - INSTALLED BY CONTRACTOR	N	NORTH	T.O.W.	TOP OF WALL
C/C	CENTER TO CENTER	FOIO	FURNISHED BY OWNER - INSTALLED BY OWNER	N/A	NOT APPLICABLE	TB	THERMALLY BROKEN
CAB.	CABINET	FOR	FACE OF MASONRY	NIC	NOT IN CONTRACT	TEL	TELEPHONE
CB	CATCH BASIN	FOS	FACE OF STUDS	NOM	NOMINAL	TERM	TERMINATION
CBU	CONCRETE BOARD UNDERLAYMENT	FR	FRAME	NR	NOISE REDUCTION	TG	TEMPERED GLASS
CEM	CEMENT	FRP	FIBERGLASS REINFORCED PANEL	NTS	NOT TO SCALE	THK	THICK
CER	CERAMIC	FRPF	FIREPROOF			TJI	TRUSS JOIST
CF	CUBIC FEET	FRWT	FIRE RETARDANT WOOD TREATMENT			TMR	THERMOPLASTIC MEMBRANE ROOF
CIP	CAST IN PLACE	FT	FOOT OR FEET			TOC	TOP OF CURB
CJ	CONTROL JOINT	FTG	FOOTING	O/	OVER	TOS	TOP OF SLAB; TOP OF STEEL
CLG	CEILING	FURR	FURRING	OA	OVER ALL	TPH	TOILET PAPER HOLDER
CLKG	CAULKING	FUT	FUTURE	OBS	OBSURE	TS	TUBULAR STEEL
CLO	CLOSET	FVIC	FURNISHED BYVENDOR - INSTALLED BY CONTRACTOR	OC	ON CENTER	TYP	TYPICAL
CLR	CLEAR	FVIV	FURNISHED BY VENDOR - INSTALLED BY VENDOR	OD	OUTSIDE DIAMETER		
CPD	COMPOUND	FW	FULL WIDTH	ODR	OVERFLOW DRAIN		
CMU	CONCRETE MASONRY UNIT			OH	OVERHEAD	UNO	UNLESS NOTED OTHERWISE
CNTR	COUNTER	G	GRID	OPH	OPPOSITE HAND	USK	UTILITY SINK
COL.	COLUMN	GA	GAUGE	OPNG	OPENING	VB	VAPOR BARRIER
COMP	COMPRESSIBLE	GAL.	GALLON	OPP	OPPOSITE		
CONC	CONCRETE	GALV	GALVANIZED				
CONN	CONNECTION	GB	GYPSUM BOARD	P	PAINT		
CONSTR	CONSTRUCTION	GC	GENERAL CONTRACTOR	PAC	PRECAST ARCHITECTURAL CONCRETE	VCT	VINYL COMPOSITION TILE
CONTR	CONTRACTOR	GL	GLASS	PC	PRE-CAST	VEN	VENEER
CORR	CORRIDOR	GLAM	GLUE LAMINATED	PCF	POUNDS PER CUBIC FOOT	VERT	VERTICAL
CPT	CARPET	GR	GRADE	PERF	PERFORATED	VEST.	VENTIBULE
CPT-1	CARPET TILE XXXXX	GRL	GUARD RAIL	PERP	PERPENDICULAR	VG	VERTICAL GRAIN
CPT-2	CARPET TILE XXXXX	GWB	GYPSUM WALL BOARD	PIV	PRESSURE INDICATOR VALVE	VR	BELOW GRADE VAPOR RETARDERS
CPT-3	CARPET XXXXXXXXXX	GYP	GYPSUM	PL	PROPERTY LINE	VT	VINYL TILE
CT	CERAMIC TILE			PLAM	PLASTIC LAMINATE		
CTR	CENTER	HB	HOSE BIB	PLAS	PLASTER	W	WEST
CTSK	COUNTERSUNK	HC	HOLLOW CORE	PLYWD	PLYWOOD	W/	WITH
CWC	CHILLED WATER CABINET	HD	HEAD	PNL	PANEL	W/O	WITH OUT
		HDO	HIGH DENSITY OVERLAY	PR	PAIR	WAB	WATER & AIR BARRIER
D.O.	DOOR OPENING	HDR	HEADER	PRJ	PROJECTION SCREENS	WB	WHITE BOARD
DB	DESIGN BUILD	HDW	HARDWOOD	PSF	POUNDS PER FOOT	WC	WATER CLOSET
DBL	DOUBLE	HDWR	HARDWARE	PSI	POUNDS PER INCH	WD	WOOD
DEMO	DEMOLITION	HM	HOLLOW METAL	PTN	PARTITION	WDW	WINDOW
DIA	DIAMETER	HORIZ	HORIZONTAL	PTS	PLUGGED & TOUCH SANDED	WF	WIDE FLANGE
DIM	DIMENSION	HP	HIGH POINT	PTW	PRESSURE TREATED WOOD	WG	WIRED GLASS
DISCONT	DISCONTINUOUS	HR	HOUR	PVC	POLYVINYL CHLORIDE	WH	WATER HEATER
DISP	DISPENSER	HT	HEIGHT			WL	WATER LINE
DL	DEAD LOAD	HVAC	HEATING/VENTILATING/AIR CONDITIONING	R	RISER	WP	WATERPROOF
DN	DOWN	HW	HOT WATER	RA	RETURN AIR	WP	WOOD PANELING
DP	DAMPPROOFING	HWT	HOT WATER TANK	RAD	RADIUS	WP'G	WATERPROOFING
DR	DOOR			RB	RESILIENT BASE AND ACCESSORIES	WR	WATER RESISTANT
DS	DOWN SPOUT	ID	INSIDE DIAMETER	RD	ROOF DRAIN	WS	WEATEHRSTRIP
DSP	DRY STANDPIPE	IN.	INCH	REC	RECOMMENDATIONS	WSCT	WAINSCOT
DT	DRAIN TILE	INCL	INCLDE; INCLUDED; INCLUDING	REF	REFERENCE	WSG	WIRE SAFETY GLASS
DTL	DETAIL	INSUL	INSULATION	REFR	REFRIDGERATOR	WT	WEIGHT
DTLG	DETAILING	INSUL-1	FOAM BOARD INSULATION	REQ	REQUIRED	WWF	WELDED WIRE FABRIC
DWG	DRAWING	INSUL-2	BATT AND BLANKET INSULATION	REV	REVISION; REVISIONS; REVISED		
DWGS	DRAWINGS	INSUL-3	FOAMED IN PLACE INSULATION	RGTR	REGISTER	X	TYPE X
		INT	INTERIOR	RH	ROUND HEAD		
		INV	INVERT	RHND	RIGHT HAND		
				RM	ROOM		
				RNF	REINFORCED; REINFORCING		
		JB	JUNCTION BOX	RO	ROUGH OPENING		
		JC	JANITOR'S CLOSET	RSL	RESILIENT		
		JF	JOINT FILLER	RWL	RAIN WATER LEADER		
		JT	JOINT	RWS	ROLLING WINDOW SHADES		

SYMBOLS LEGEND

STRUCTURAL GRID			
DOOR REFERENCE		REFERENCE DOOR SCHEDULE	
DETAIL REFERENCE		DRAWING NUMBER SHEET NUMBER	EXISTING DOOR
BUILDING ELEVATION REFERENCE		DRAWING NUMBER SHEET NUMBER	NEW DOOR
			NEW WALL
BUILDING SECTION REFERENCE		DRAWING NUMBER SHEET NUMBER	EXISTING WALL
WALL SECTION REFERENCE		DRAWING NUMBER SHEET NUMBER	FINISH FLOOR ELEVATION
			NORTH REFERENCE
			FLAG NOTE
INTERIOR ELEVATION REFERENCE		DIRECTION DRAWING NUMBER SHEET NUMBER	KEYNOTE
			ASSEMBLY KEYNOTE
ELEVATION REFERENCE OR DATUM			WINDOW REFERENCE
WALL / PARTITION REFERENCE			TOILET
			LAVATORY



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Ojai Permanent Supportive Housing

611 South Montgomery Street, Ojai California

Drawn By: DJ  
Checked By:  
Job No. 2407

Revisions:

No.	Date	By

NOT FOR CONSTRUCTION

25 July 2025

Design  
Development

Abbreviations  
Notes & Legends

A0.1



PLUMBING CALCS - 2022 CALIFORNIA PLUMBING CODE:

ROOM NAME	FUNCTION	QNTY	AREA (NET)	AREA TOTAL	OCCUPANT LOAD FACTOR	OCCUPANTS
GATHERING SPACE	ASSEMBLY	1	1224	1224	30	41
PANTRY	BUSINESS	1	178	178	150	1
SECURITY OFFICE	BUSINESS	1	115	115	150	1
CHECK IN OFFICE	BUSINESS	1	213	213	150	1
SUPPORT OFFICE	BUSINESS	1	206	206	150	1
HALL	BUSINESS	1	255	255	150	2
LAUNDRY	BUSINESS	1	212	212	150	1
MECHANICAL	BUSINESS	1	348	348	5000	0
COMMON RESTROOM	BUSINESS	2	52	104	150	1
COURTYARD - ENTRY HALL	PREFUNCTION AREA	1	6231	6231	0	0

**TOTAL** **49** (25 MALE, 25 FEMALE)  
<50 UNISEX RR ALLOWED  
CPC 422.2 Exception 3 allows for (1) unisex restroom, two are proposed  
(1) Drinking fountain required

OCCUPANCY CALCULATIONS:

ROOM NAME	FUNCTION	QNTY	AREA (NET)	AREA TOTAL	OCCUPANT LOAD FACTOR	OCCUPANTS
GATHERING SPACE	ASSEMBLY	1	1224	1224	15	82
PANTRY	BUSINESS	1	178	178	150	1
SECURITY OFFICE	BUSINESS	1	115	115	150	1
CHECK IN OFFICE	BUSINESS	1	213	213	150	1
SUPPORT OFFICE	BUSINESS	1	206	206	150	1
HALL	BUSINESS	1	255	255	150	2
LAUNDRY	BUSINESS	1	212	212	150	1
MECHANICAL	STORAGE/MECH	1	348	348	300	1
COMMON RESTROOM	BUSINESS	2	52	104	150	1
SINGLE UNITS	R-2 RESIDENTIAL	28	190	5320	1 PER UNIT	28
DOUBLE UNITS	R-2 RESIDENTIAL	2	380	760	2 PER UNIT	4
COURTYARD - ENTRY HALL	PREFUNCTION AREA	1	6231	6231	0	0
<b>TOTAL</b>						<b>123</b>
STORAGE BUILDING	STORAGE/MECH	1	1000	1000	300	3

CODE SUMMARY:

APPLICABLE BUILDING CODE  
2022 CALIFORNIA BUILDING CODE (CBC).  
2022 CALIFORNIA GREEN BUILDING CODE  
2022 CALIFORNIA ELECTRICAL CODE  
2022 CALIFORNIA MECHANICAL CODE  
2022 CALIFORNIA PLUMBING CODE  
24 CFR § 982.605 - SRO: HOUSING QUALITY STANDARDS

CHAPTER 3 OCCUPANCY AND USE  
THE RESIDENTIAL PORTION OF THE PROJECT FALLS UNDER GROUP R-2 (RESIDENTIAL) OCCUPANCY. RESIDENTS' STAY MAY EXCEED 30 DAYS. ADMINISTRATIVE AND SUPPORTIVE SERVICES: GROUP B (BUSINESS)  
GATHERING SPACE: GROUP A-2 (ASSEMBLY)  
EXTERIOR COURTYARD - OCCUPANCY, PREFUNCTION AREA WITH NO OCCUPANT LOAD

A LETTER FROM THE CITY OF OJAI WILL CONFIRM THAT FOOD WILL NOT BE PREPARED ON-SITE, AND THREE MEALS PER DAY WILL BE PREPARED OFF SITE AND DELIVERED TO THE GATHERING SPACE FOR THE RESIDENTS.

24 CFR § 982.605 - SRO: HOUSING QUALITY STANDARDS.  
USE: SINGLE ROOM OCCUPANCY (SRO) HUD MIN SIZE 110 SF WITH 4 SF OF CLOSET SPACE.

CHAPTER 4 SPECIAL REQUIREMENTS  
SECTION 402 REQUIRES 1-HOUR SEPARATION BETWEEN R2 UNITS.

CHAPTER 5 HEIGHTS AND AREAS  
CONSTRUCTION TYPE V-B  
MAXIMUM AREA: TABLE 506  
SPRINKLERED A-2 = 24,000 SF  
SPRINKLERED R-2 = 28,000 SF  
SPRINKLERED B = 36,000 SF  
TOTAL PROPOSED BUILDING AREA: 10,286 SF

CHAPTER 6 TYPES OF CONSTRUCTION  
FIRE SEPARATION: TABLE 601 AND 602 REQUIRE FIRE RATED EXTERIOR WALLS WITHIN 10' OF PROPERTY LINE. ALL BUILDING WALLS ARE GREATER THAN 10' FROM THE PROPERTY LINE AND THEREFORE NOT REQUIRED TO BE RATED.

CHAPTER 7A  
PROJECT TO COMPLY WITH VERY HIGH FIRE SEVERITY REQUIREMENTS.  
INTUMESCENT ROOF VENTS  
NON-COMBUSTIBLE STUCCO CLADDING  
CLAY TILE ROOFING OVER CLASS A MEMBRANE ASSEMBLY

CHAPTER 10  
1017.2 ESTABLISHES EXIT DISTANCE FOR FULLY SPRINKLERED R2 BUILDINGS TO BE 250'.  
SEE DIAGRAM.


CHAPTER 11  
CBC1104A.1 ALL GROUND FLOOR UNITS WILL BE ADAPTABLE AND ON AN ACCESSIBLE ROUTE.  
CBC 11B-233.3 REQUIRES 5% OF UNITS TO BE ACCESSIBLE; = MINIMUM OF 2 ACCESSIBLE UNITS.  
AT LEAST ONE UNIT SHALL BE FULLY ACCESSIBLE WITH MOBILITY FEATURES.  
ALL UNITS PROPOSED TO BE ACCESSIBLE.

LEGEND

- CRASH BAR EGRESS HARDWARE
- 1-HOUR FIRE RATED PARTITION WALL
- SMOKE & CARBON MONOXIDE ALARM, INTERCONNECTED
- COMMUNICATION FEATURES IN UNIT
- ACCESSIBLE UNIT
- MAX. TRAVEL DISTANCE
- ACCESSIBLE PATH OF TRAVEL
- CROSS SLOPE NOT TO EXCEED 2%
- RUNNING SLOPE NOT TO EXCEED 5%
- ASSEMBLY
- BUSINESS
- STORAGE/MECHANICAL
- PREFUNCTION AREA
- R-2 RESIDENTIAL
- FIRE EXTINGUISHER CABINET
- FIRE EXTINGUISHER ON BRACKET

LIFE SAFETY PLAN GENERAL NOTES:

- BUILDING TO BE FULLY SPRINKLERED DESIGN-BUILD AND PERMITTED UNDER DEFERRED SUBMITTAL.
- CONTRACTOR TO PROVIDE DESIGN-BUILD FIRE ALARM.
- SEE CIVIL AND LANDSCAPE DRAWINGS FOR EXTERIOR PAVING INFORMATION.
- PARTITION WALLS BETWEEN RESIDENTIAL UNITS TO BE 1-HOUR RATED PER ASTM E119.
- BUILDING IS GREATER THAN 10' FROM PROPERTY LINE AND FULLY SPRINKLERED, EXTERIOR WALLS NOT REQUIRED TO BE RATED.
- ALL UNITS TO BE PROVIDED WITH INTERCONNECTED SMOKE AND CARBON MONOXIDE ALARMS.
- UNITS WITH COMMUNICATION FEATURES TO INCLUDE VISUAL ALARMS FOR PERSONS WITH HEARING IMPAIRMENTS.

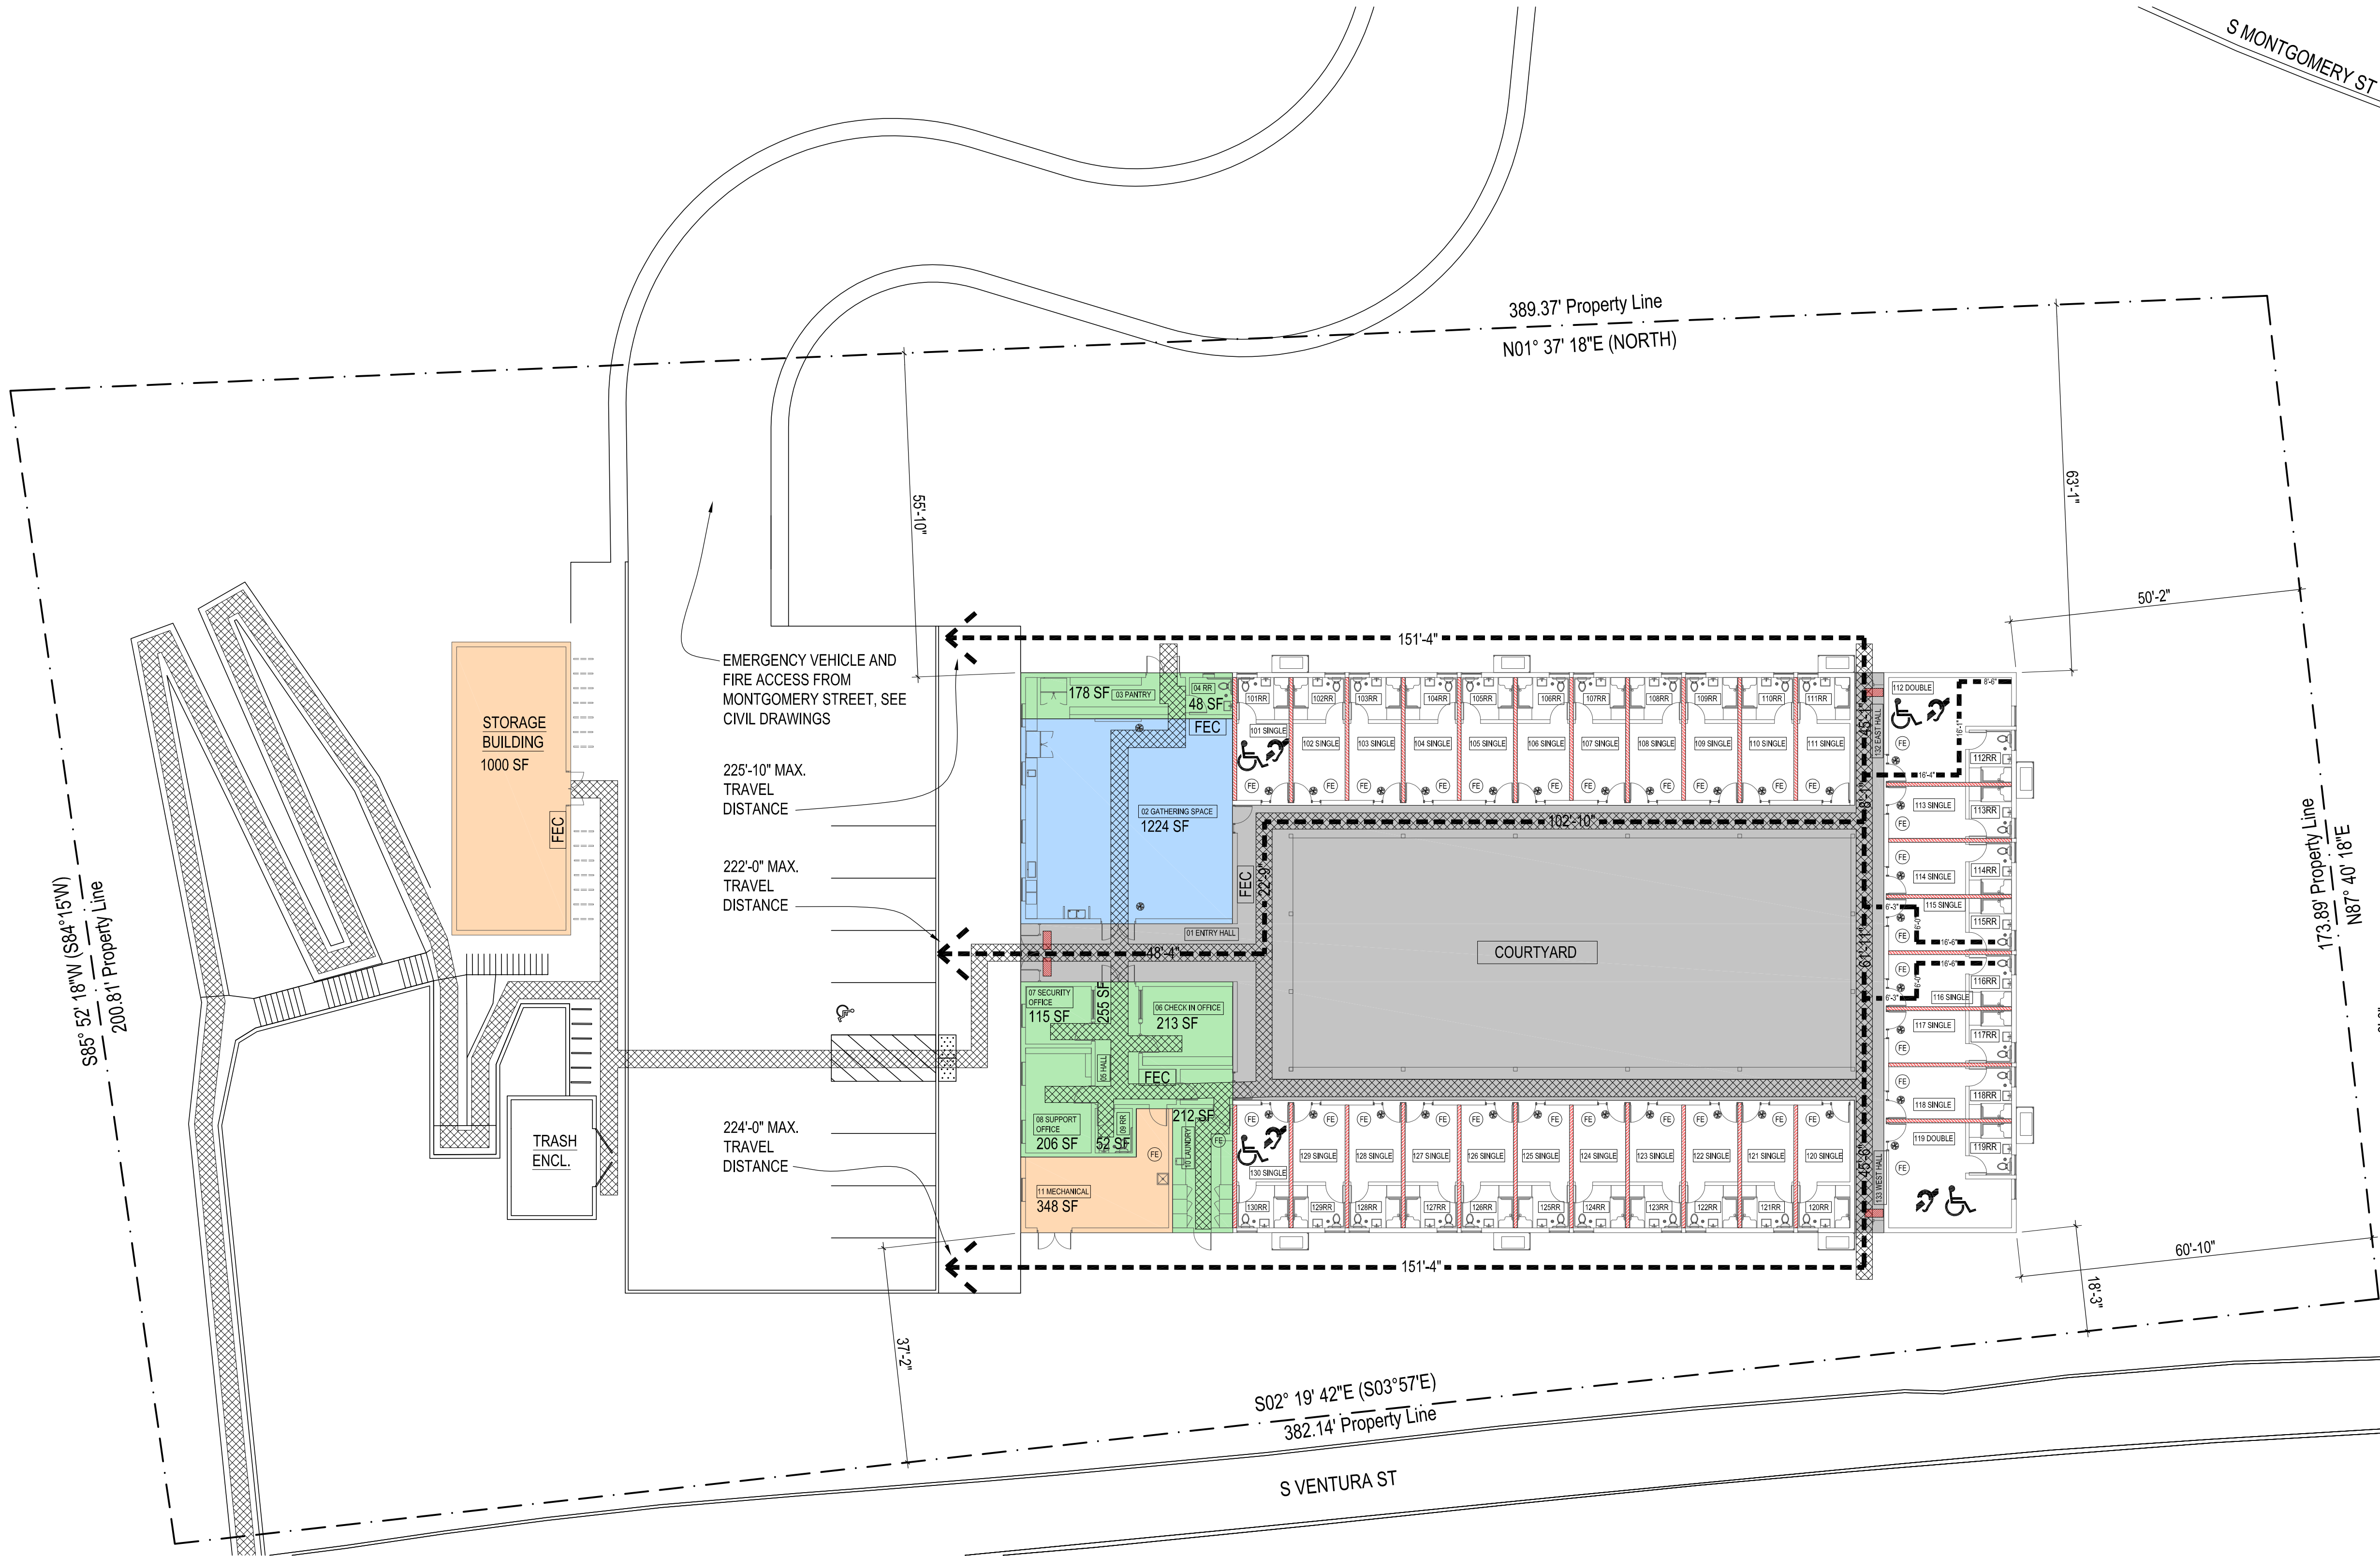

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# Ojai Permanent Supportive Housing

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Checked By: Job No. 2407

Revisions:  
No. Date By

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25 July 2025

Design  
Development


Life Safety  
Plan

A0.2



# RESIDENTIAL MANDATORY MEASURES, SHEET 1 (January 2023)

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# RESIDENTIAL MANDATORY MEASURES, SHEET 2 (January 2023)
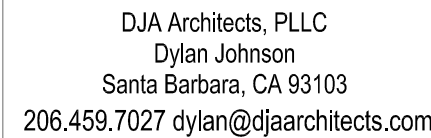
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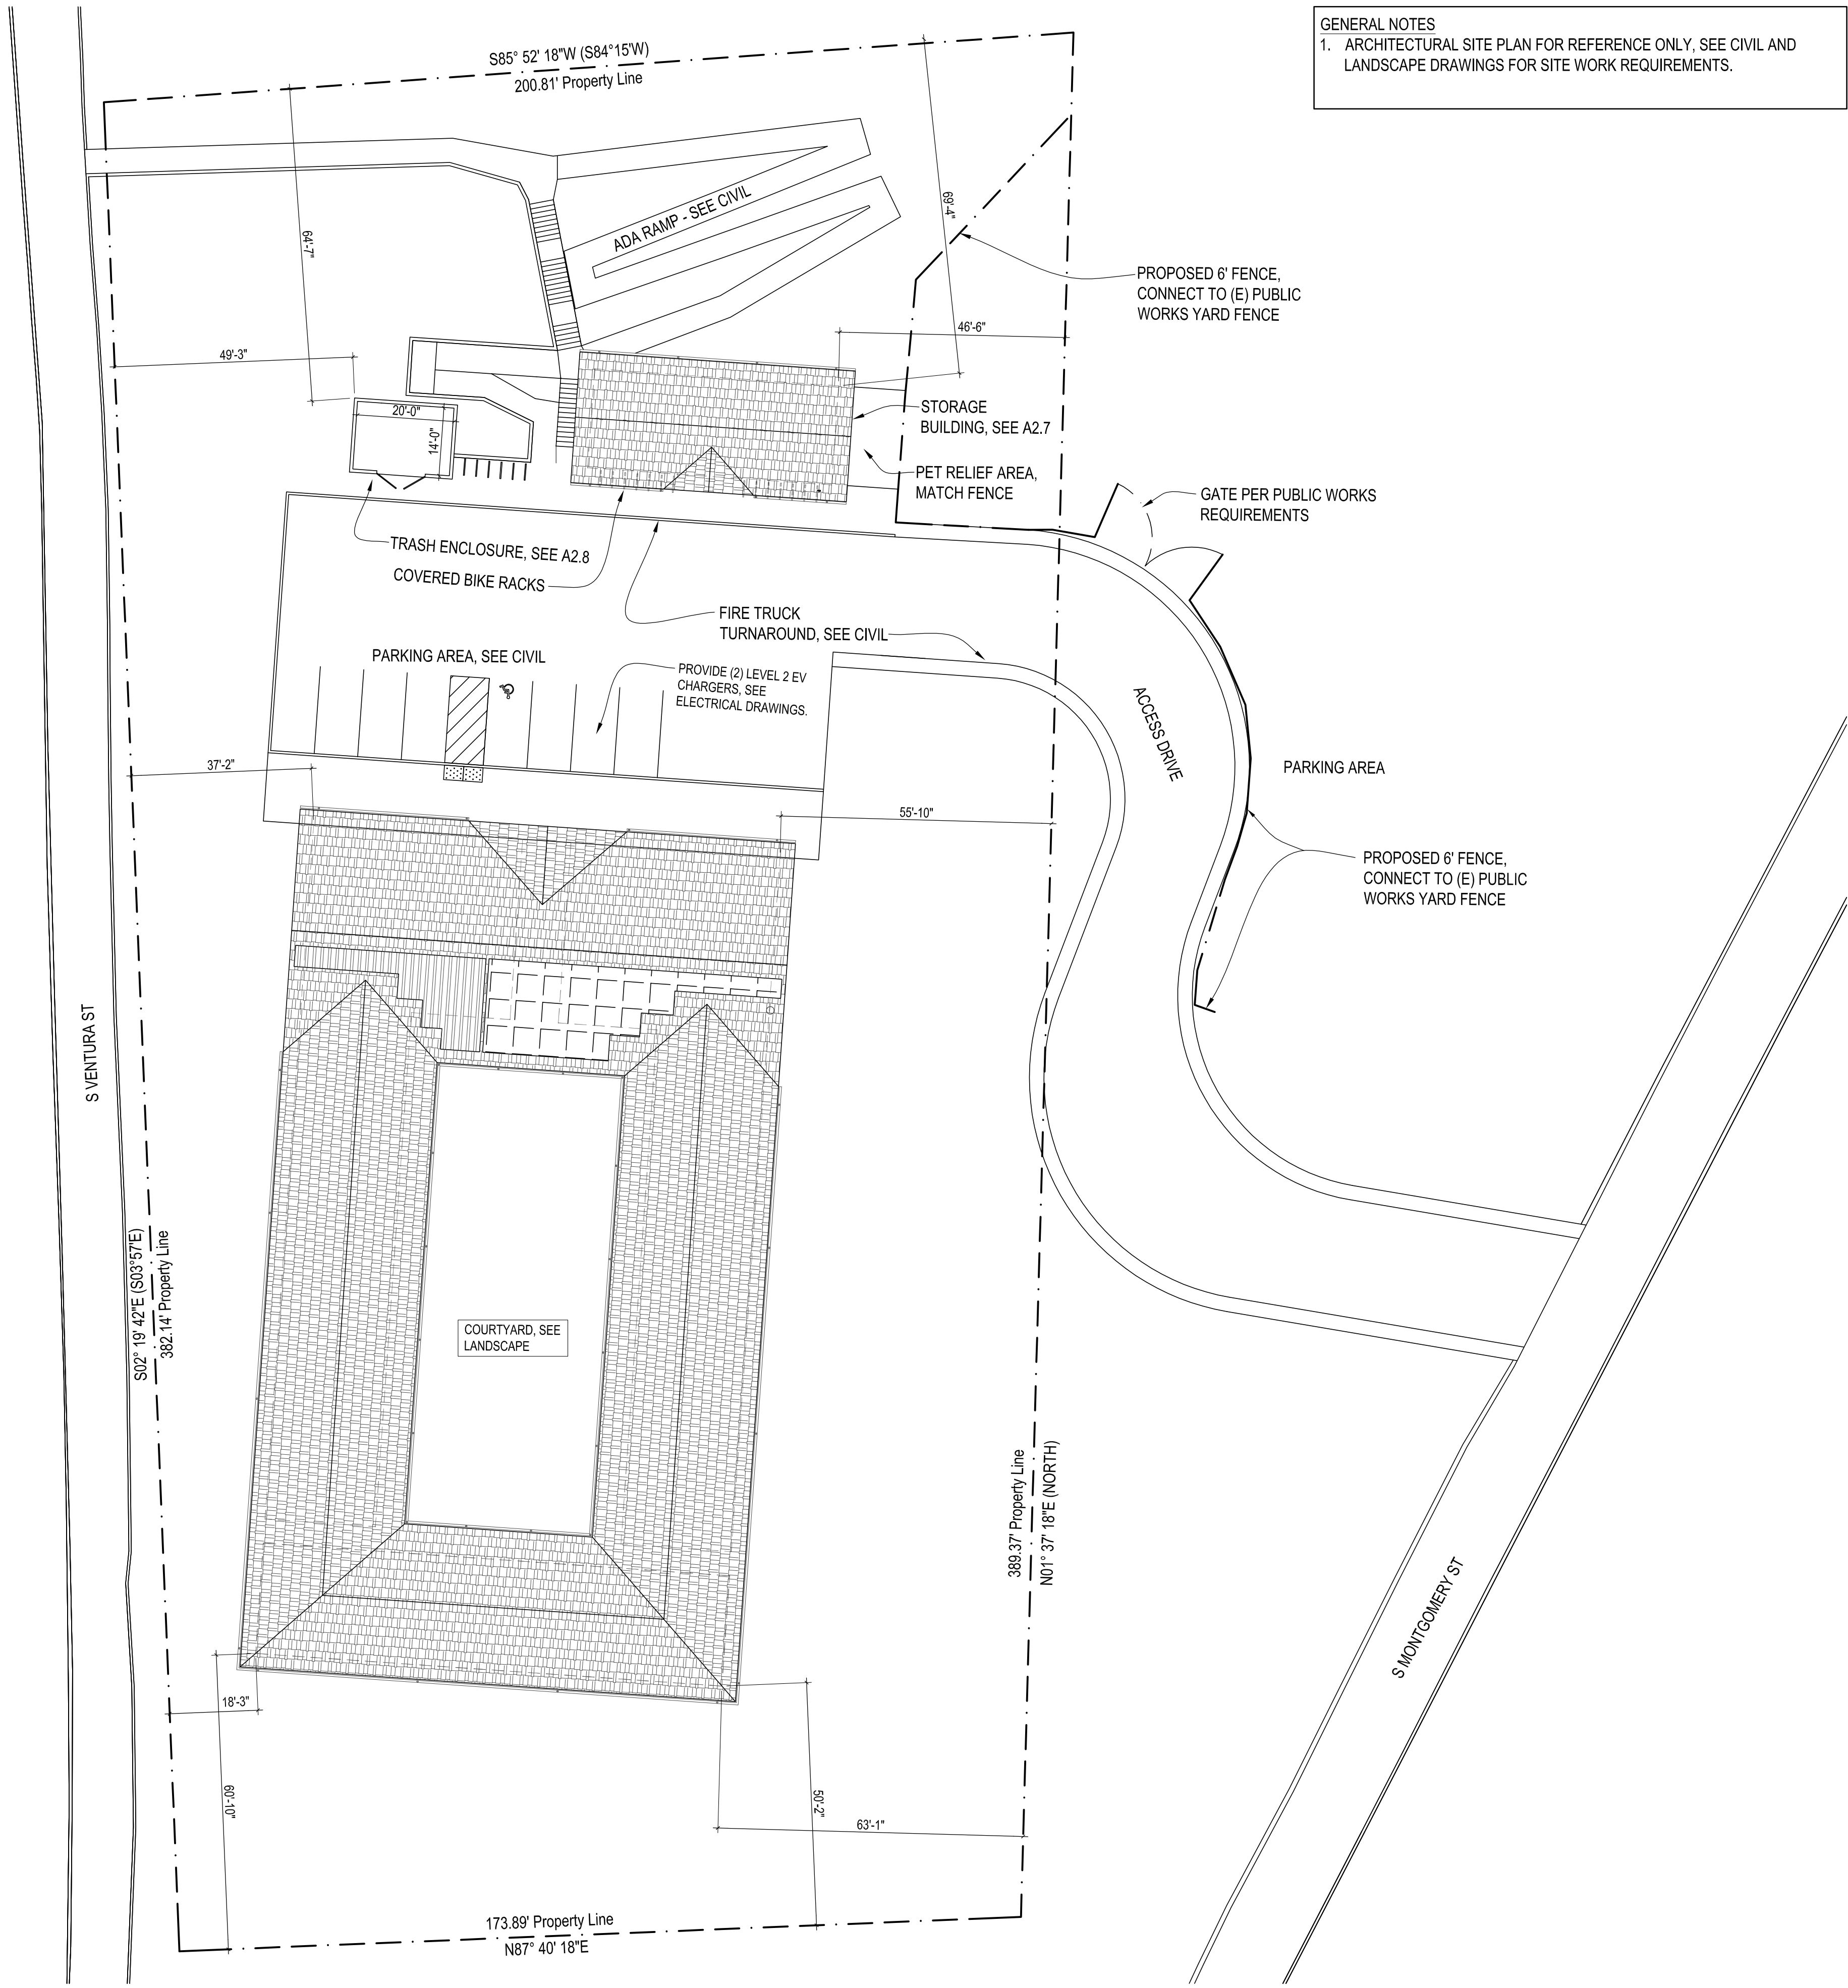
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## Design development

# A0.5





GENERAL NOTES  
1. ARCHITECTURAL SITE PLAN FOR REFERENCE ONLY, SEE CIVIL AND LANDSCAPE DRAWINGS FOR SITE WORK REQUIREMENTS.

# Ojai Permanent Supportive Housing

611 South Montgomery Street, Ojai California

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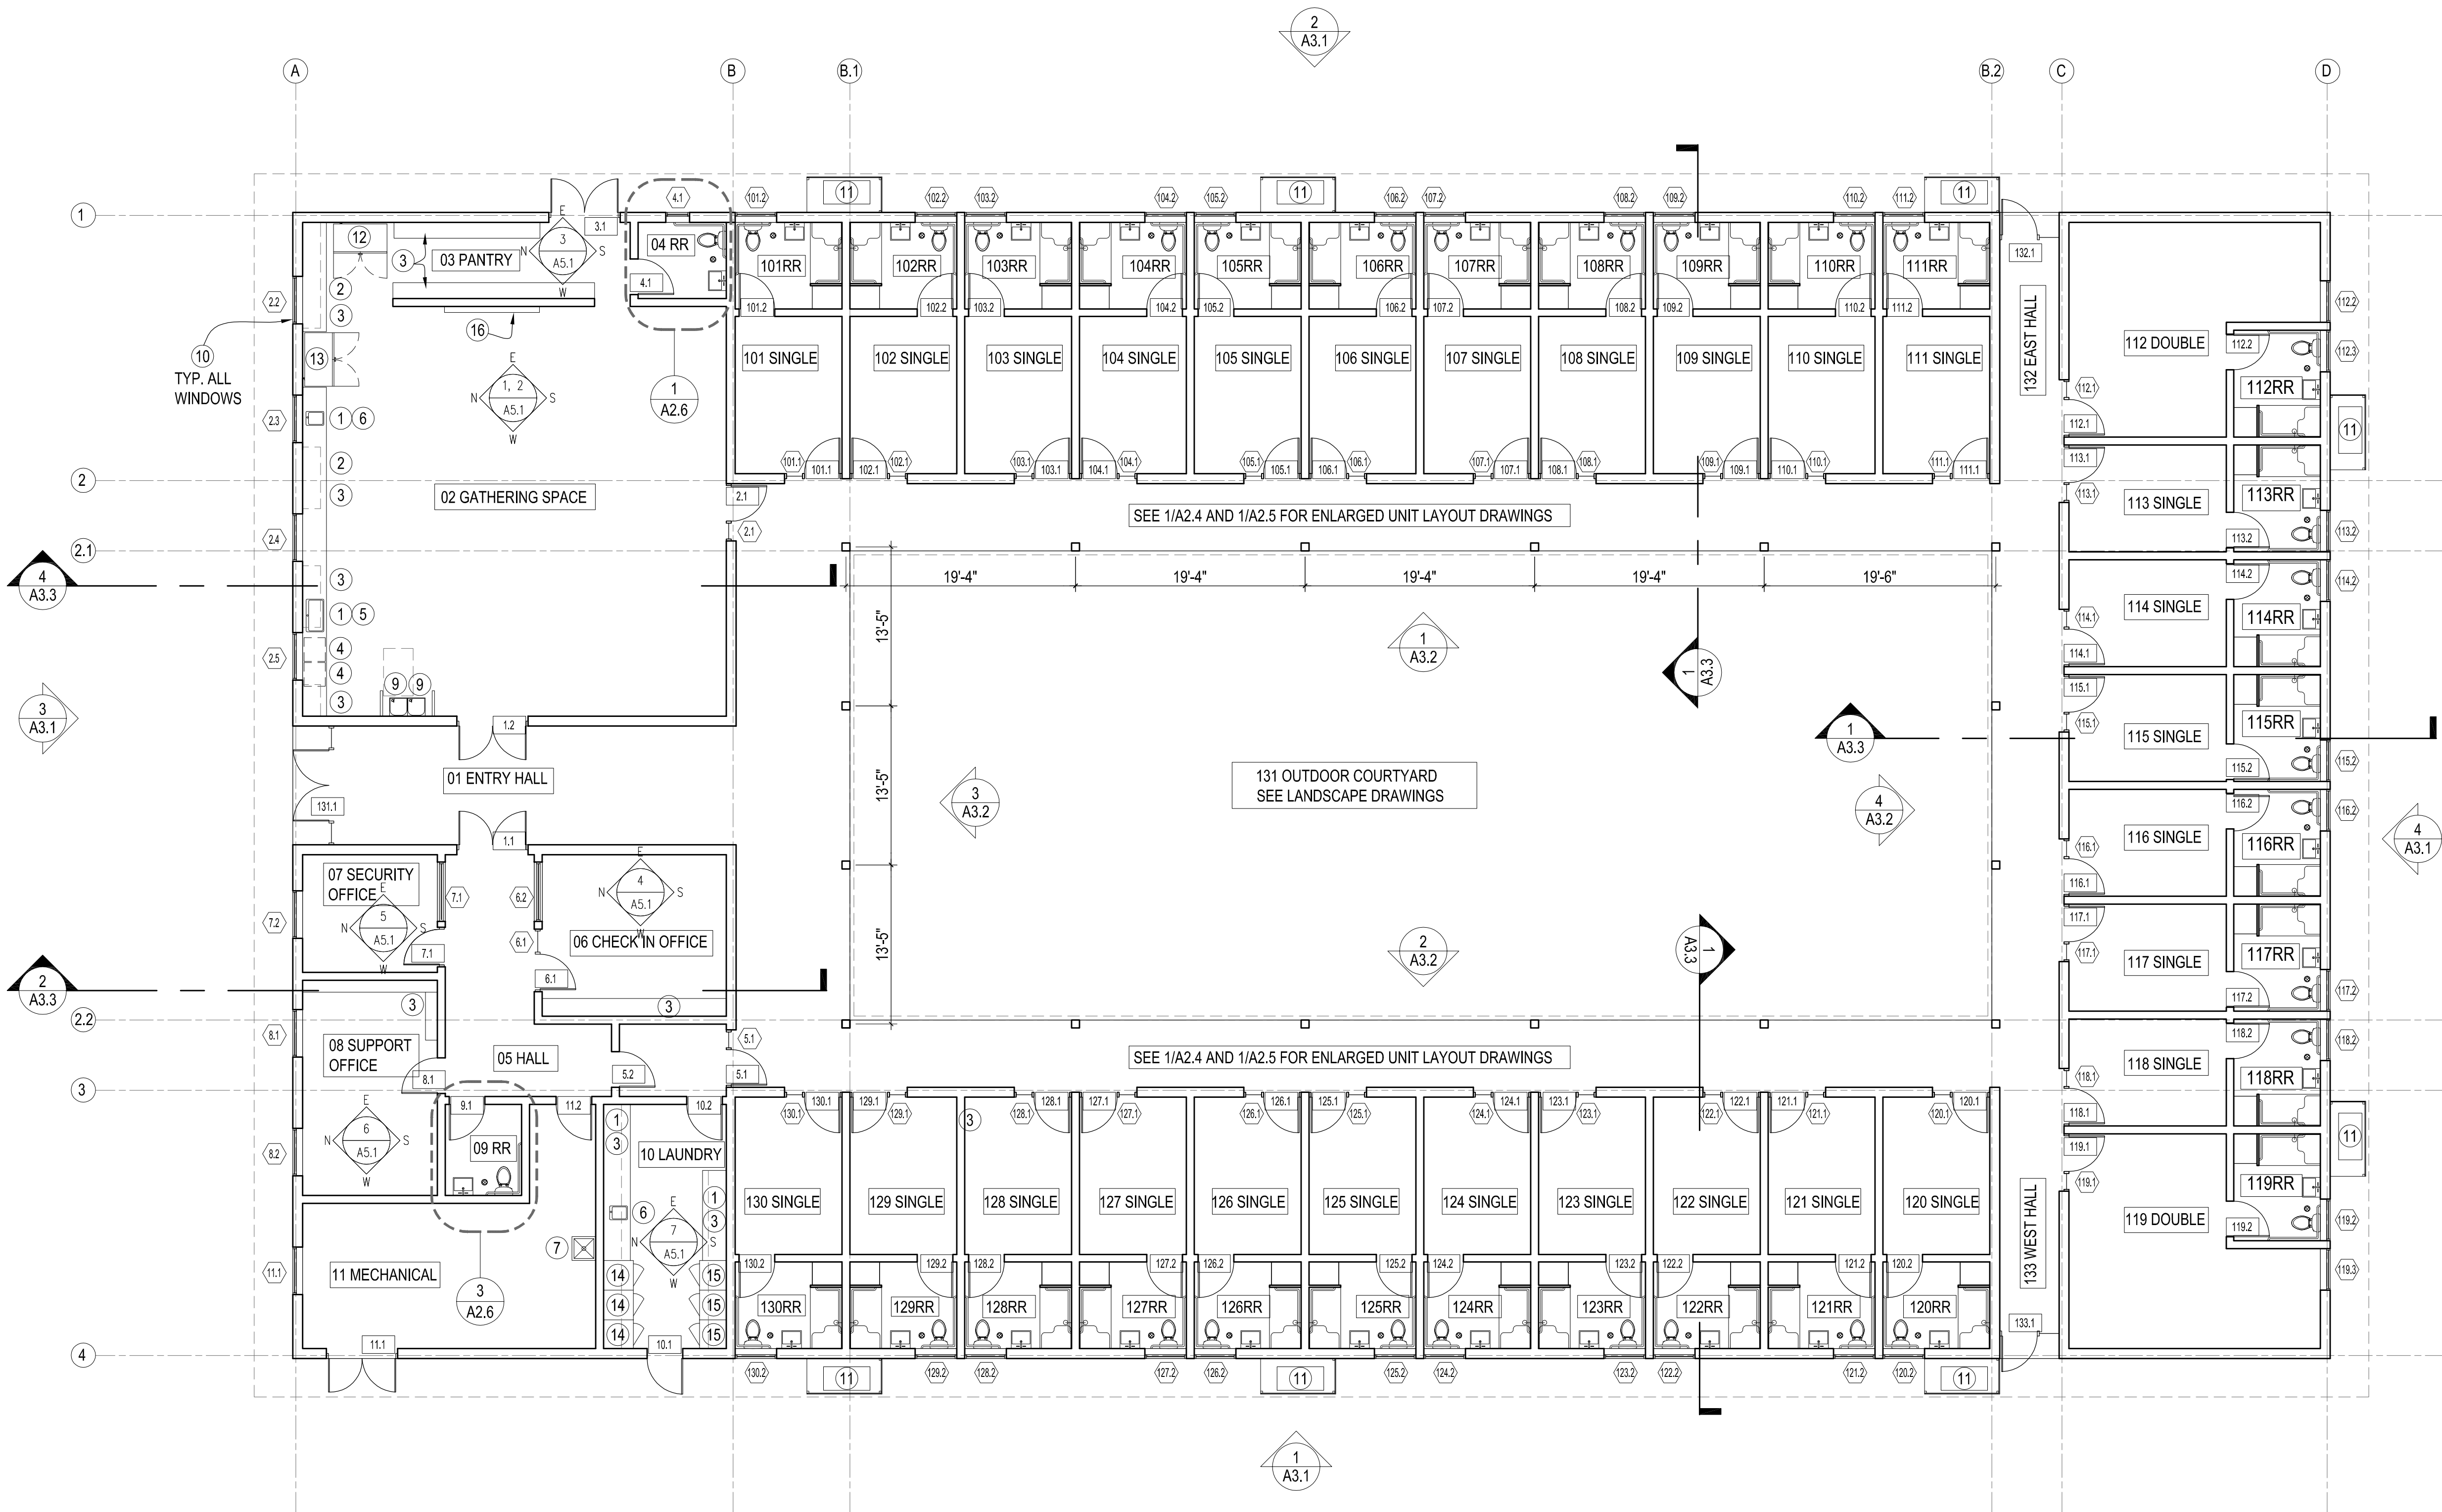
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25 July 2025

Design  
Development

Floor  
Plan

A2.1



- FLOOR PLAN KEY NOTES
- 1 INTERIOR CASEWORK, ADA ACCESSIBLE
  - 2 INTERIOR CASEWORK, LOWER CABINETS
  - 3 OPEN SHELVING
  - 4 DISHWASHER
  - 5 SINK WITH UNDERSINK DISPOSAL
  - 6 UTILITY SINK
  - 7 MOP SINK
  - 8 FLOOR DRAIN
  - 9 DRINKING FOUNTAIN W/CANE GUARD AND ADA CLEARANCES
  - 10 WINDOW COVERINGS
  - 11 HVAC, PAD AND ENCLOSURE, SEE MECHANICAL DRAWINGS
  - 12 REFRIGERATOR
  - 13 FREEZER
  - 14 WASHING MACHINE
  - 15 DRYER
  - 16 MOTORIZED SCREEN, SEE ELECTRICAL DRAWINGS

- FLOOR PLAN GENERAL NOTES:
- DESIGN DEVELOPMENT DRAWINGS ARE INTENDED FOR RFP PRICING AND NOT FOR CONSTRUCTION. FOLLOWING CONTRACTOR SELECTION PROCESS, DRAWINGS AND SPECIFICATIONS WILL BE PREPARED FOR PERMITTING AND CONSTRUCTION.
  - SEE A2.4 AND A2.5 FOR ENLARGED UNIT PLANS.
  - SEE ARCHITECTURAL OUTLINE SPECIFICATIONS FOR ADDITIONAL PRODUCT AND MATERIAL INFORMATION.
  - BUILDINGS TO BE FULLY SPRINKLERED AND ALARMED UNDER DEFERRED SUBMITTAL.
  - BUILDINGS TO COMPLY WITH CALIFORNIA BUILDING CODE CHAPTER 7A MATERIALS AND CONSTRUCTION METHODS FOR WILDFIRE EXPOSURE.
  - GRIDLINE INDICATES FACE OF FRAMING. SEE STRUCTURAL.
  - SEE A3.0 FOR ASSEMBLY KEYNOTE LEGEND.
  - ALL INTERIOR WALLS TO BE WALL TYPE A UNO.
  - SEE A0.2 FOR CODE COMPLIANCE AND ACCESSIBILITY REQUIREMENTS.
  - SEE A5 SERIES DRAWINGS FOR INTERIOR ELEVATIONS.
  - HVAC UNITS AT BUILDING EXTERIOR ARE DIAGRAMMATIC AND SHOWN FOR REFERENCE ONLY. SEE MECHANICAL DRAWINGS.
  - PROVIDE WINDOW COVERINGS AT ALL GLAZING.
  - CONTRACTOR TO PROVIDE WEATHER TIGHT BUILDING ENVELOPE AND SEAL ALL PENETRATIONS TO PREVENT AIR AND WATER INFILTRATION.
  - ALL PENETRATIONS AT RATED WALLS AND CEILINGS TO BE FIRESTOPPED AND SEALED TO MAINTAIN REQUIRED FIRE RESISTANCE RATING.

## FLOOR PLAN

1/8" = 1'-0"



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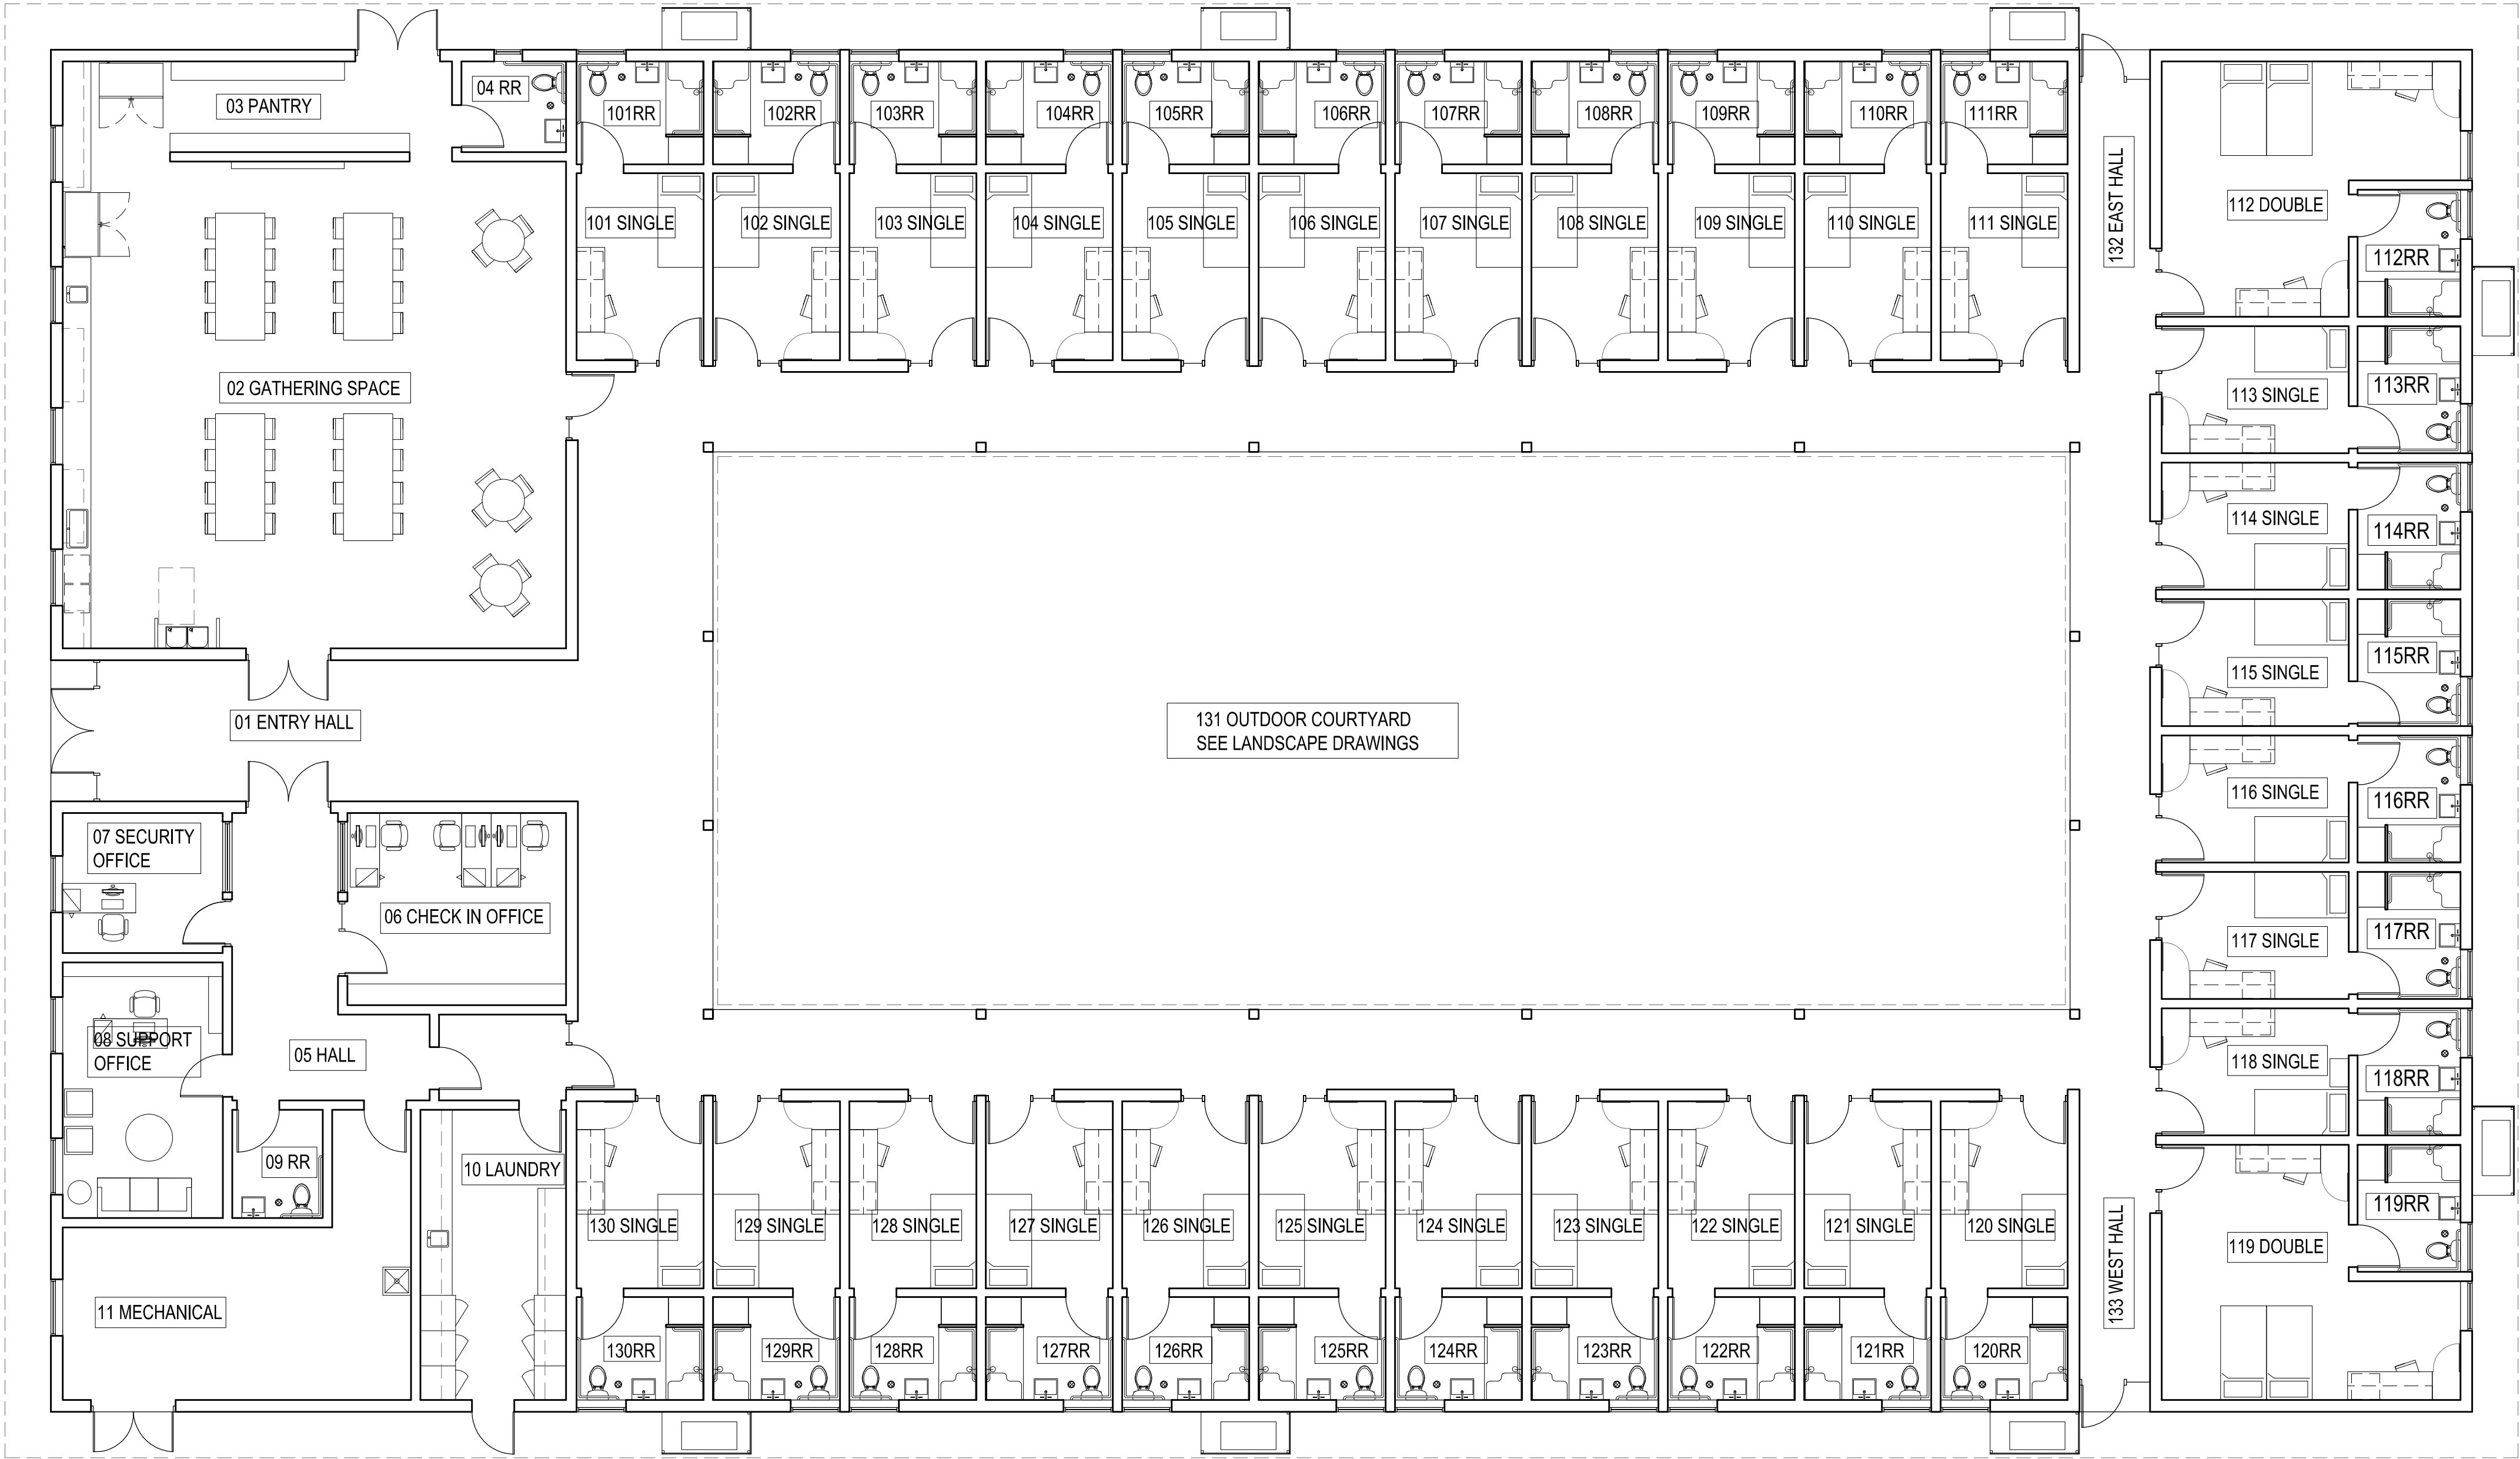
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25 July 2025

Design  
Development

Furniture  
Plan

A2.2



FURNITURE PLAN GENERAL NOTES:  
1. DESIGN DEVELOPMENT DRAWINGS ARE INTENDED FOR RFP PRICING AND NOT FOR CONSTRUCTION. FOLLOWING CONTRACTOR SELECTION PROCESS.  
2. FURNITURE PLAN SHOWN FOR REFERENCE ONLY, ITEMS SHOWN HERE AND NOT ON A2.1 SHALL BE PROVIDED BY THE OWNER AND SHALL NOT BE INCLUDED THE CONTRACT FOR CONSTRUCTION.




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Design  
Development

## A2.3



ROOF VENTILATION CALCULATIONS	
ATTIC AREA (SF)	11,300
FACTOR	150
REQUIRED VENT AREA (SF)	75.3
NET FREE SQUARE INCHES REQ'D	10,848
UPPER VENT NFVA	5,424
LOWER VENT NFVA	5,424

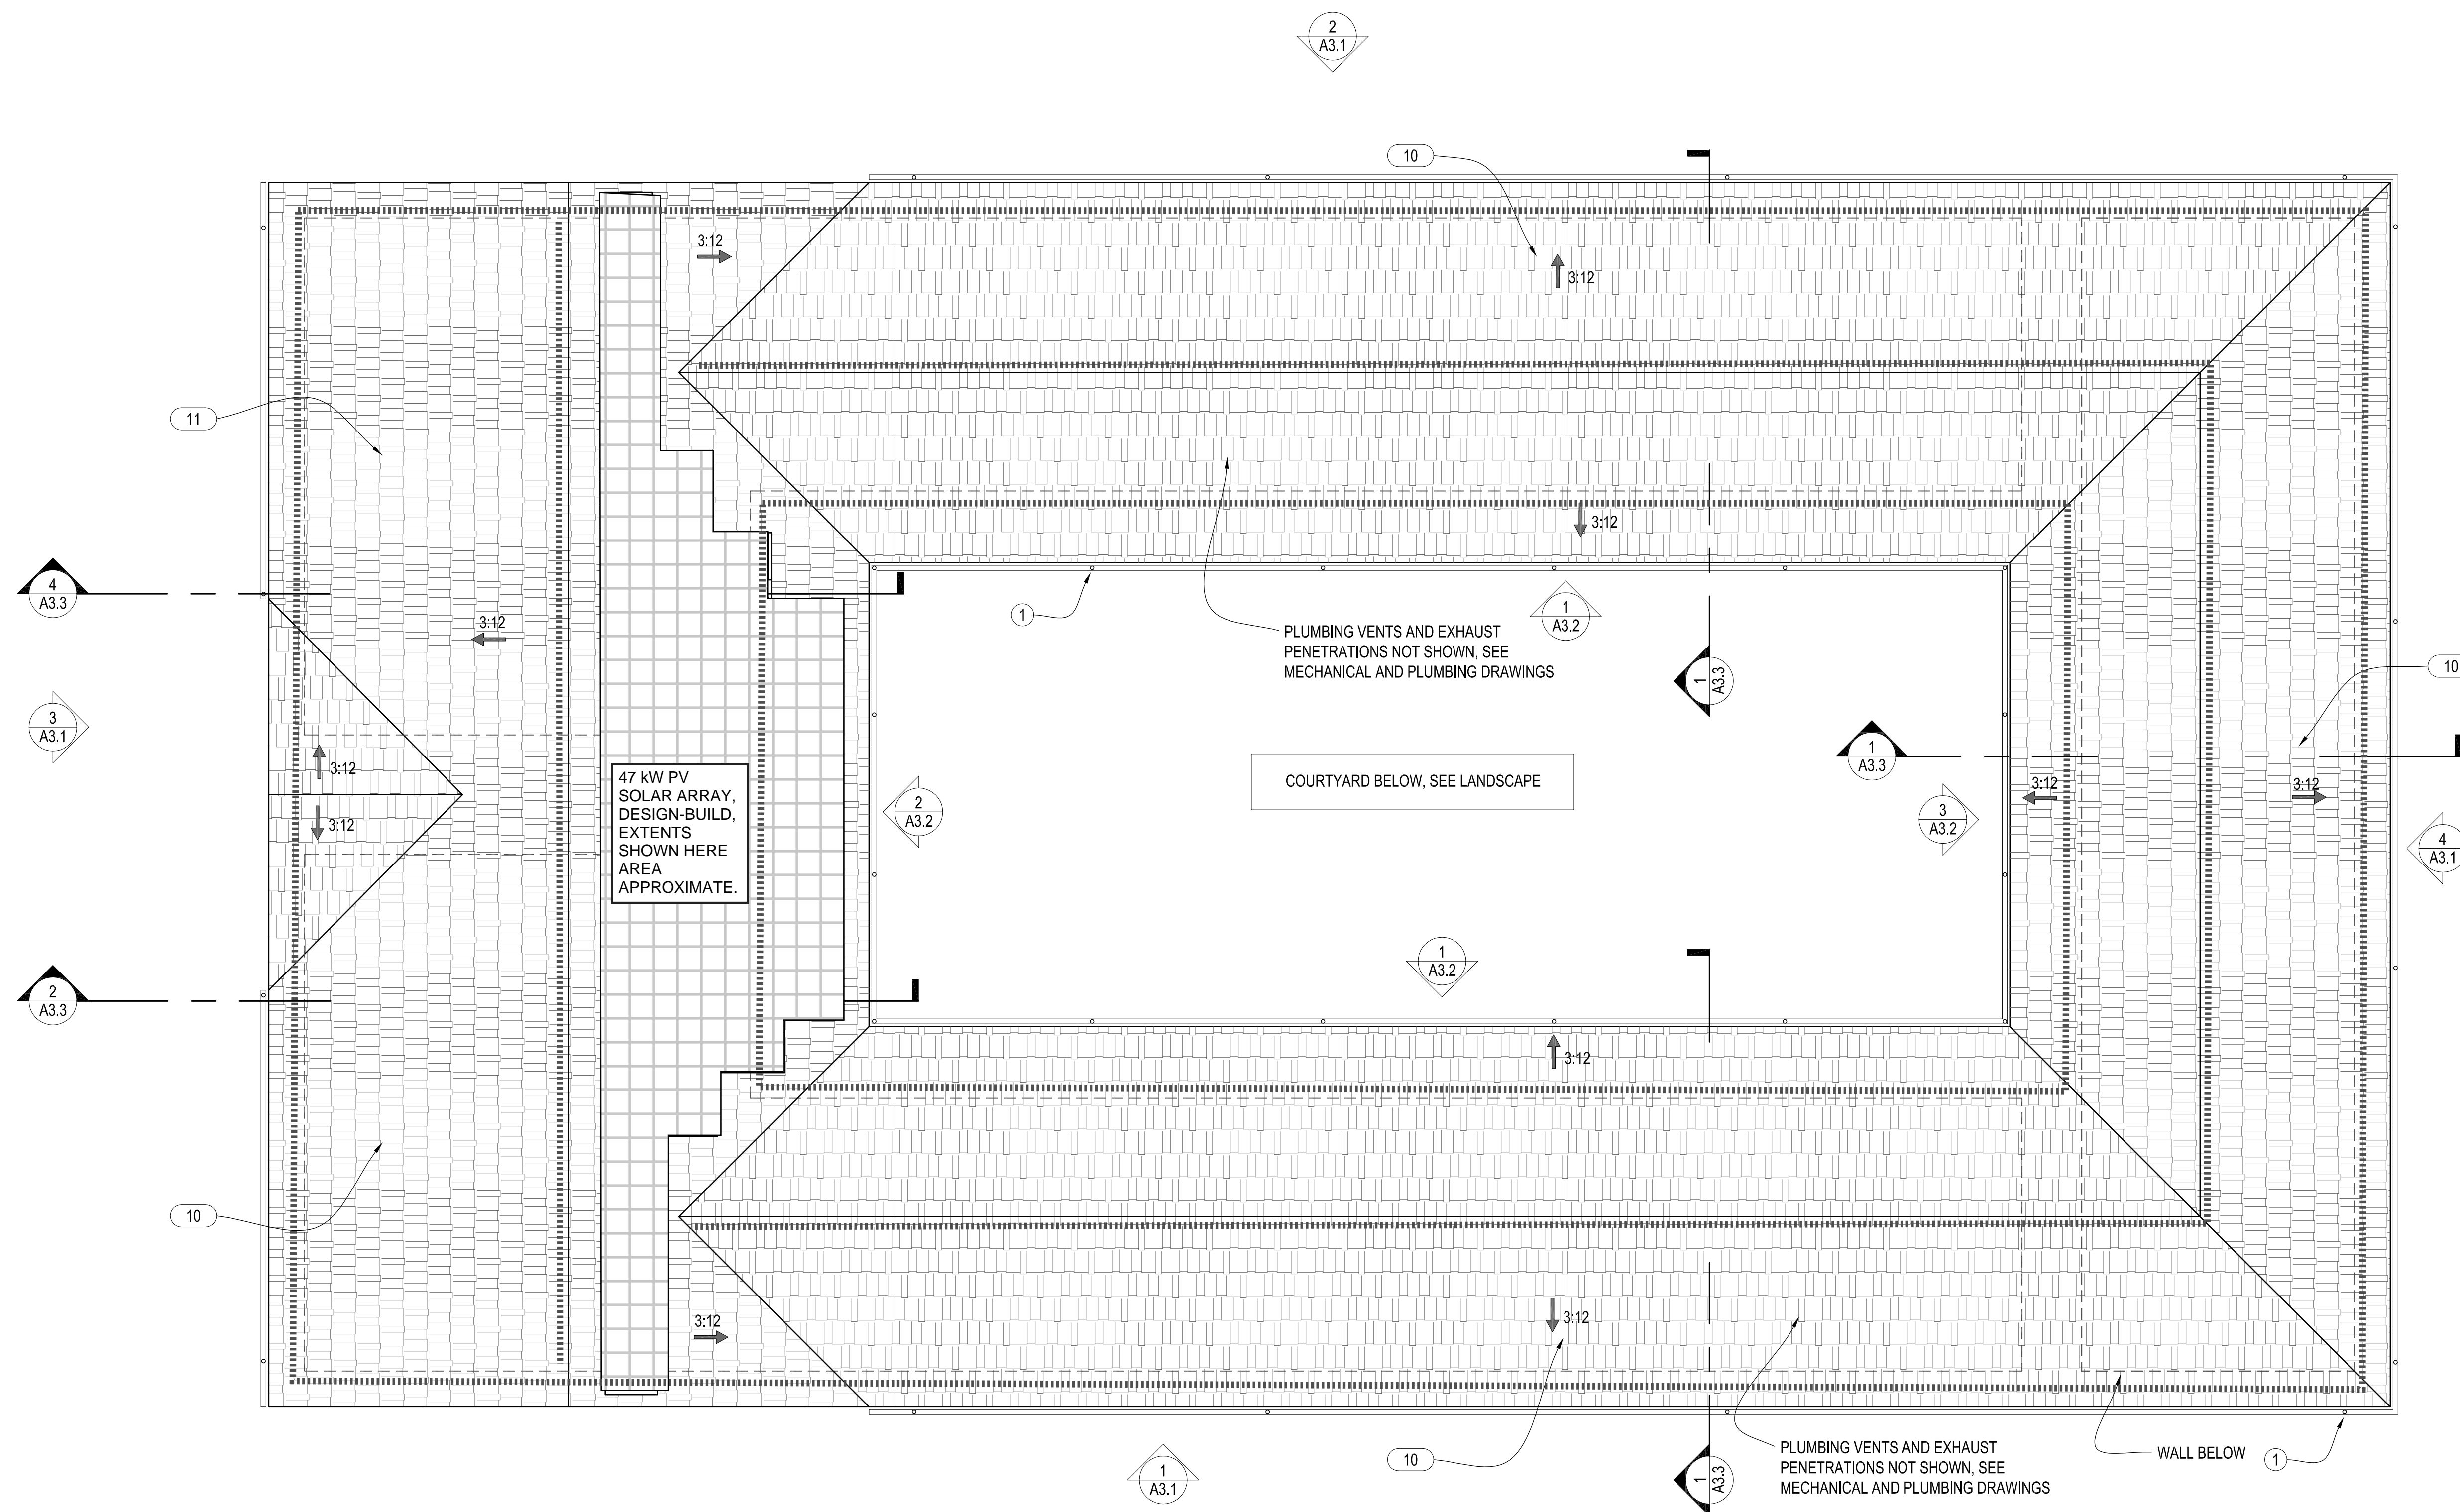PROPOSED	
4" EXTERIOR SOFFIT VENT (LF)	475
4" COURTYARD SOFFIT VENT (LF)	287
NFVA PER LF	19.2
<b>TOTAL LOWER NFVA</b>	<b>14,630</b>
RIDGE VENT - CONTINUOUS	
4" CONTINUOUS RIDGE VENT	375
NFVA PER LF	19.2
<b>TOTAL UPPER NFVA</b>	<b>7,277</b>

#### ROOF PLAN KEY NOTES

- ① GUTTER AND DOWNSPOUT PROVIDE GUTTER SCREENS

INTUMESCENT SOFFIT AND RIDGE VENTS, SEE WALL SECTIONS, DETAILS AND OUTLINE SPECS


ROOF PLAN GENERAL NOTES:

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2. BUILDINGS TO COMPLY WITH CALIFORNIA BUILDING CODE CHAPTER 7A MATERIALS AND CONSTRUCTION METHODS FOR WILDFIRE EXPOSURE.
3. GRIDLINE INDICATES FACE OF FRAMING, SEE STRUCTURAL.
4. SEE A3.0 FOR ASSEMBLY KEYNOTE LEGEND.
5. SEE ELECTRICAL FOR SOLAR PV ARRAY AND ASSOCIATED CONDUIT REQUIREMENTS.
6. NOT USED
7. ALL ROOF PENETRATIONS TO COMPLY WITH ROOFING MANUFACTURERS REQUIREMENTS.
8. ALL GUTTERS TO BE SCREENED.
9. PROVIDE CONTINUOUS 4" INTUMESCENT RIDGE VENTING AT TRUSSED ROOF. SEE ATTIC VENT CALCULATIONS.

## ROOF PLAN

1/8" = 1'-0"




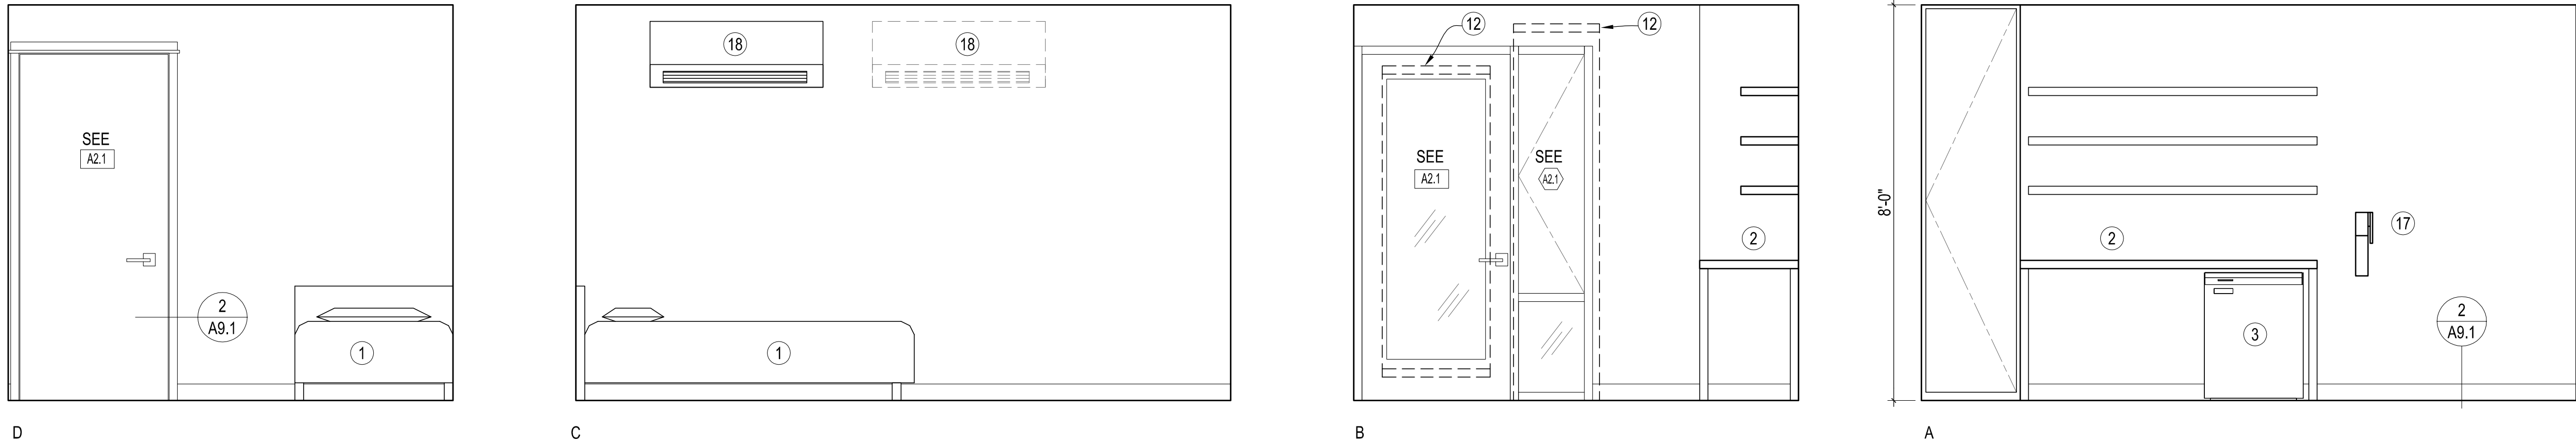

3  
A2.4

SINGLE UNIT INTERIOR ELEVATIONS


1/2" = 1'-0"

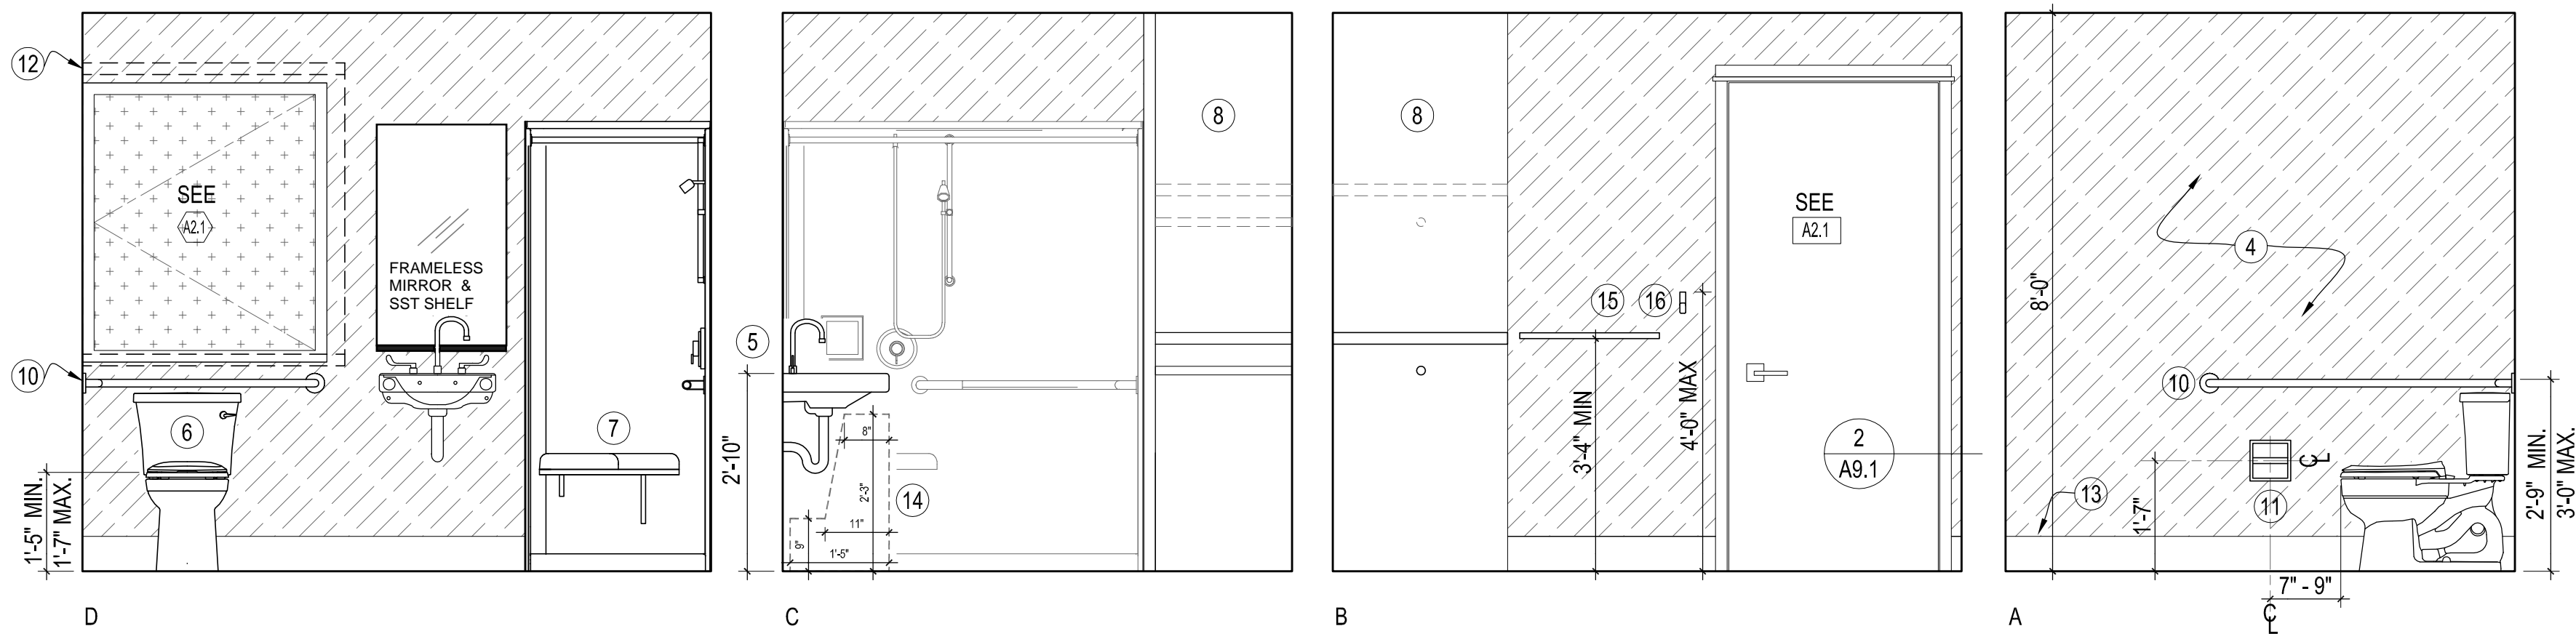

2  
A2.4

SINGLE UNIT RESTROOM INTERIOR ELEVATIONS

1/2" = 1'-0"

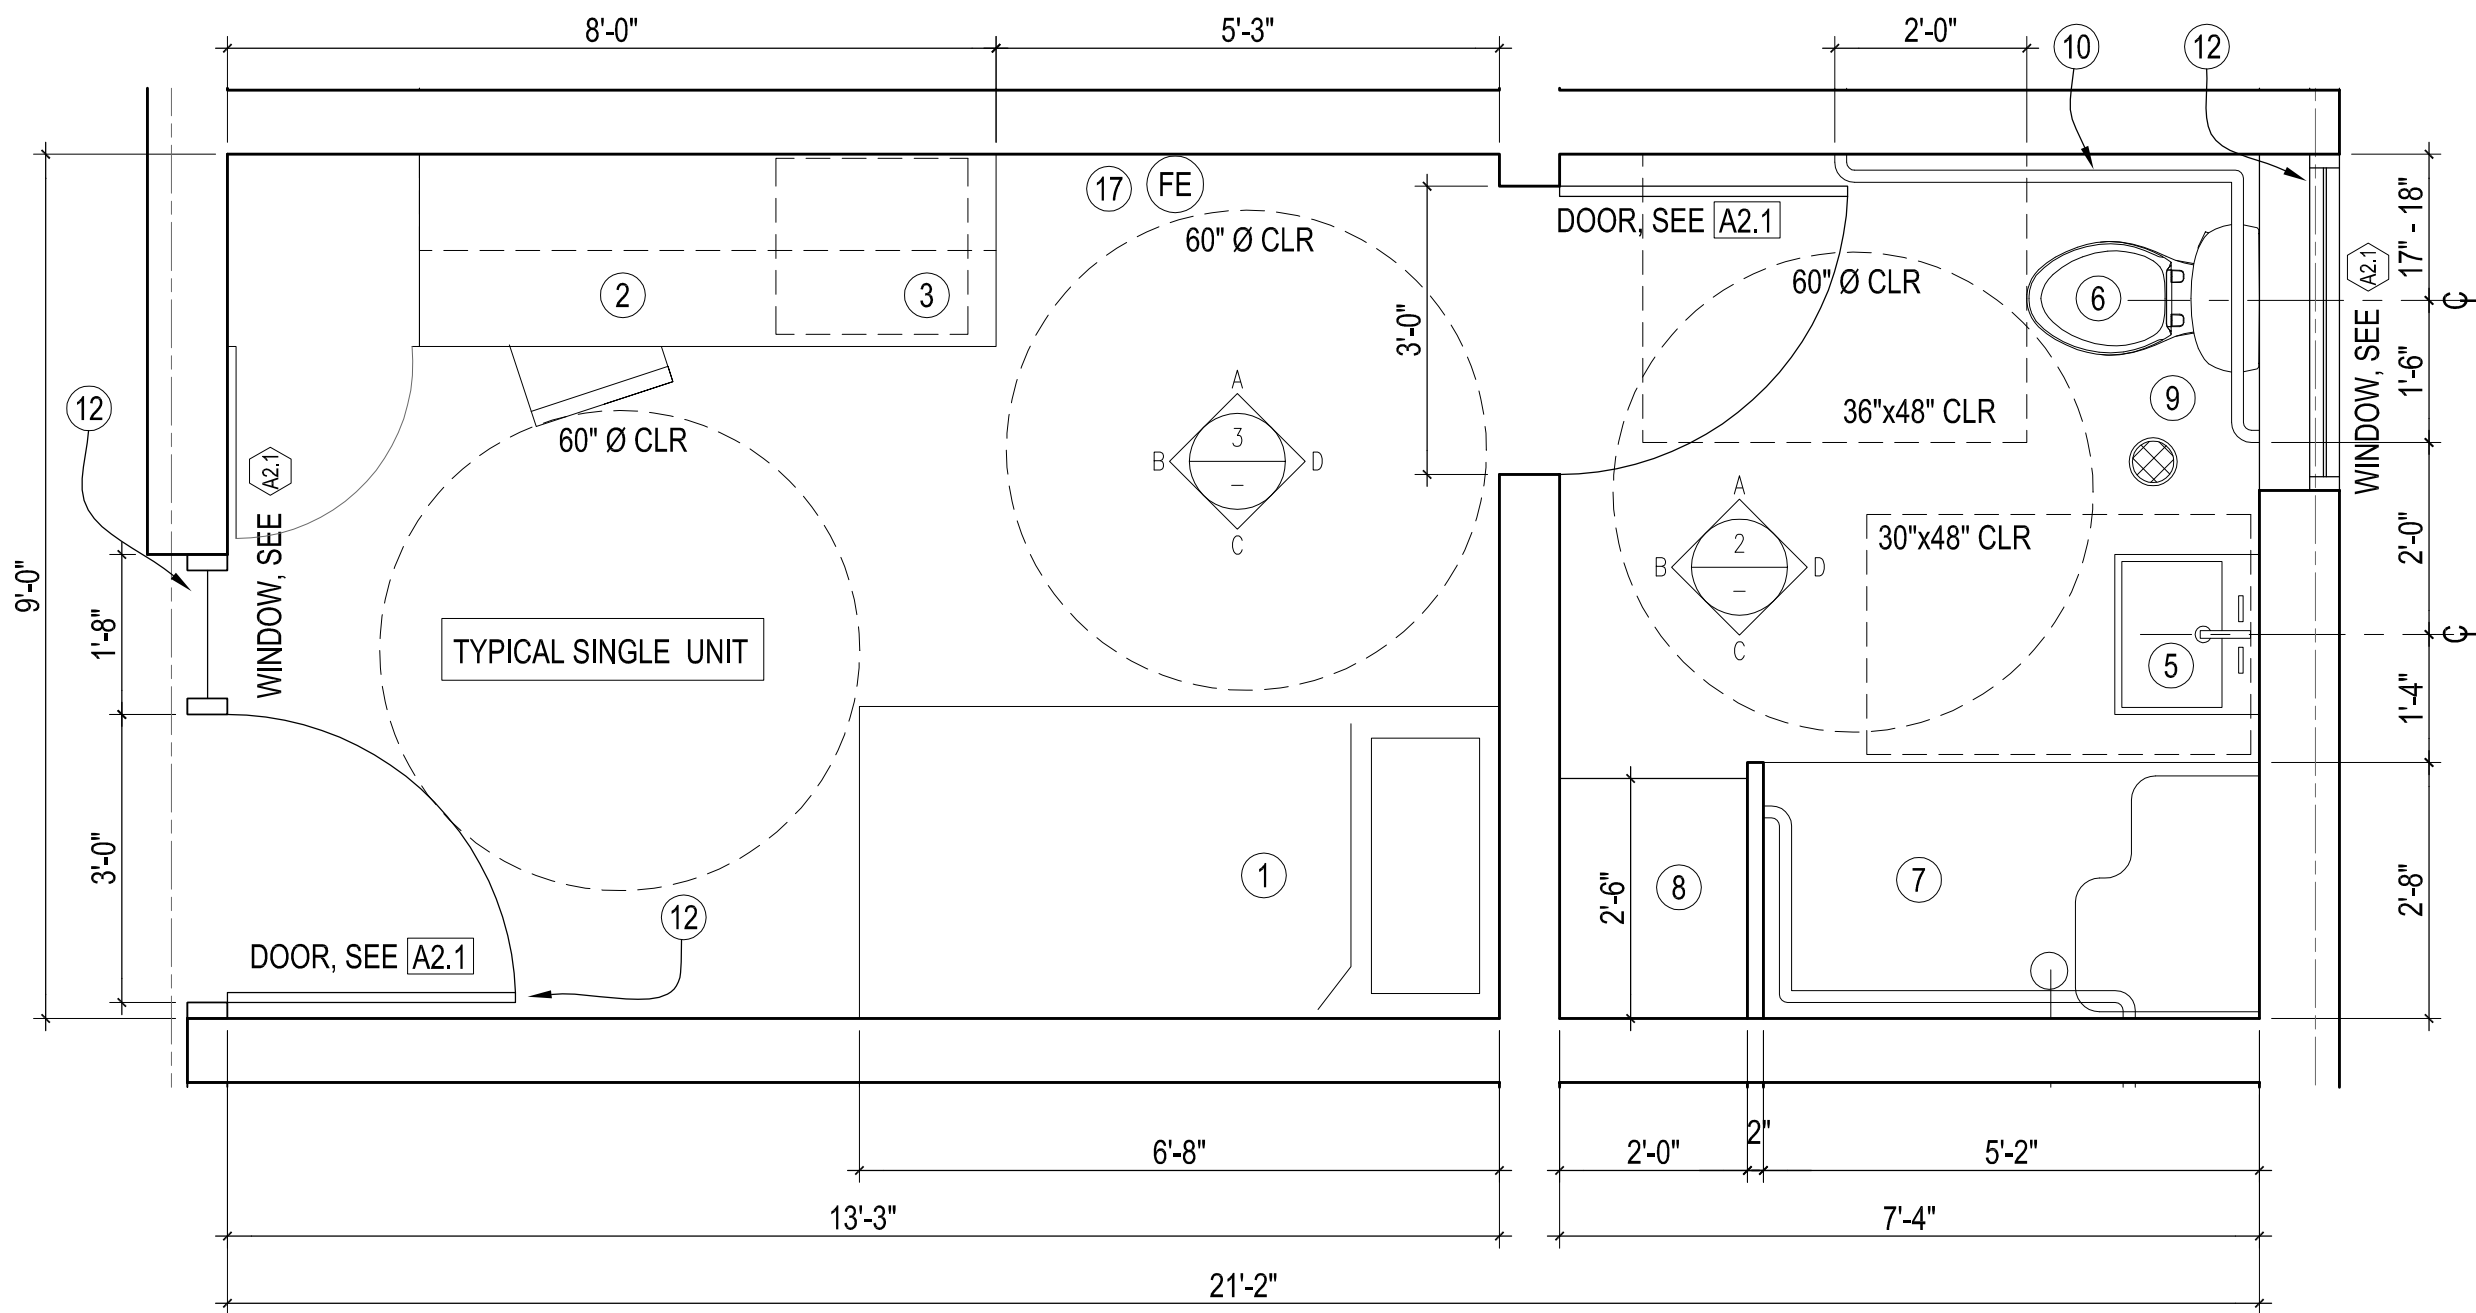

1  
A2.4


ENLARGED SINGLE UNIT FLOOR PLAN

1/2" = 1'-0"


- UNIT PLAN KEY NOTES
- 1 TWIN XL BED, STORAGE BELOW, FOIO
  - 2 DESK, SHELVES ABOVE, CLOSET, FOIO
  - 3 MINI FRIDGE BELOW, FOIO
  - 4 FRP WALL PANELING, FULL HEIGHT
  - 5 WALL MOUNTED SINK
  - 6 TOILET
  - 7 ROLL IN SHOWER INSTALL PER MFR REC, PROVIDE SHOWER CURTAIN
  - 8 CLOSET, ROD/SHELF ABOVE
  - 9 FLOOR DRAIN
  - 10 GRAB BAR
  - 11 TISSUE HOLDER
  - 12 WINDOW COVERING
  - 13 6" COVE BASE
  - 14 MIN. KNEE CLEARANCES
  - 15 SHELF
  - 16 COAT HOOK
  - 17 FIRE EXTINGUISHER ON BRACKET
  - 18 HVAC, SEE MECHANICAL DRAWINGS

- UNIT PLAN GENERAL NOTES:
- DESIGN DEVELOPMENT DRAWINGS ARE INTENDED FOR RFP PRICING AND NOT FOR CONSTRUCTION. FOLLOWING CONTRACTOR SELECTION PROCESS, DRAWINGS AND SPECIFICATIONS WILL BE PREPARED FOR PERMITTING AND CONSTRUCTION.
  - GRIDLINE INDICATES FACE OF FRAMING, SEE STRUCTURAL.
  - SEE A3.0 FOR ASSEMBLY KEYNOTE LEGEND.
  - ALL INTERIOR WALLS TO BE WALL TYPE 2 UNO.
  - SEE A0.2 AND A0.3 FOR CODE COMPLIANCE AND ACCESSIBILITY REQUIREMENTS.
  - SEE A6.2 FOR REFLECTED CEILING PLAN.
  - DRAWINGS AND NOTES SHOWN HERE ARE TYPICAL FOR ALL SINGLE UNITS. PROVIDE MIRROR IMAGE OF LAYOUT FOR EVERY OTHER UNIT.
  - SEE ARCHITECTURAL OUTLINE SPECIFICATIONS FOR ADDL INFORMATION




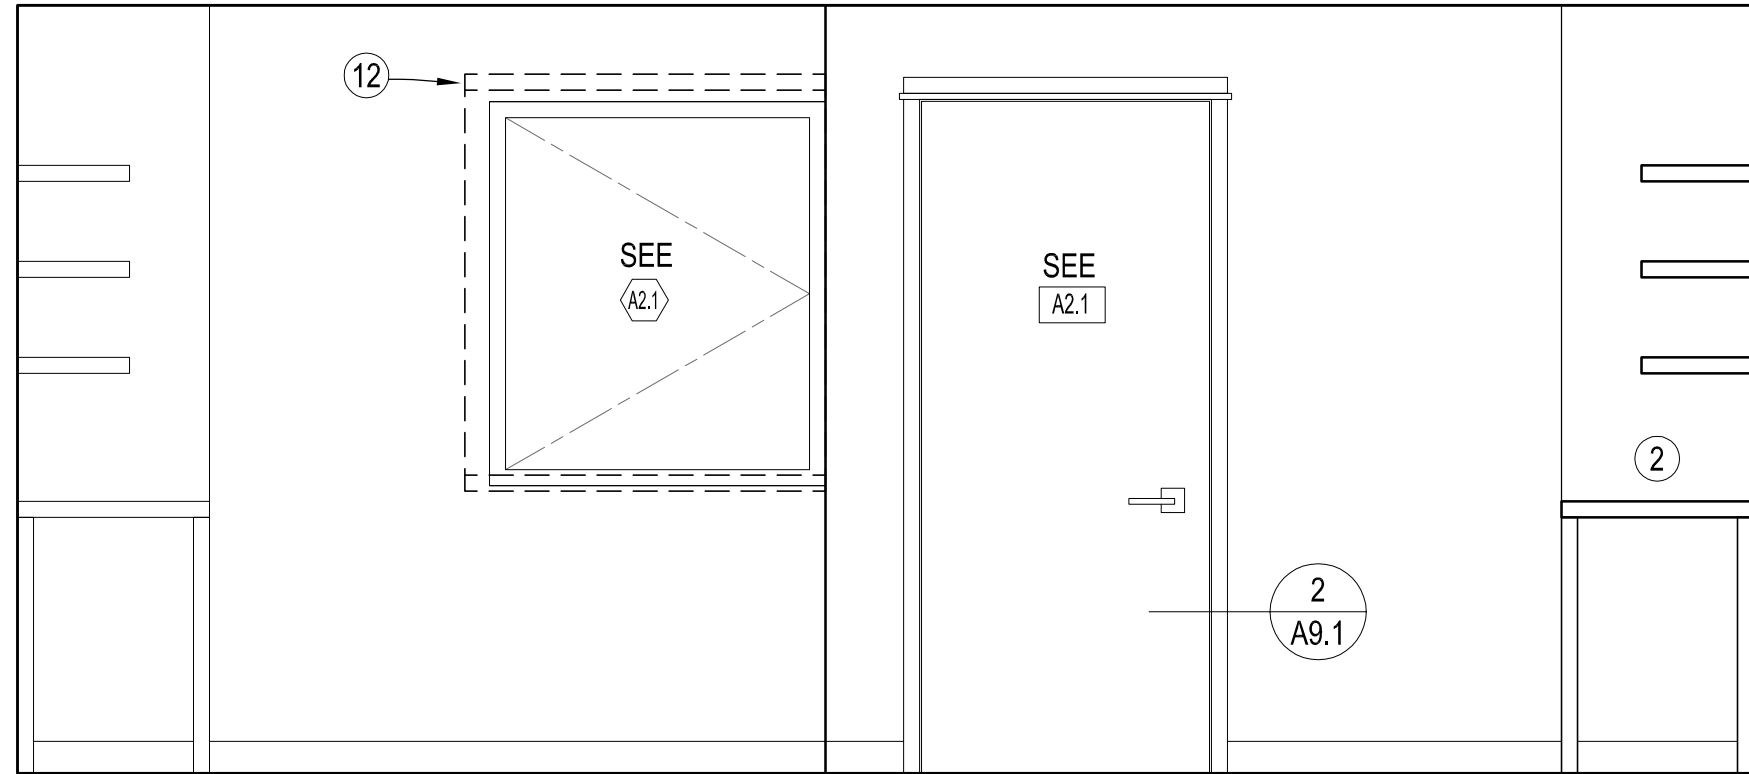

D

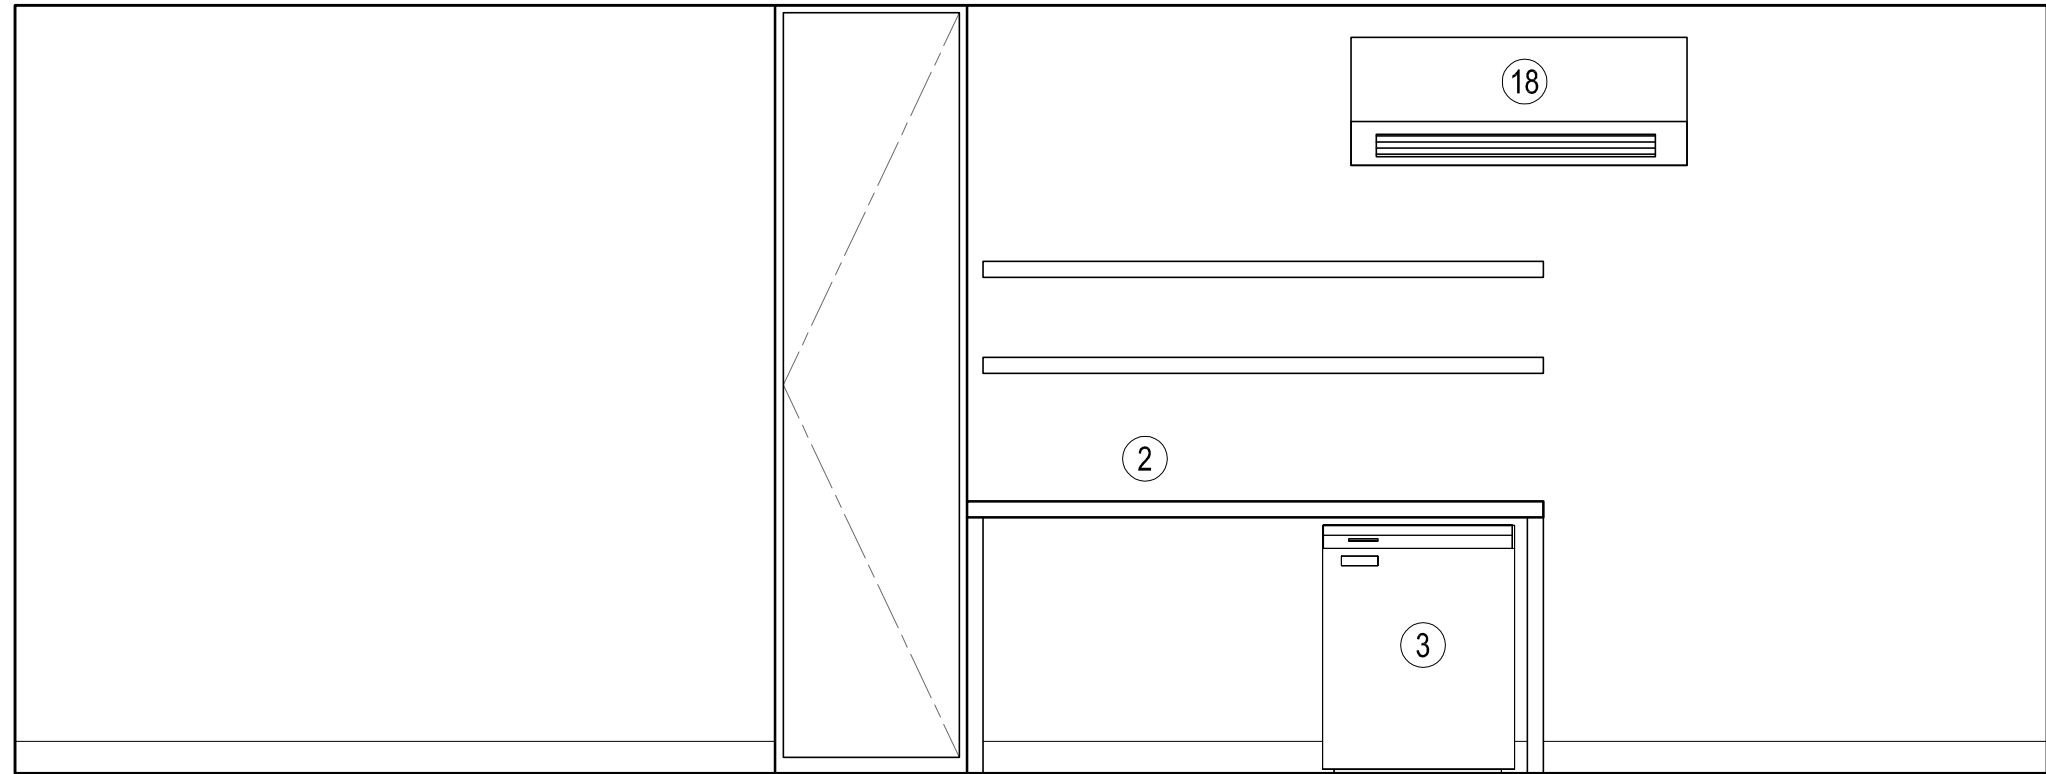

C

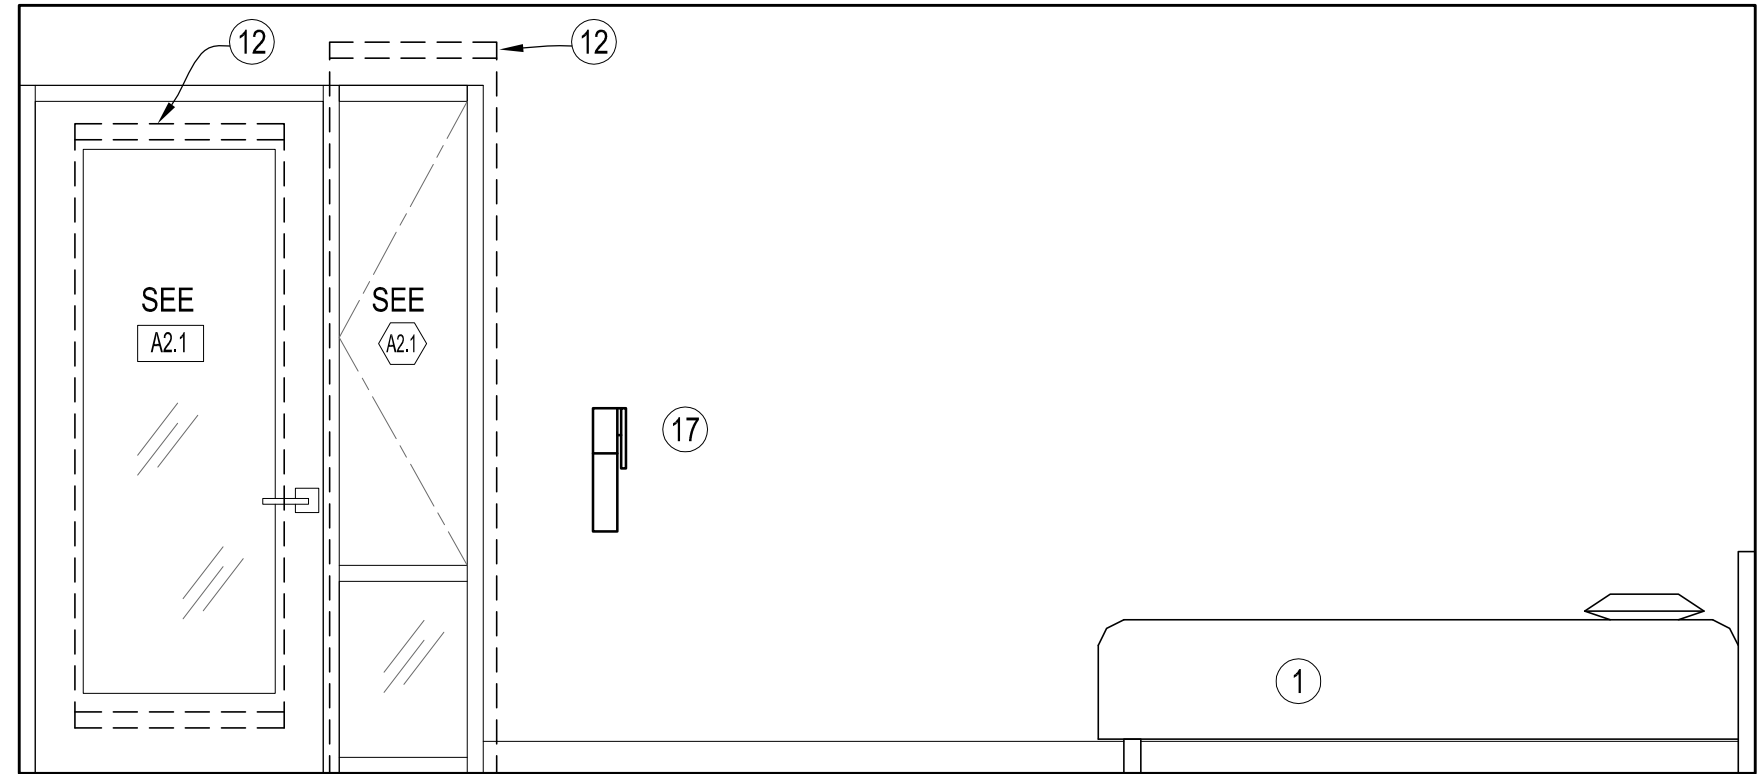

B

4  
A2.5

## DOUBLE UNIT INTERIOR ELEVATIONS (CONT.)


1/2" = 1'-0"

### UNIT PLAN KEY NOTES

- 1 TWIN XL BED, STORAGE BELOW, FOIO
- 2 DESK, SHELVES ABOVE, CLOSET, FOIO
- 3 MINI FRIDGE BELOW, FOIO
- 4 FRP WALL PANELING, FULL HEIGHT
- 5 WALL MOUNTED SINK
- 6 TOILET
- 7 ROLL IN SHOWER INSTALL PER MFR REC, PROVIDE SHOWER CURTAIN
- 8 CLOSET, ROD/SHELF ABOVE
- 9 FLOOR DRAIN
- 10 GRAB BAR
- 11 TISSUE HOLDER
- 12 WINDOW COVERING
- 13 6" COVE BASE
- 14 MIN. KNEE CLEARANCES
- 15 SHELF
- 16 COAT HOOK
- 17 FIRE EXTINGUISHER ON BRACKET
- 18 HVAC, SEE MECHANICAL DRAWINGS

### UNIT PLAN GENERAL NOTES:

1. DESIGN DEVELOPMENT DRAWINGS ARE INTENDED FOR RFP PRICING AND NOT FOR CONSTRUCTION. FOLLOWING CONTRACTOR SELECTION PROCESS, DRAWINGS AND SPECIFICATIONS WILL BE PREPARED FOR PERMITTING AND CONSTRUCTION.
2. GRIDLINE INDICATES FACE OF FRAMING, SEE STRUCTURAL.
3. SEE A3.0 FOR ASSEMBLY KEYNOTE LEGEND.
4. ALL INTERIOR WALLS TO BE WALL TYPE 2 UNO.
5. SEE A0.2 AND A0.3 FOR CODE COMPLIANCE AND ACCESSIBILITY REQUIREMENTS.
6. SEE A6.2 FOR REFLECTED CEILING PLAN.
7. DRAWINGS AND NOTES SHOWN HERE ARE TYPICAL FOR ALL SINGLE UNITS. PROVIDE MIRROR IMAGE OF LAYOUT FOR EVERY OTHER UNIT.
8. SEE ARCHITECTURAL OUTLINE SPECIFICATIONS FOR ADDL INFORMATION

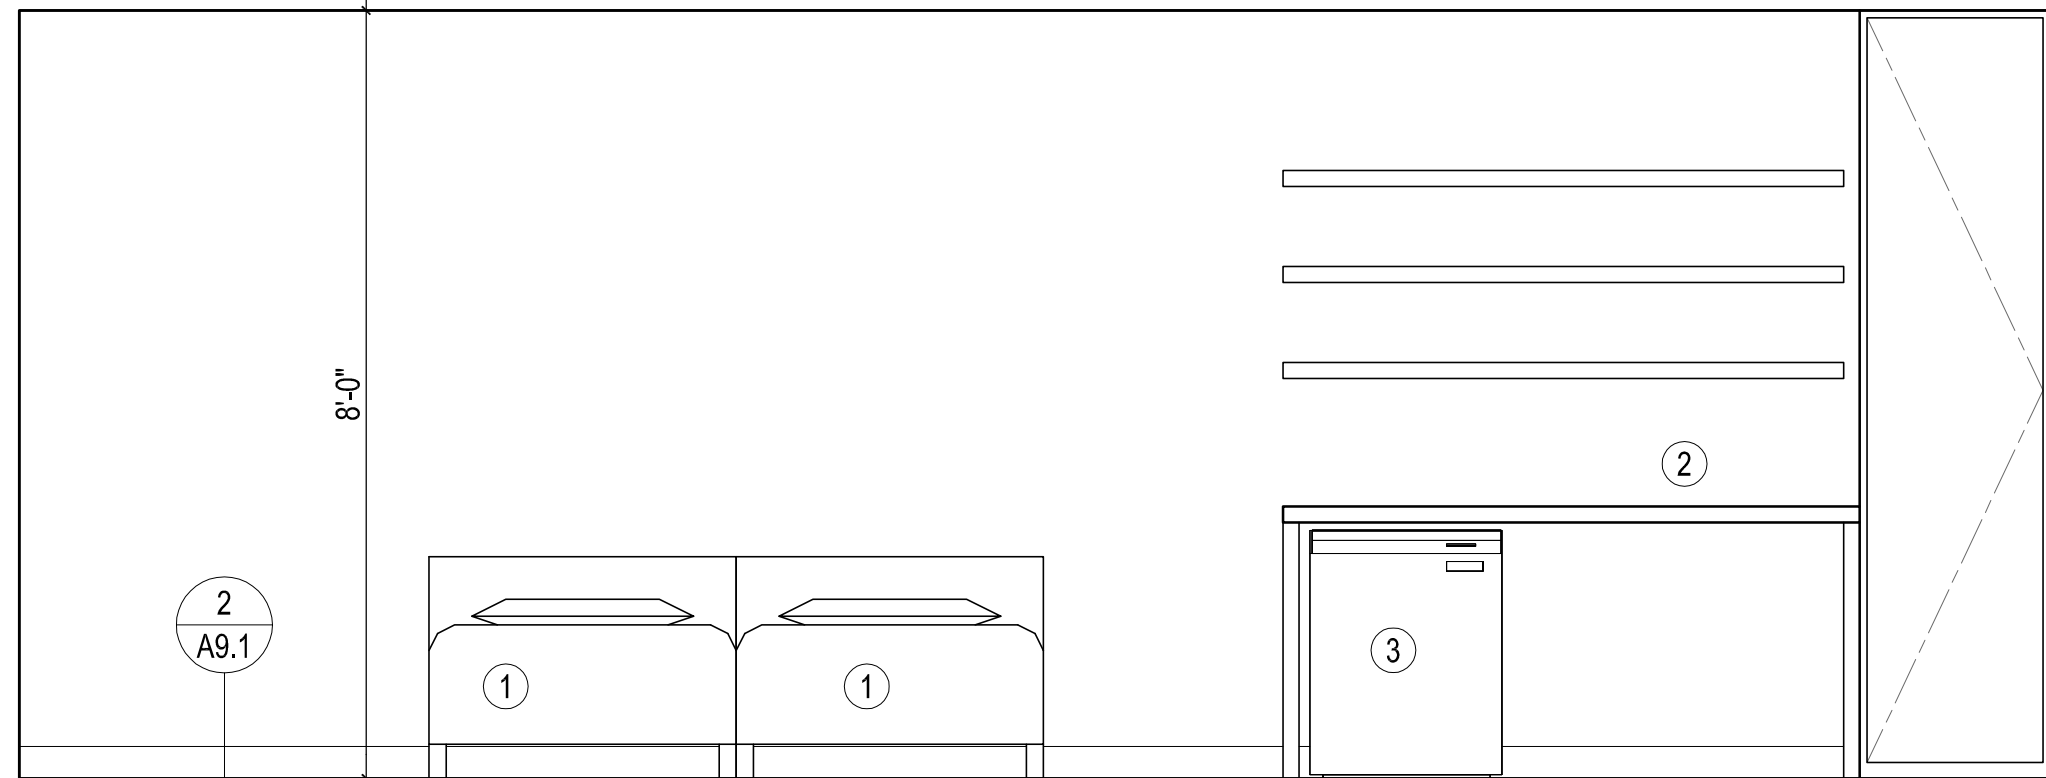


A


3  
A2.5

## DOUBLE UNIT INTERIOR ELEVATIONS


1/2" = 1'-0"

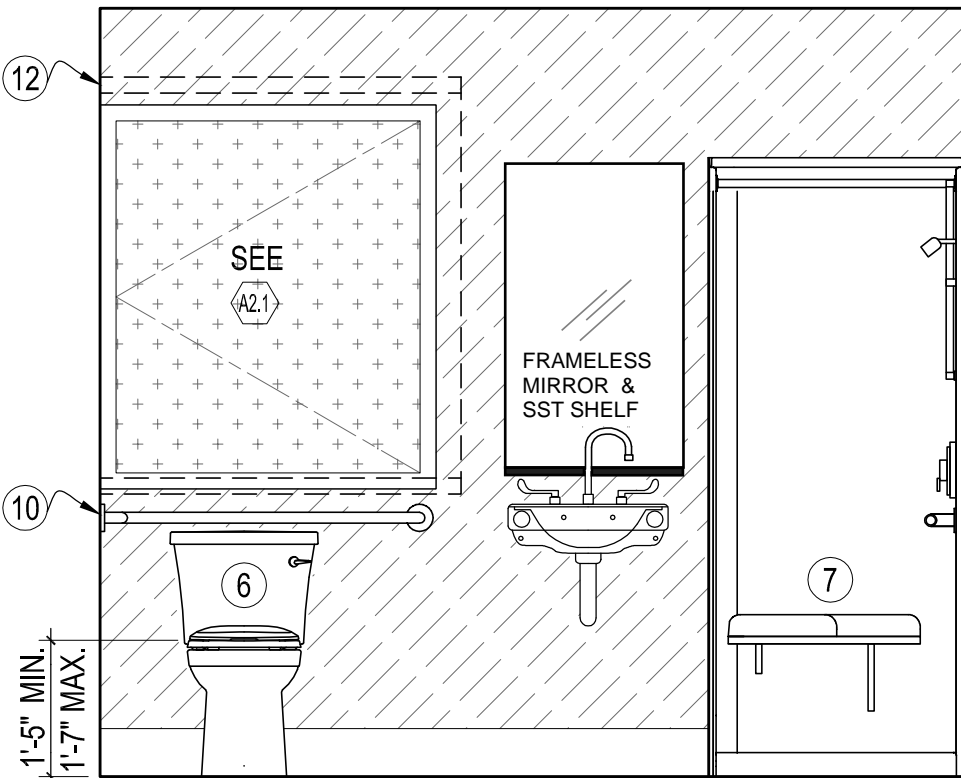


D

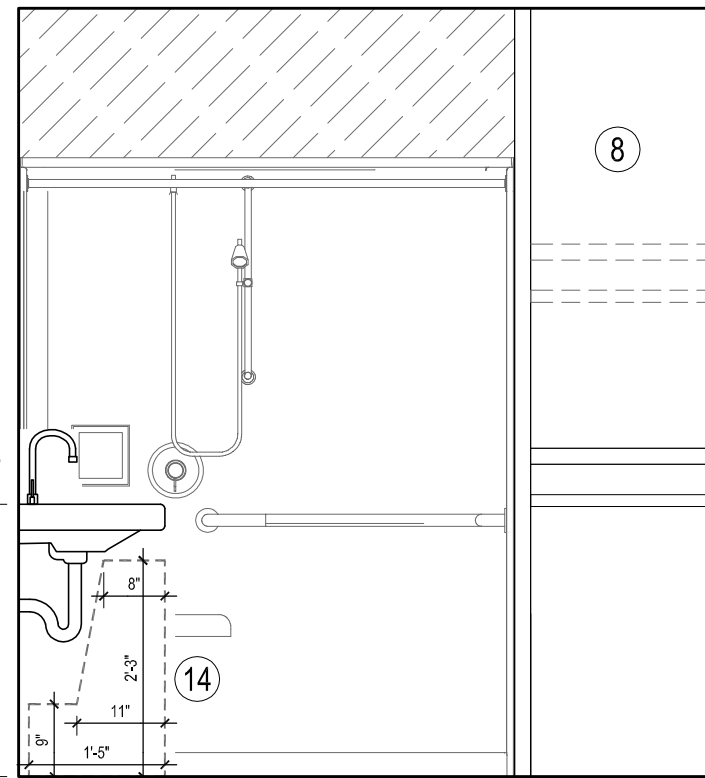

C

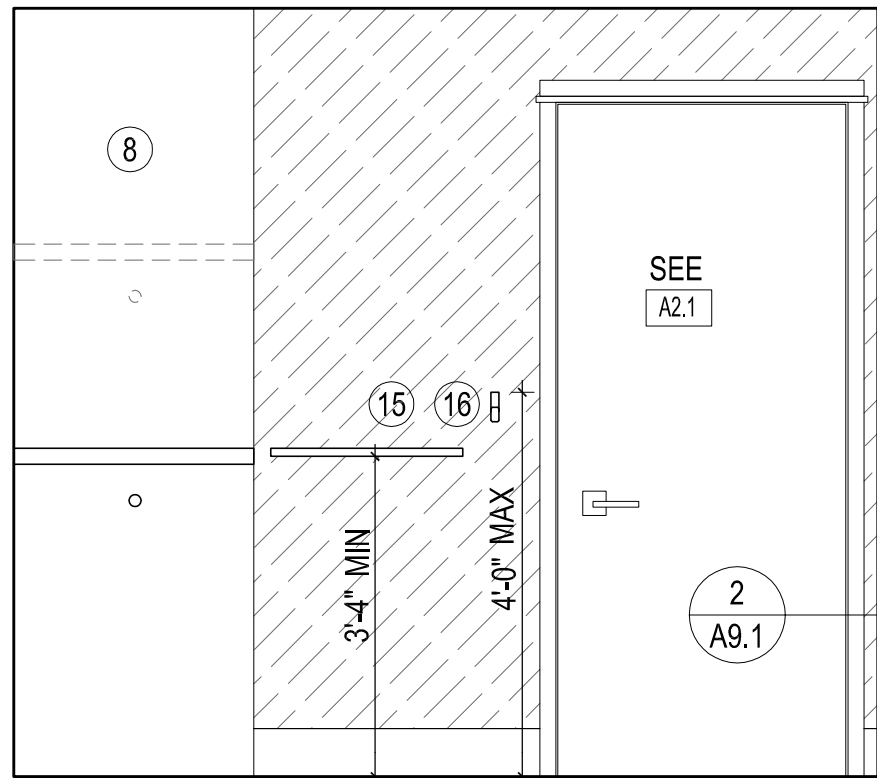

B

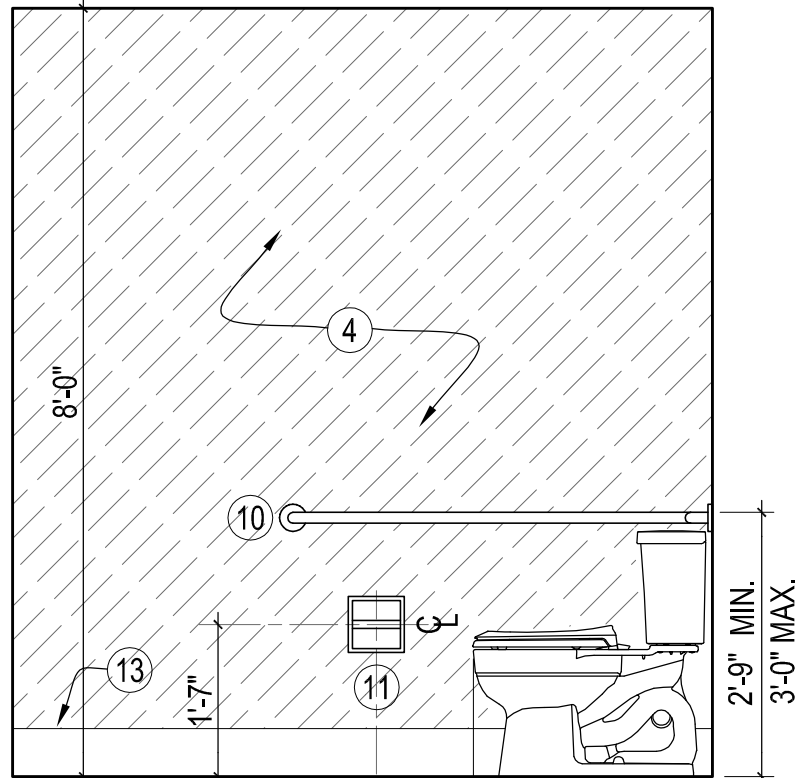


A

2  
A2.5

## DOUBLE UNIT RESTROOM INTERIOR ELEVATIONS

1/2" = 1'-0"

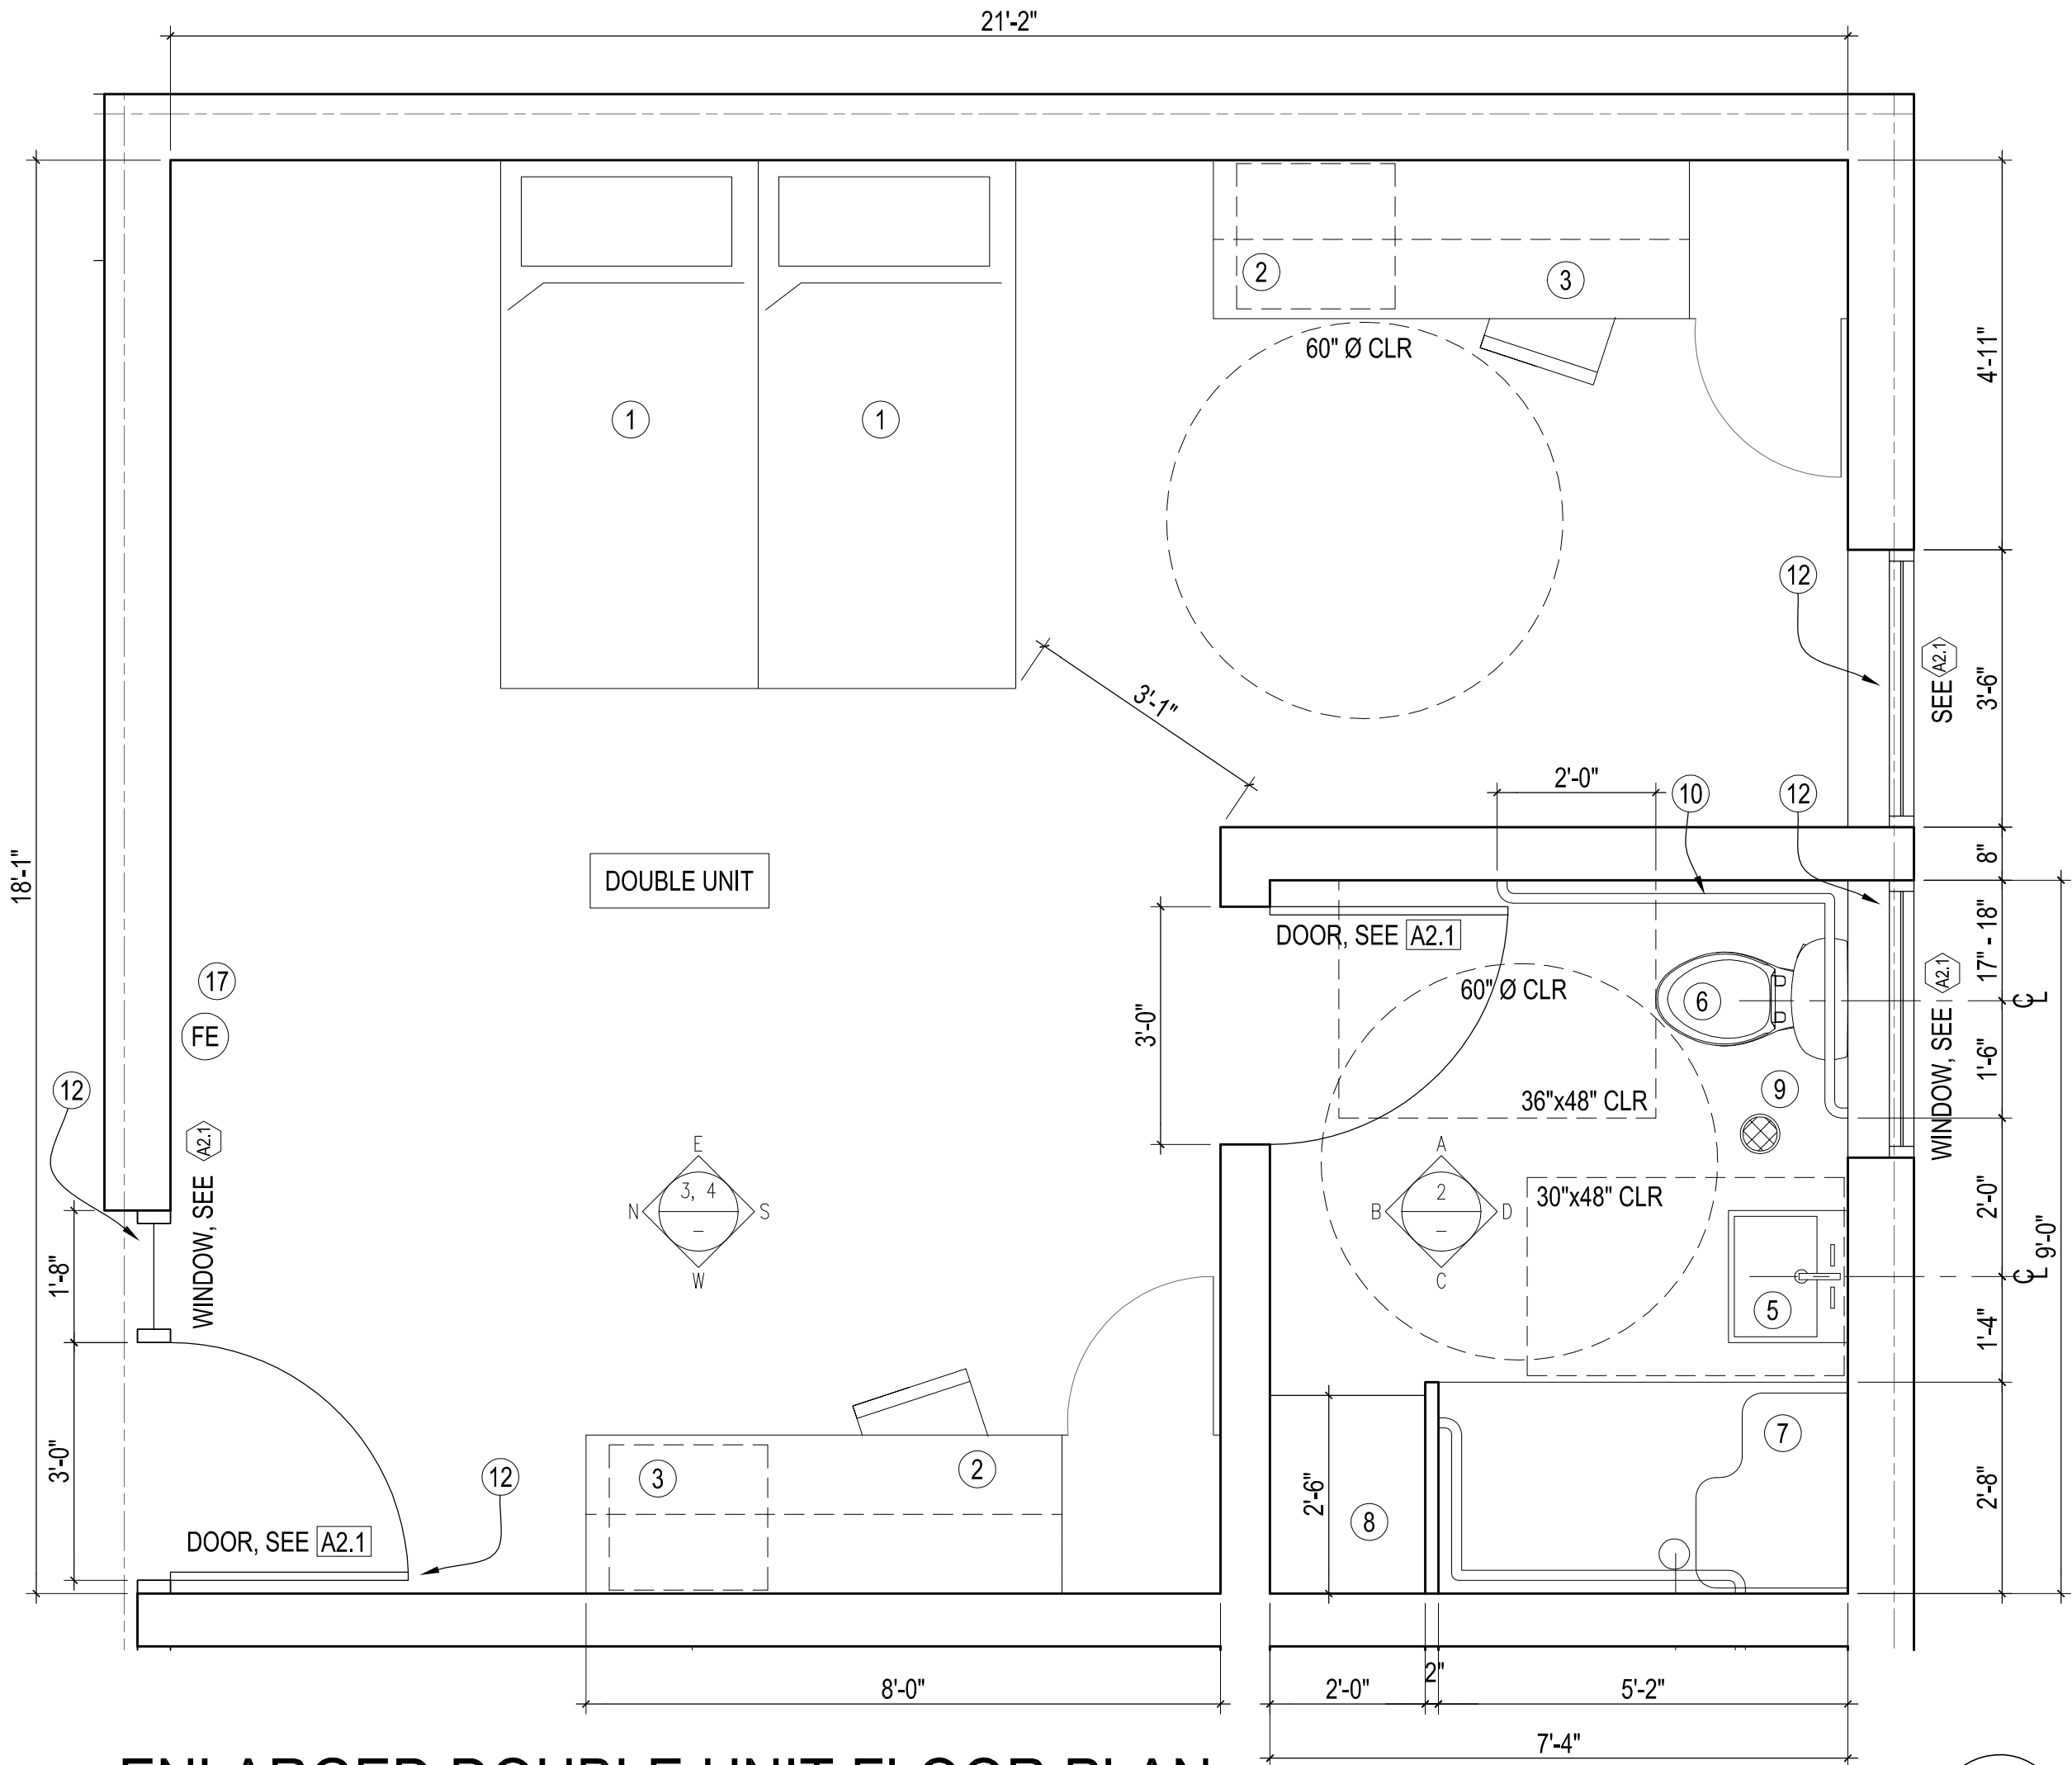


1  
A2.5

## ENLARGED DOUBLE UNIT FLOOR PLAN

1/2" = 1'-0"




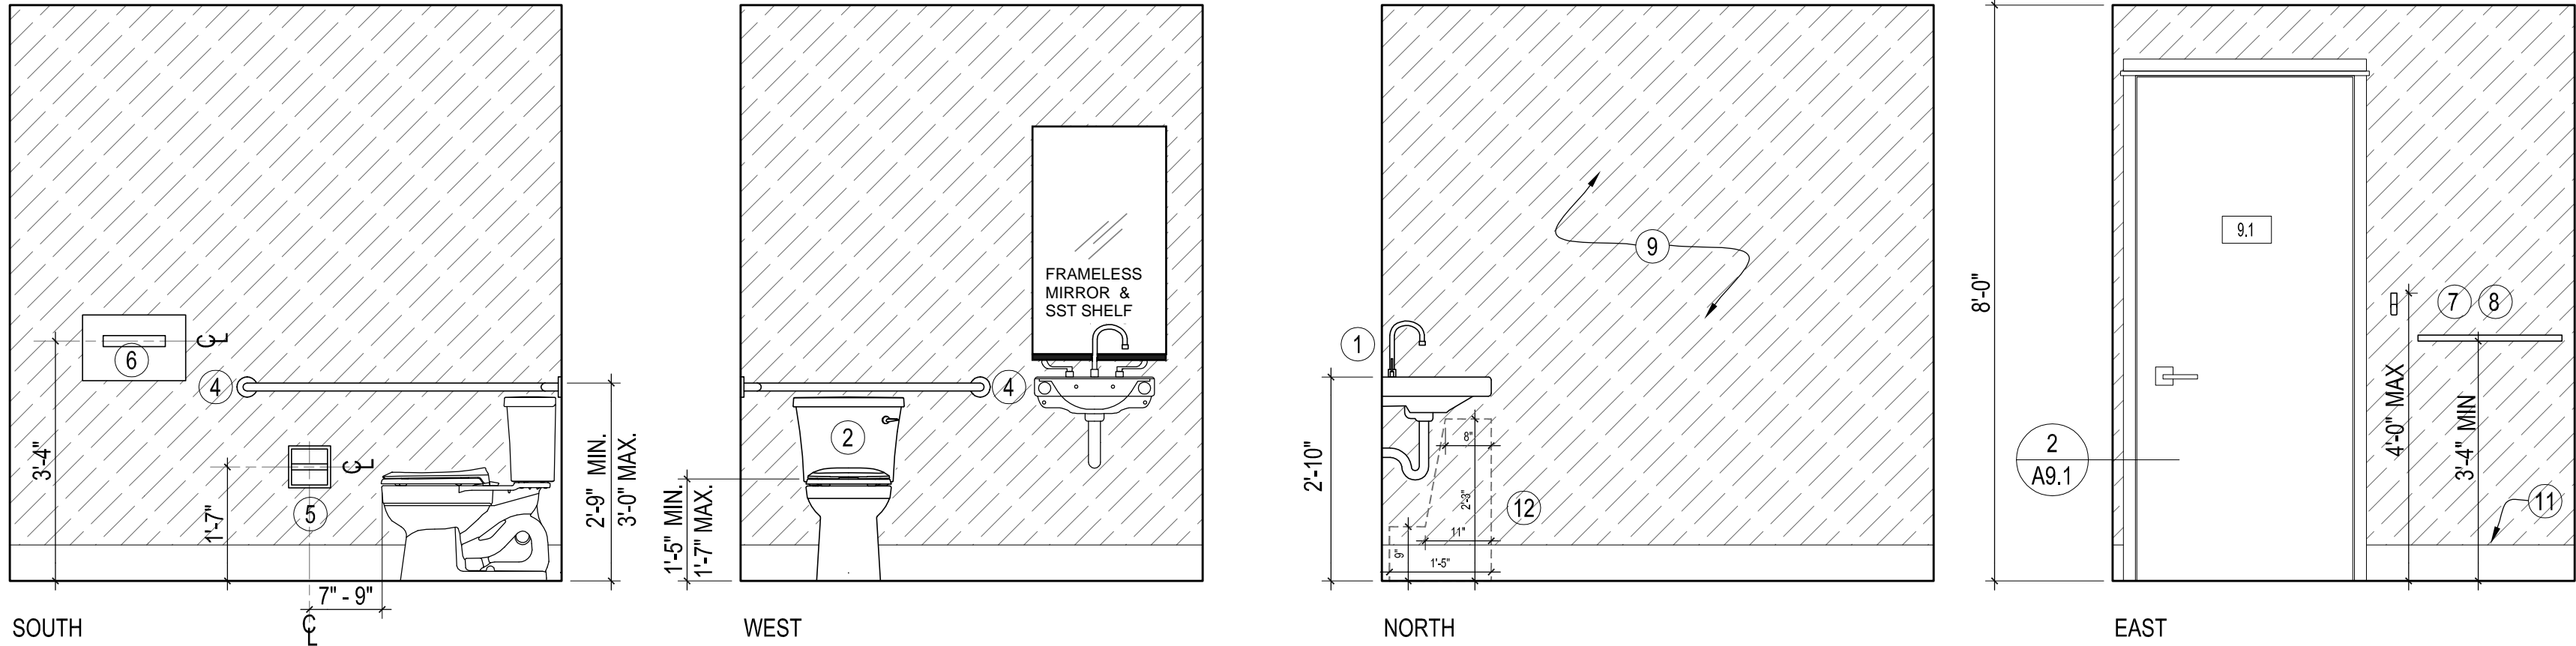

09 RESTROOM INTERIOR ELEVATIONS

4  
A2.6


1/2" = 1'-0"

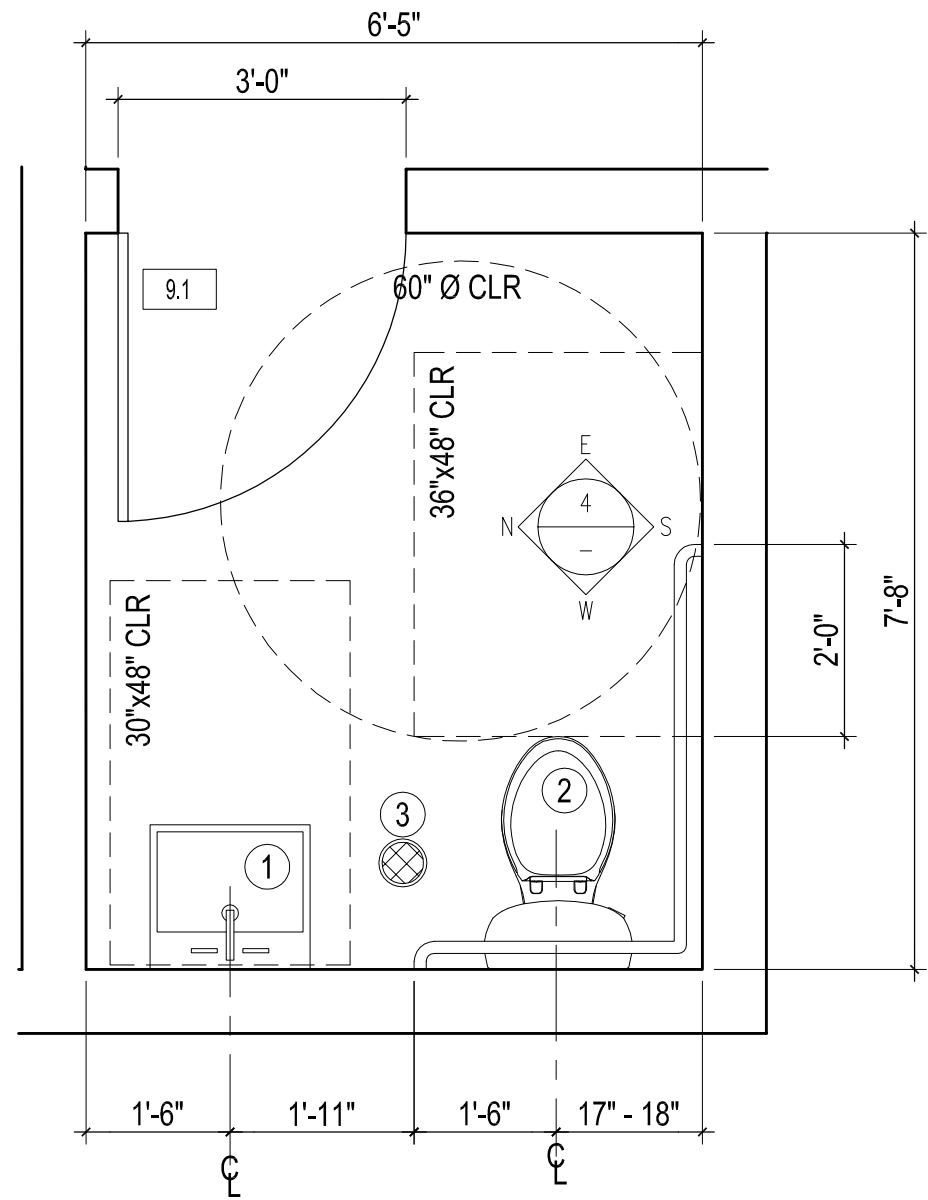

ENLARGED 09 RESTROOM FLOOR PLAN

3  
A2.6


1/2" = 1'-0"

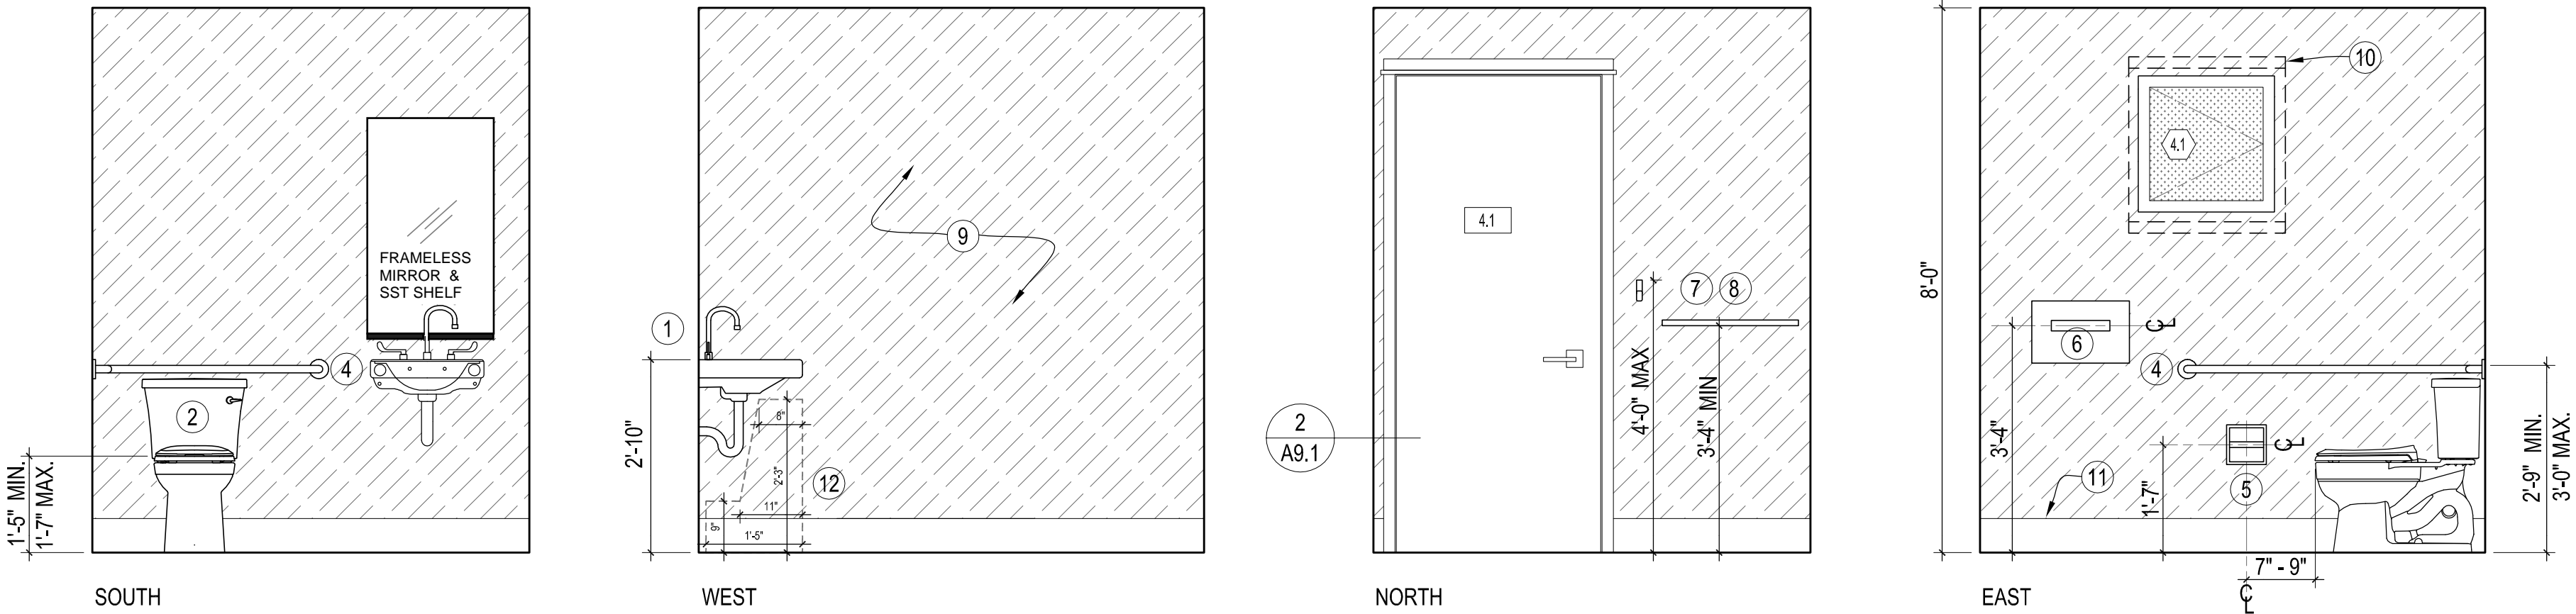

04 RESTROOM INTERIOR ELEVATIONS

2  
A2.6

1/2" = 1'-0"

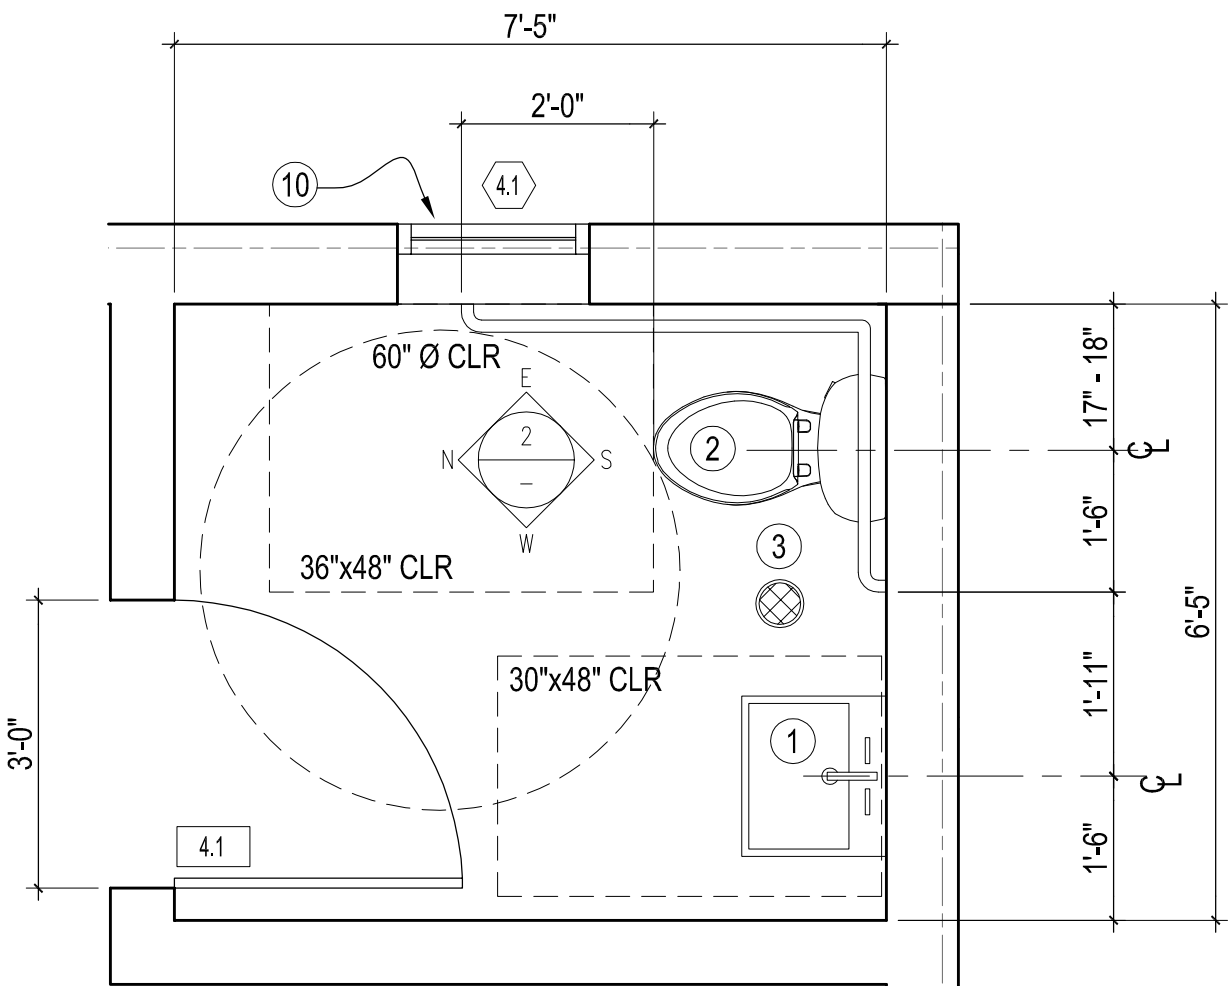

ENLARGED 04 RESTROOM FLOOR PLAN

1  
A2.6

1/2" = 1'-0"

RESTROOM FLOOR PLAN KEY NOTES

- 1 WALL MOUNTED SINK
- 2 TOILET
- 3 FLOOR DRAIN
- 4 GRAB BAR
- 5 TISSUE HOLDER
- 6 SEAT PAPER DISPENSER
- 7 COAT HOOK
- 8 SHELF
- 9 FRP WALL PANELING, FULL HEIGHT
- 10 WINDOW COVERING
- 11 6" COVE BASE
- 12 MIN. KNEE CLEARANCES

RESTROOM FLOOR PLAN GENERAL NOTES:

1. DESIGN DEVELOPMENT DRAWINGS ARE INTENDED FOR RFP PRICING AND NOT FOR CONSTRUCTION. FOLLOWING CONTRACTOR SELECTION PROCESS, DRAWINGS AND SPECIFICATIONS WILL BE PREPARED FOR PERMITTING AND CONSTRUCTION.
2. GRIDLINE INDICATES FACE OF FRAMING, SEE STRUCTURAL.
3. SEE A3.0 FOR ASSEMBLY KEYNOTE LEGEND.
4. ALL INTERIOR WALLS TO BE WALL TYPE 2 UNLESS NOTED OTHERWISE.
5. SEE A0.2 AND A0.3 FOR CODE COMPLIANCE AND ACCESSIBILITY REQUIREMENTS.



Ojai Permanent Supportive Housing

611 South Montgomery Street, Ojai California

Drawn By:	DJ	
Checked By:		
Job No.	2407	
Revisions:		
No.	Date	By


NOT FOR CONSTRUCTION

25 July 2025

Design  
Development

Storage  
Building

A2.7

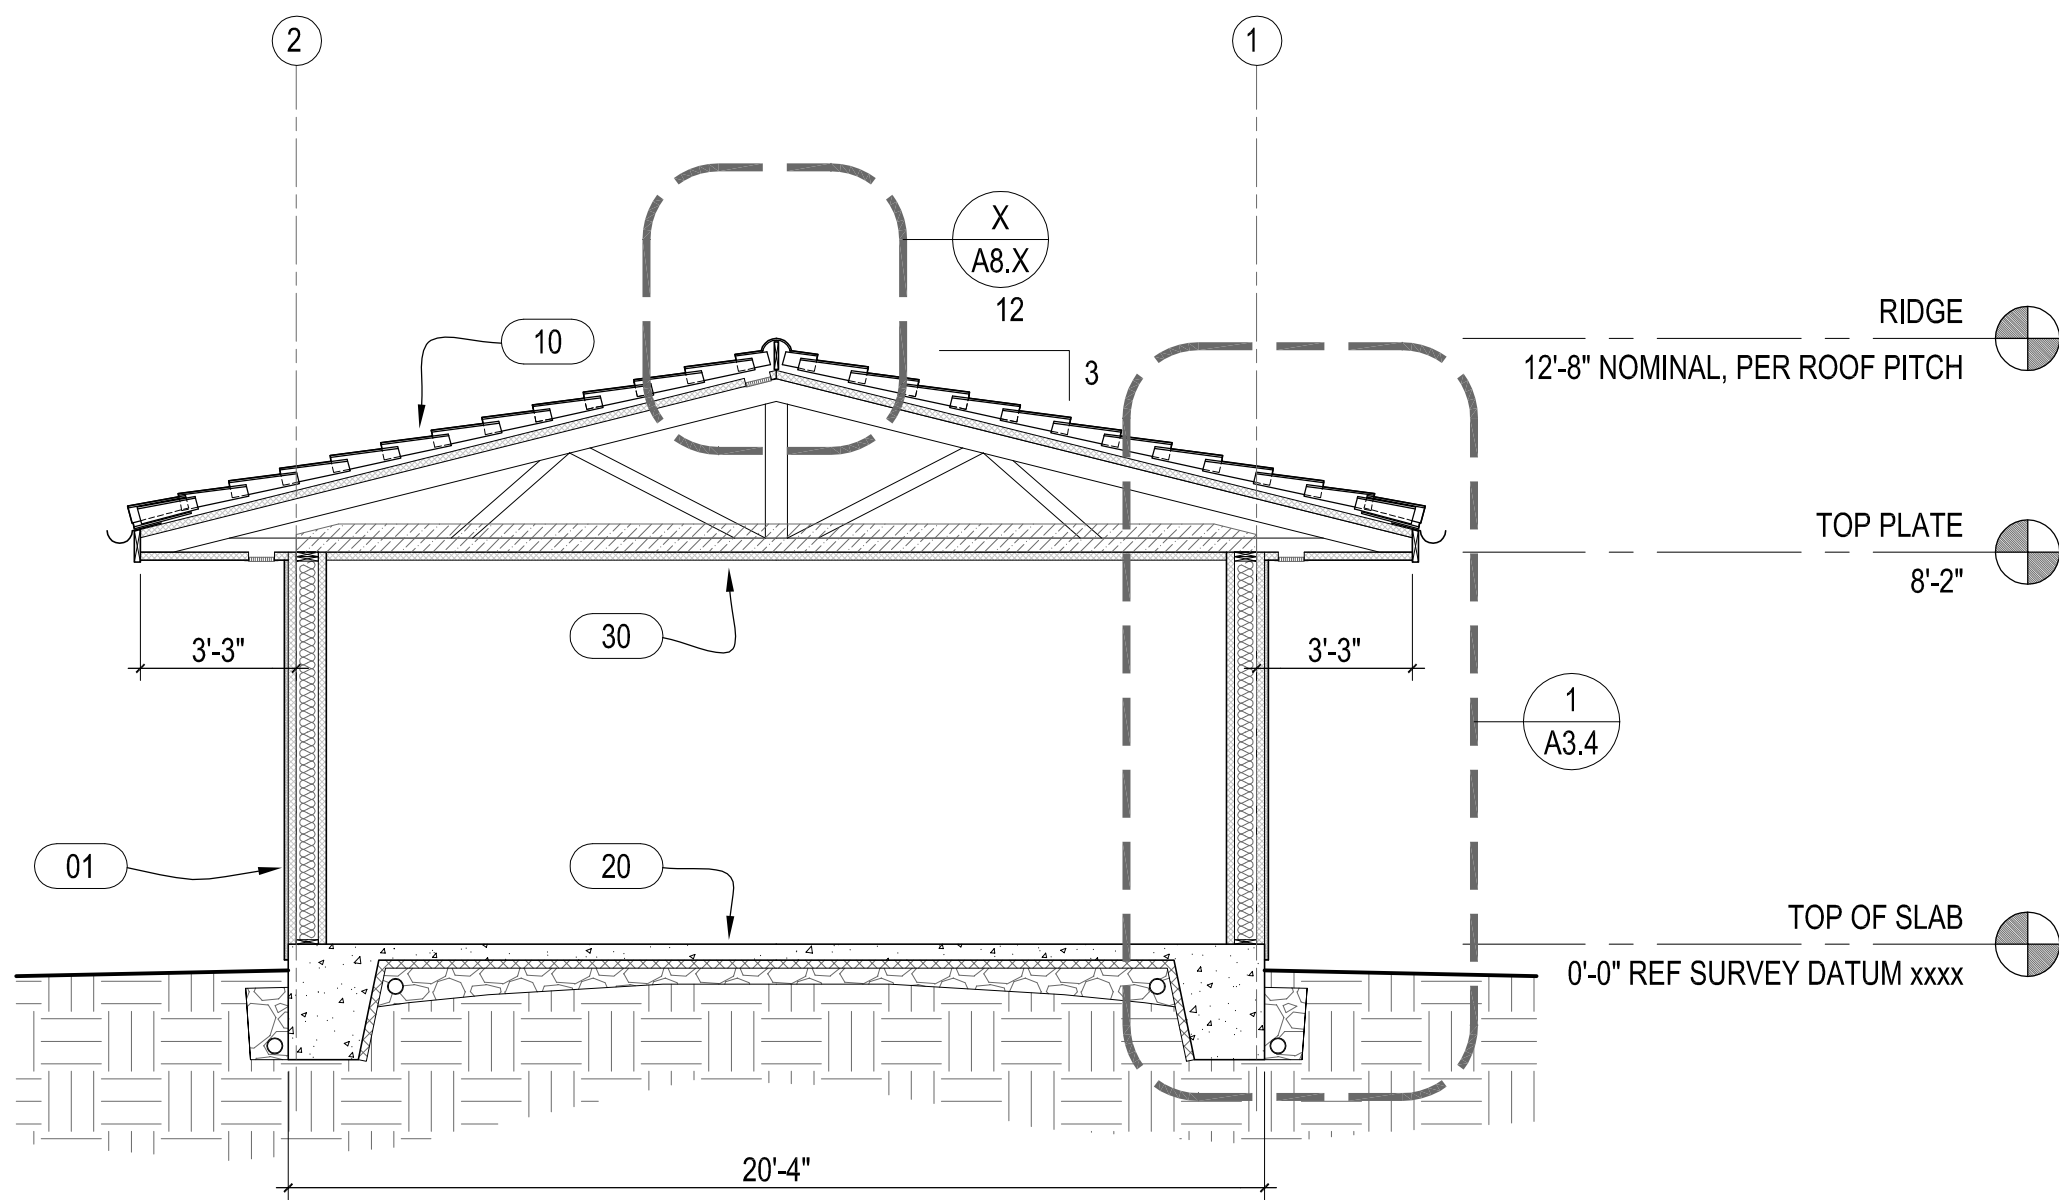

BUILDING SECTION


7  
A2.7  
1/4" = 1'-0"

STORAGE BUILDING ELEVATION KEY NOTES

- 1 STUCCO, SEE A3.0
- 2 GUTTER AND DOWNSPOUT
- 3 ROOFING, SEE A3.0
- 4 INTUMESCENT GABLE VENT


STORAGE BUILDING GENERAL NOTES:

1. DESIGN DEVELOPMENT DRAWINGS ARE INTENDED FOR RFP PRICING AND NOT FOR CONSTRUCTION. FOLLOWING CONTRACTOR SELECTION PROCESS, DRAWINGS AND SPECIFICATIONS WILL BE PREPARED FOR PERMITTING AND CONSTRUCTION.
2. GRIDLINE INDICATES FACE OF FRAMING. SEE STRUCTURAL.
3. SEE A3.0 FOR ASSEMBLY KEYNOTE LEGEND.
4. SEE A0.2 FOR CODE COMPLIANCE AND ACCESSIBILITY REQUIREMENTS.

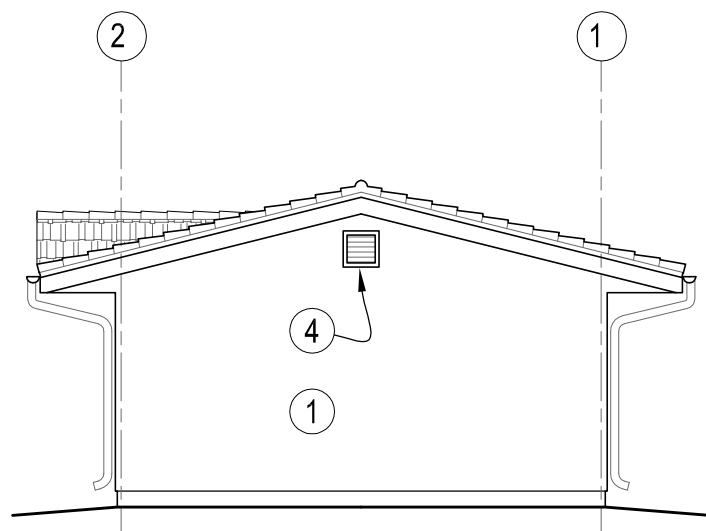


EAST ELEVATION

6  
A2.7  
1/8" = 1'-0"

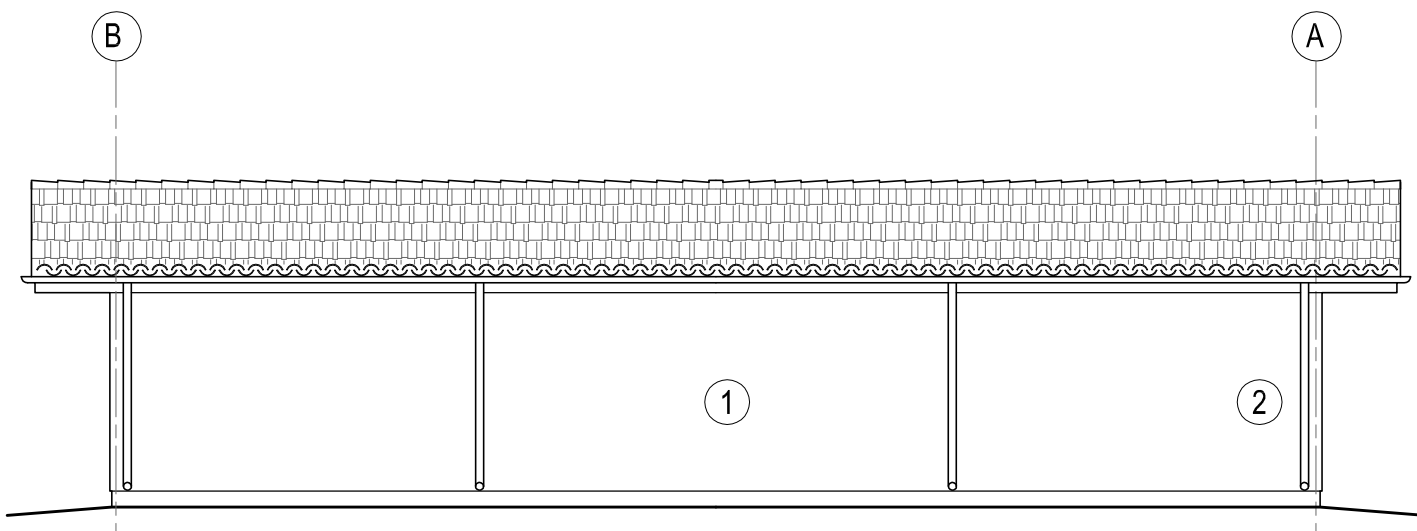


NORTH ELEVATION

5  
A2.7  
1/8" = 1'-0"

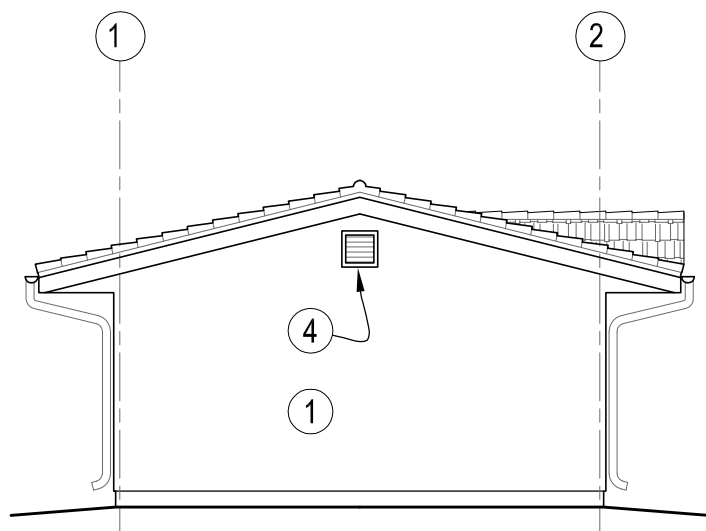


WEST ELEVATION

4  
A2.7  
1/8" = 1'-0"

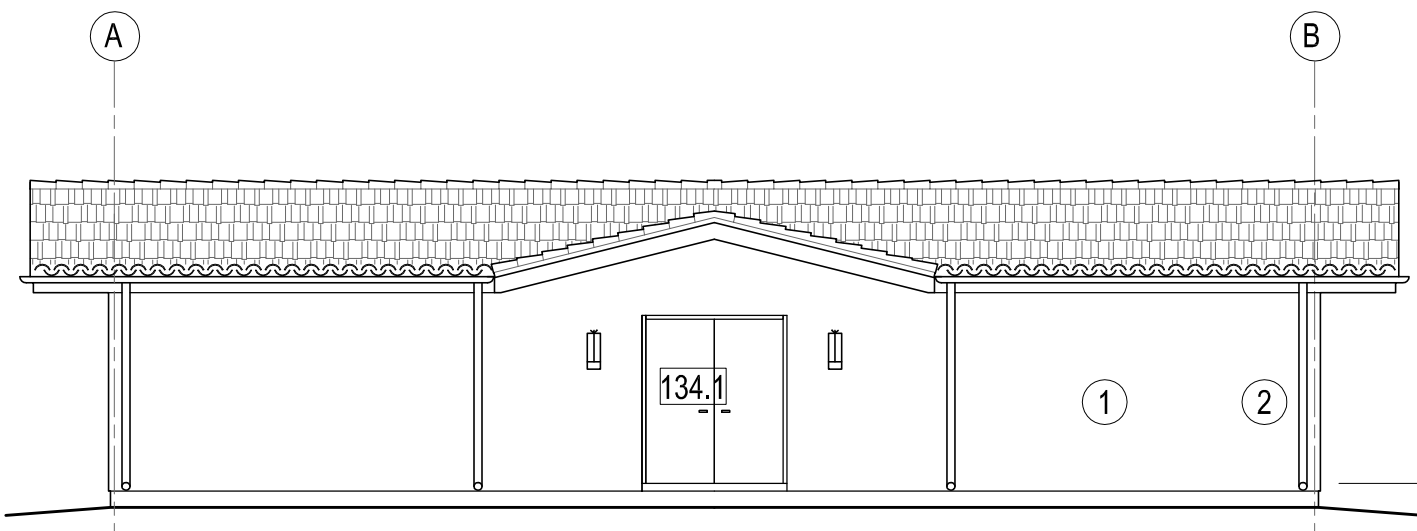


SOUTH ELEVATION

3  
A2.7  
1/8" = 1'-0"

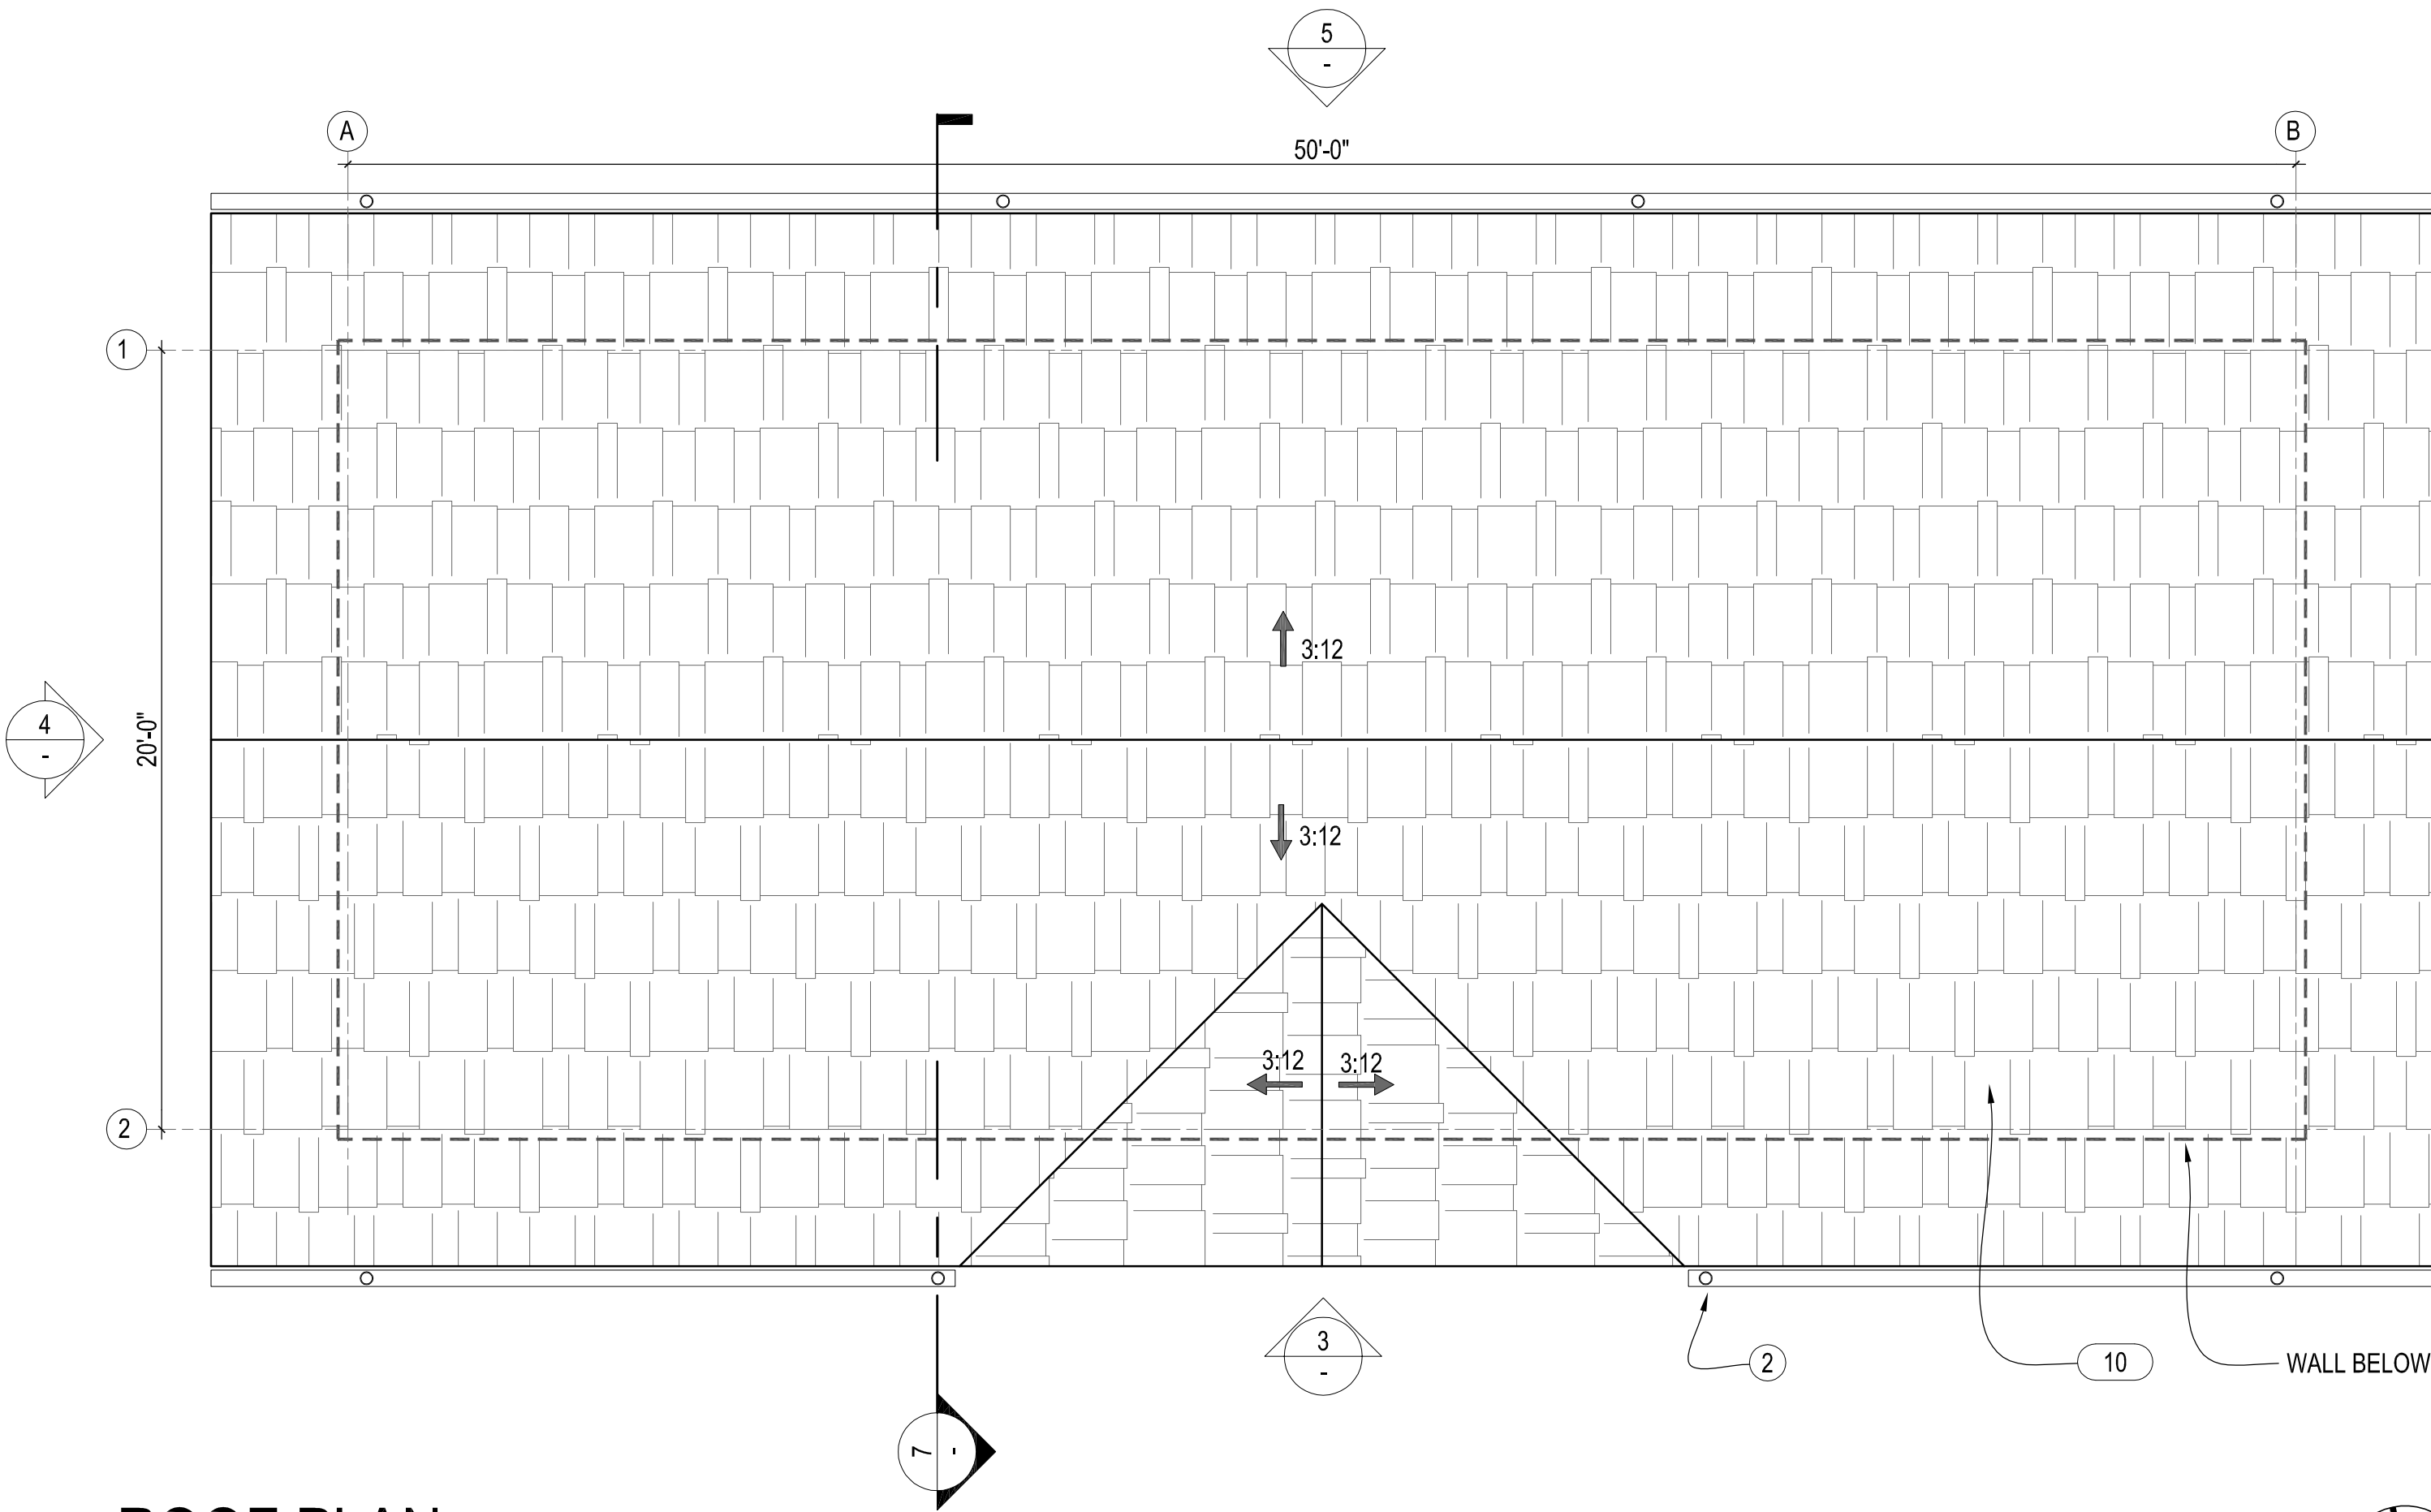

ROOF PLAN

2  
A2.7  
1/4" = 1'-0"

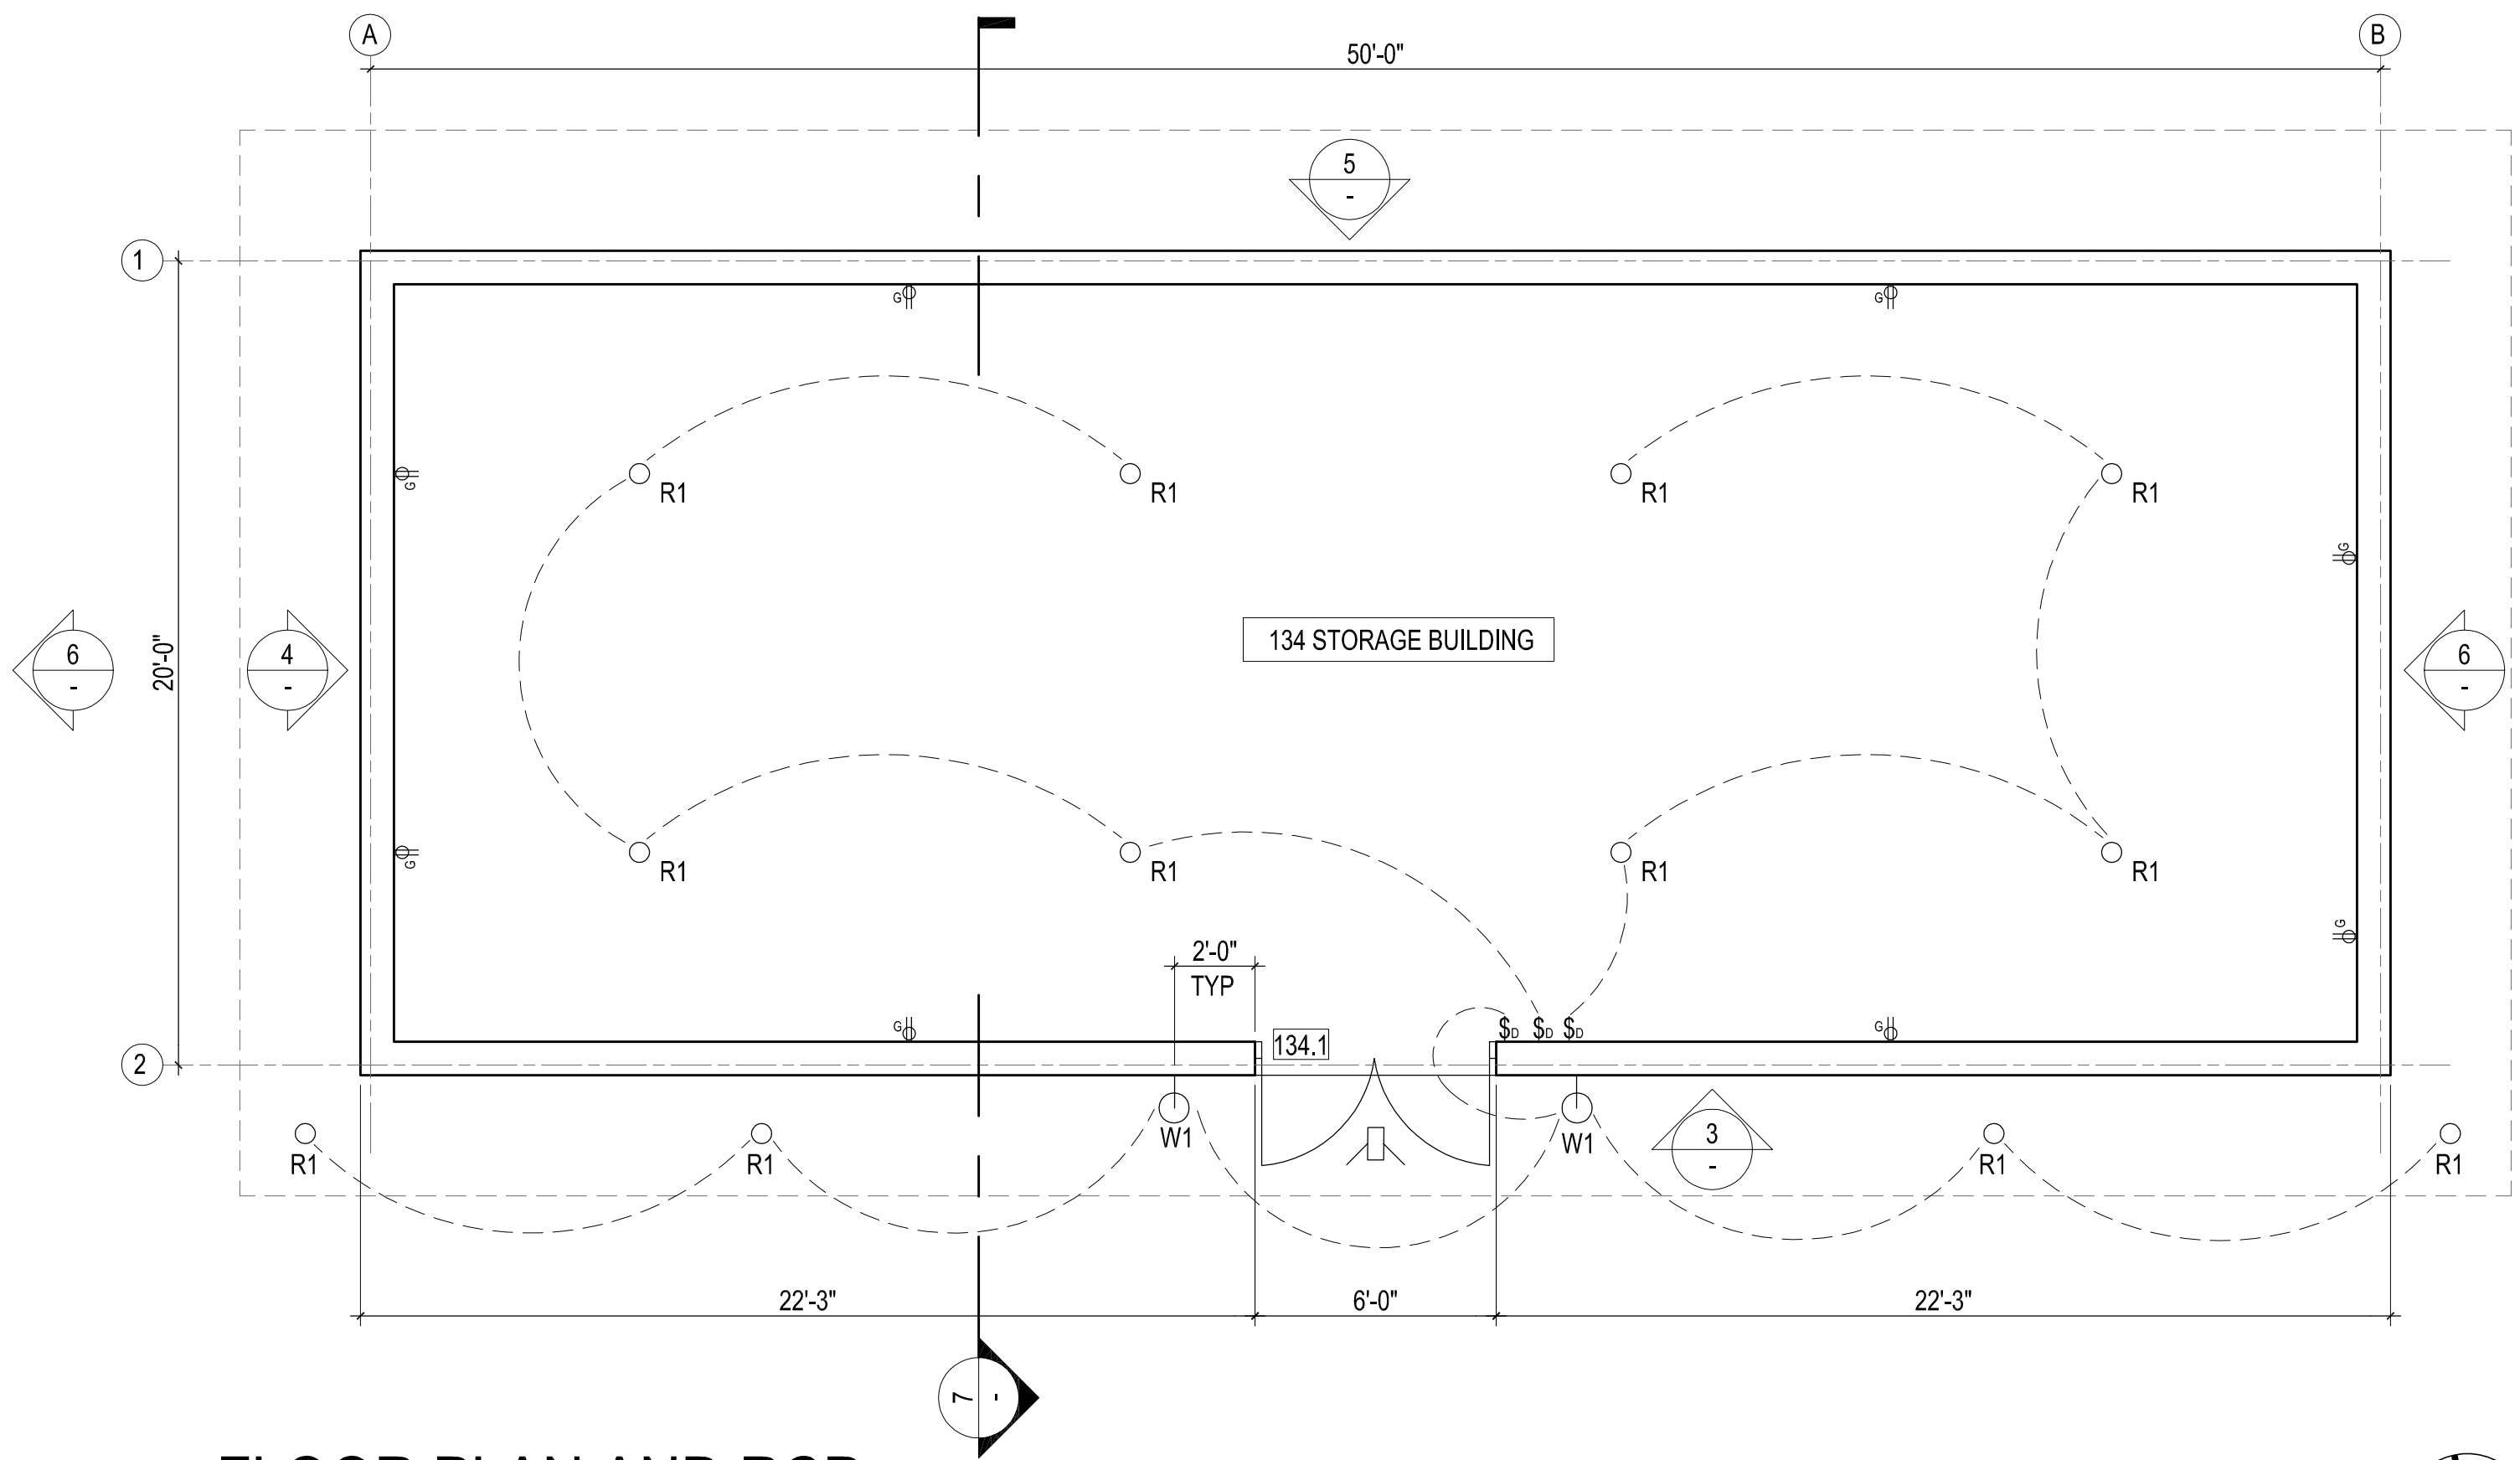

FLOOR PLAN AND RCP

1  
A2.7  
1/4" = 1'-0"

SEE A6.1 FOR RCP NOTES AND LEGENDS



Ojai Permanent Supportive Housing

611 South Montgomery Street, Ojai California


Drawn By:	DJ	
Checked By:		
Job No.	2407	
Revisions:		
No.	Date	By

NOT FOR CONSTRUCTION

25 July 2025


Design  
Development

Trash  
Enclosure  
A2.8

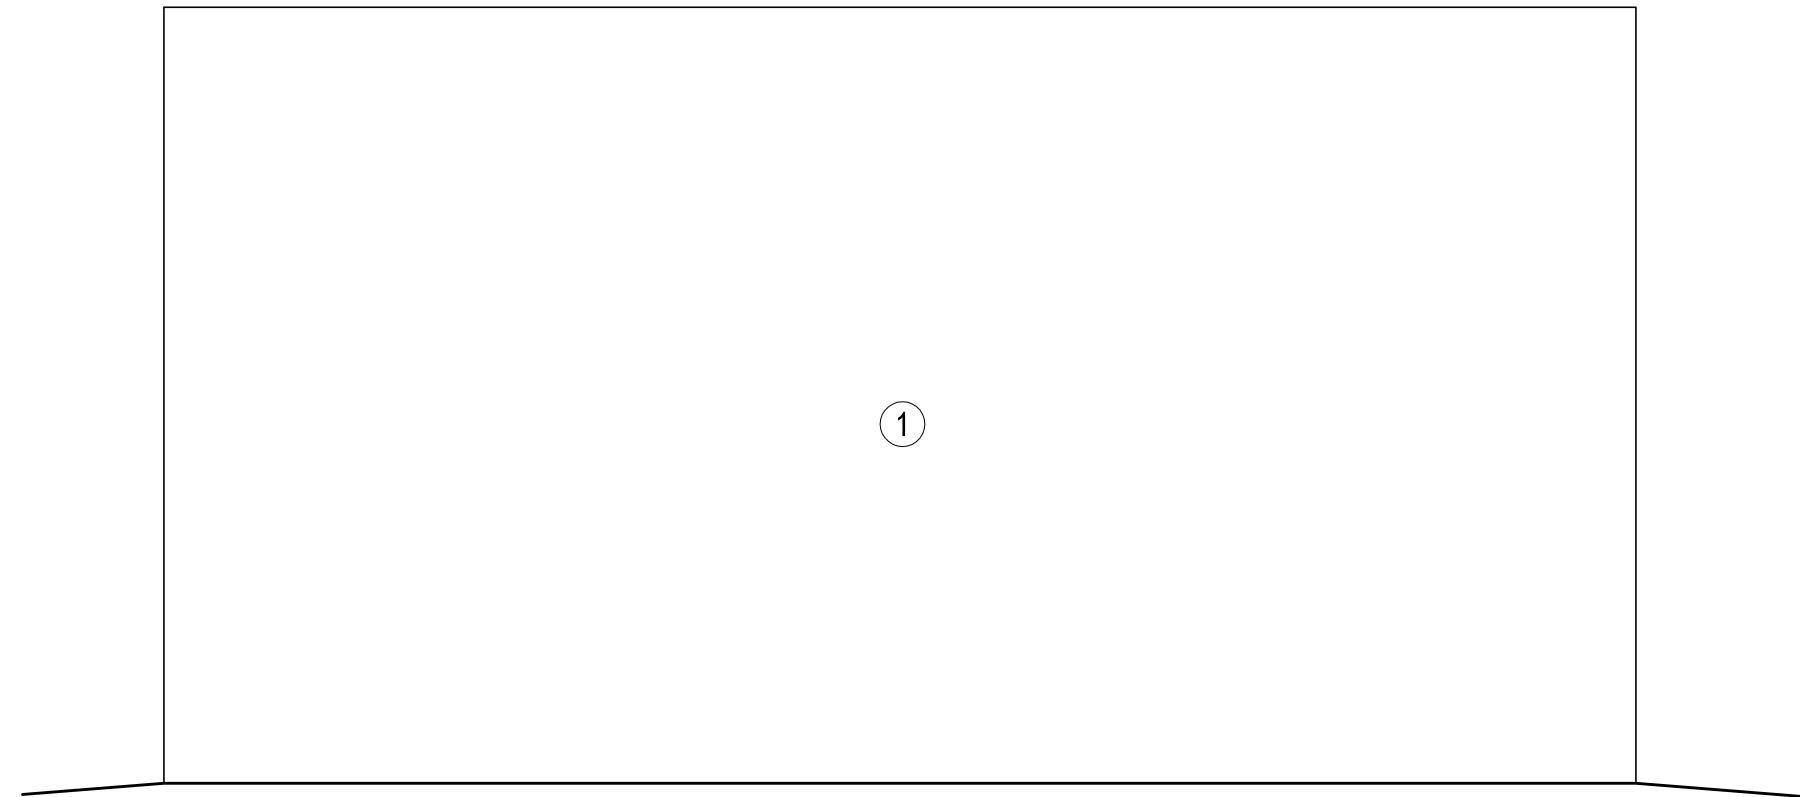


4  
A2.8  
1/2" = 1'-0"

WEST AND EAST ELEVATION

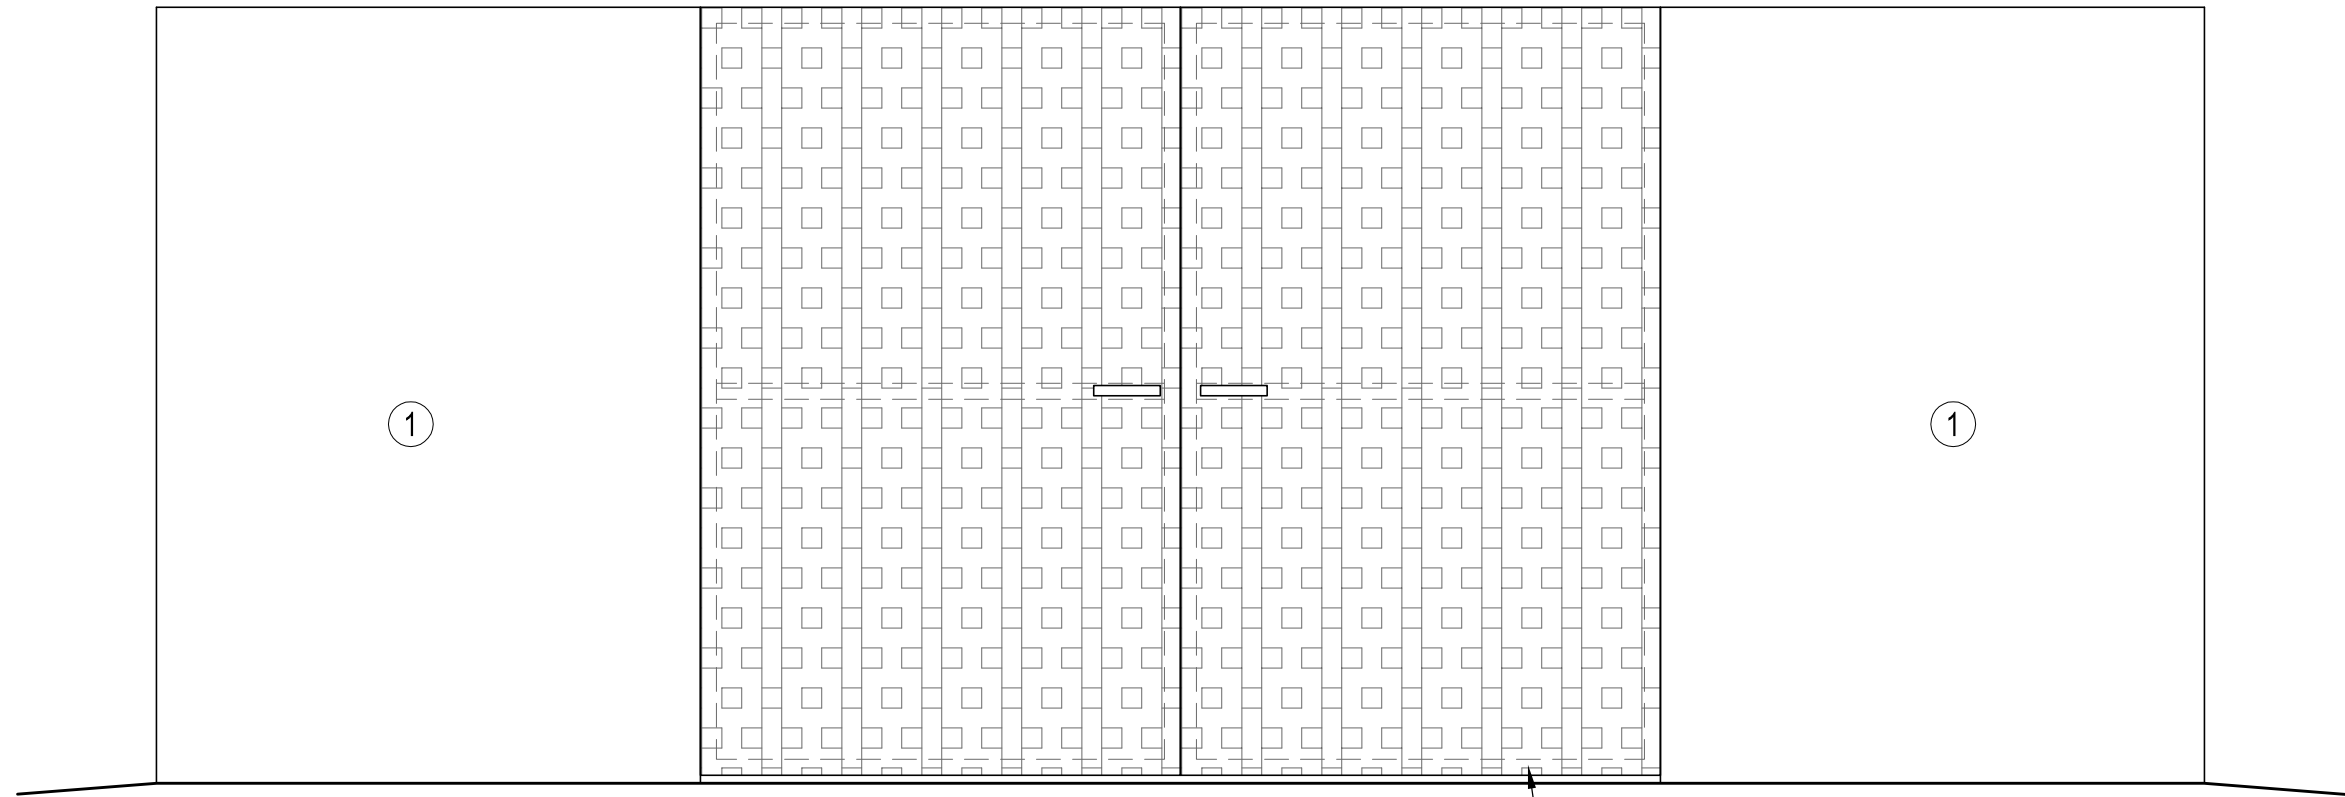


3  
A2.8  
1/2" = 1'-0"

SOUTH ELEVATION - NORTH SIMILAR

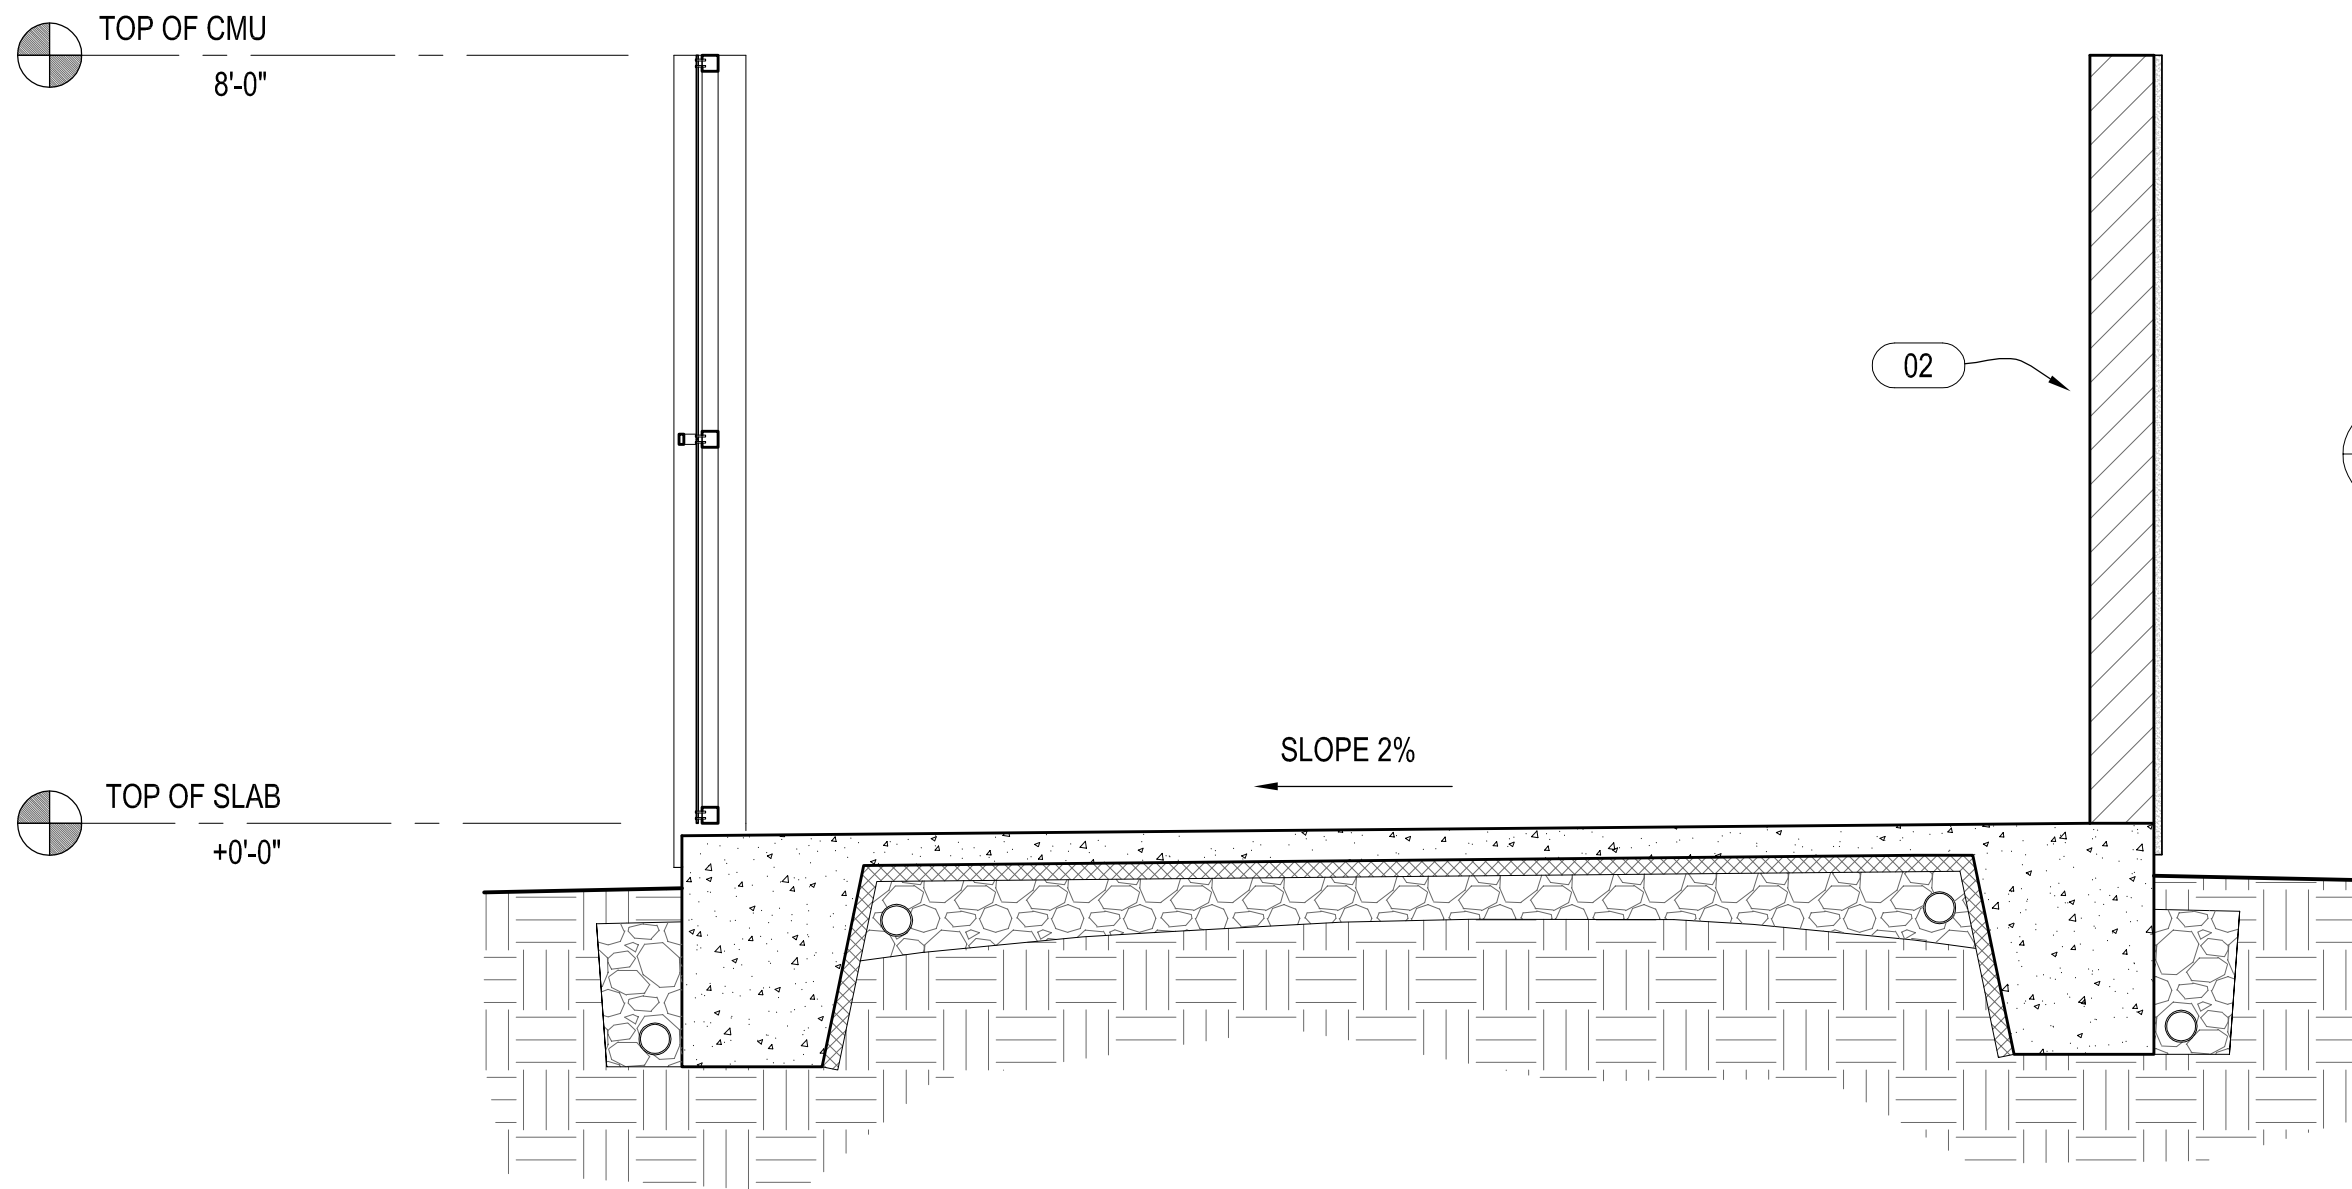

2  
A2.8  
1/2" = 1'-0"

SECTION

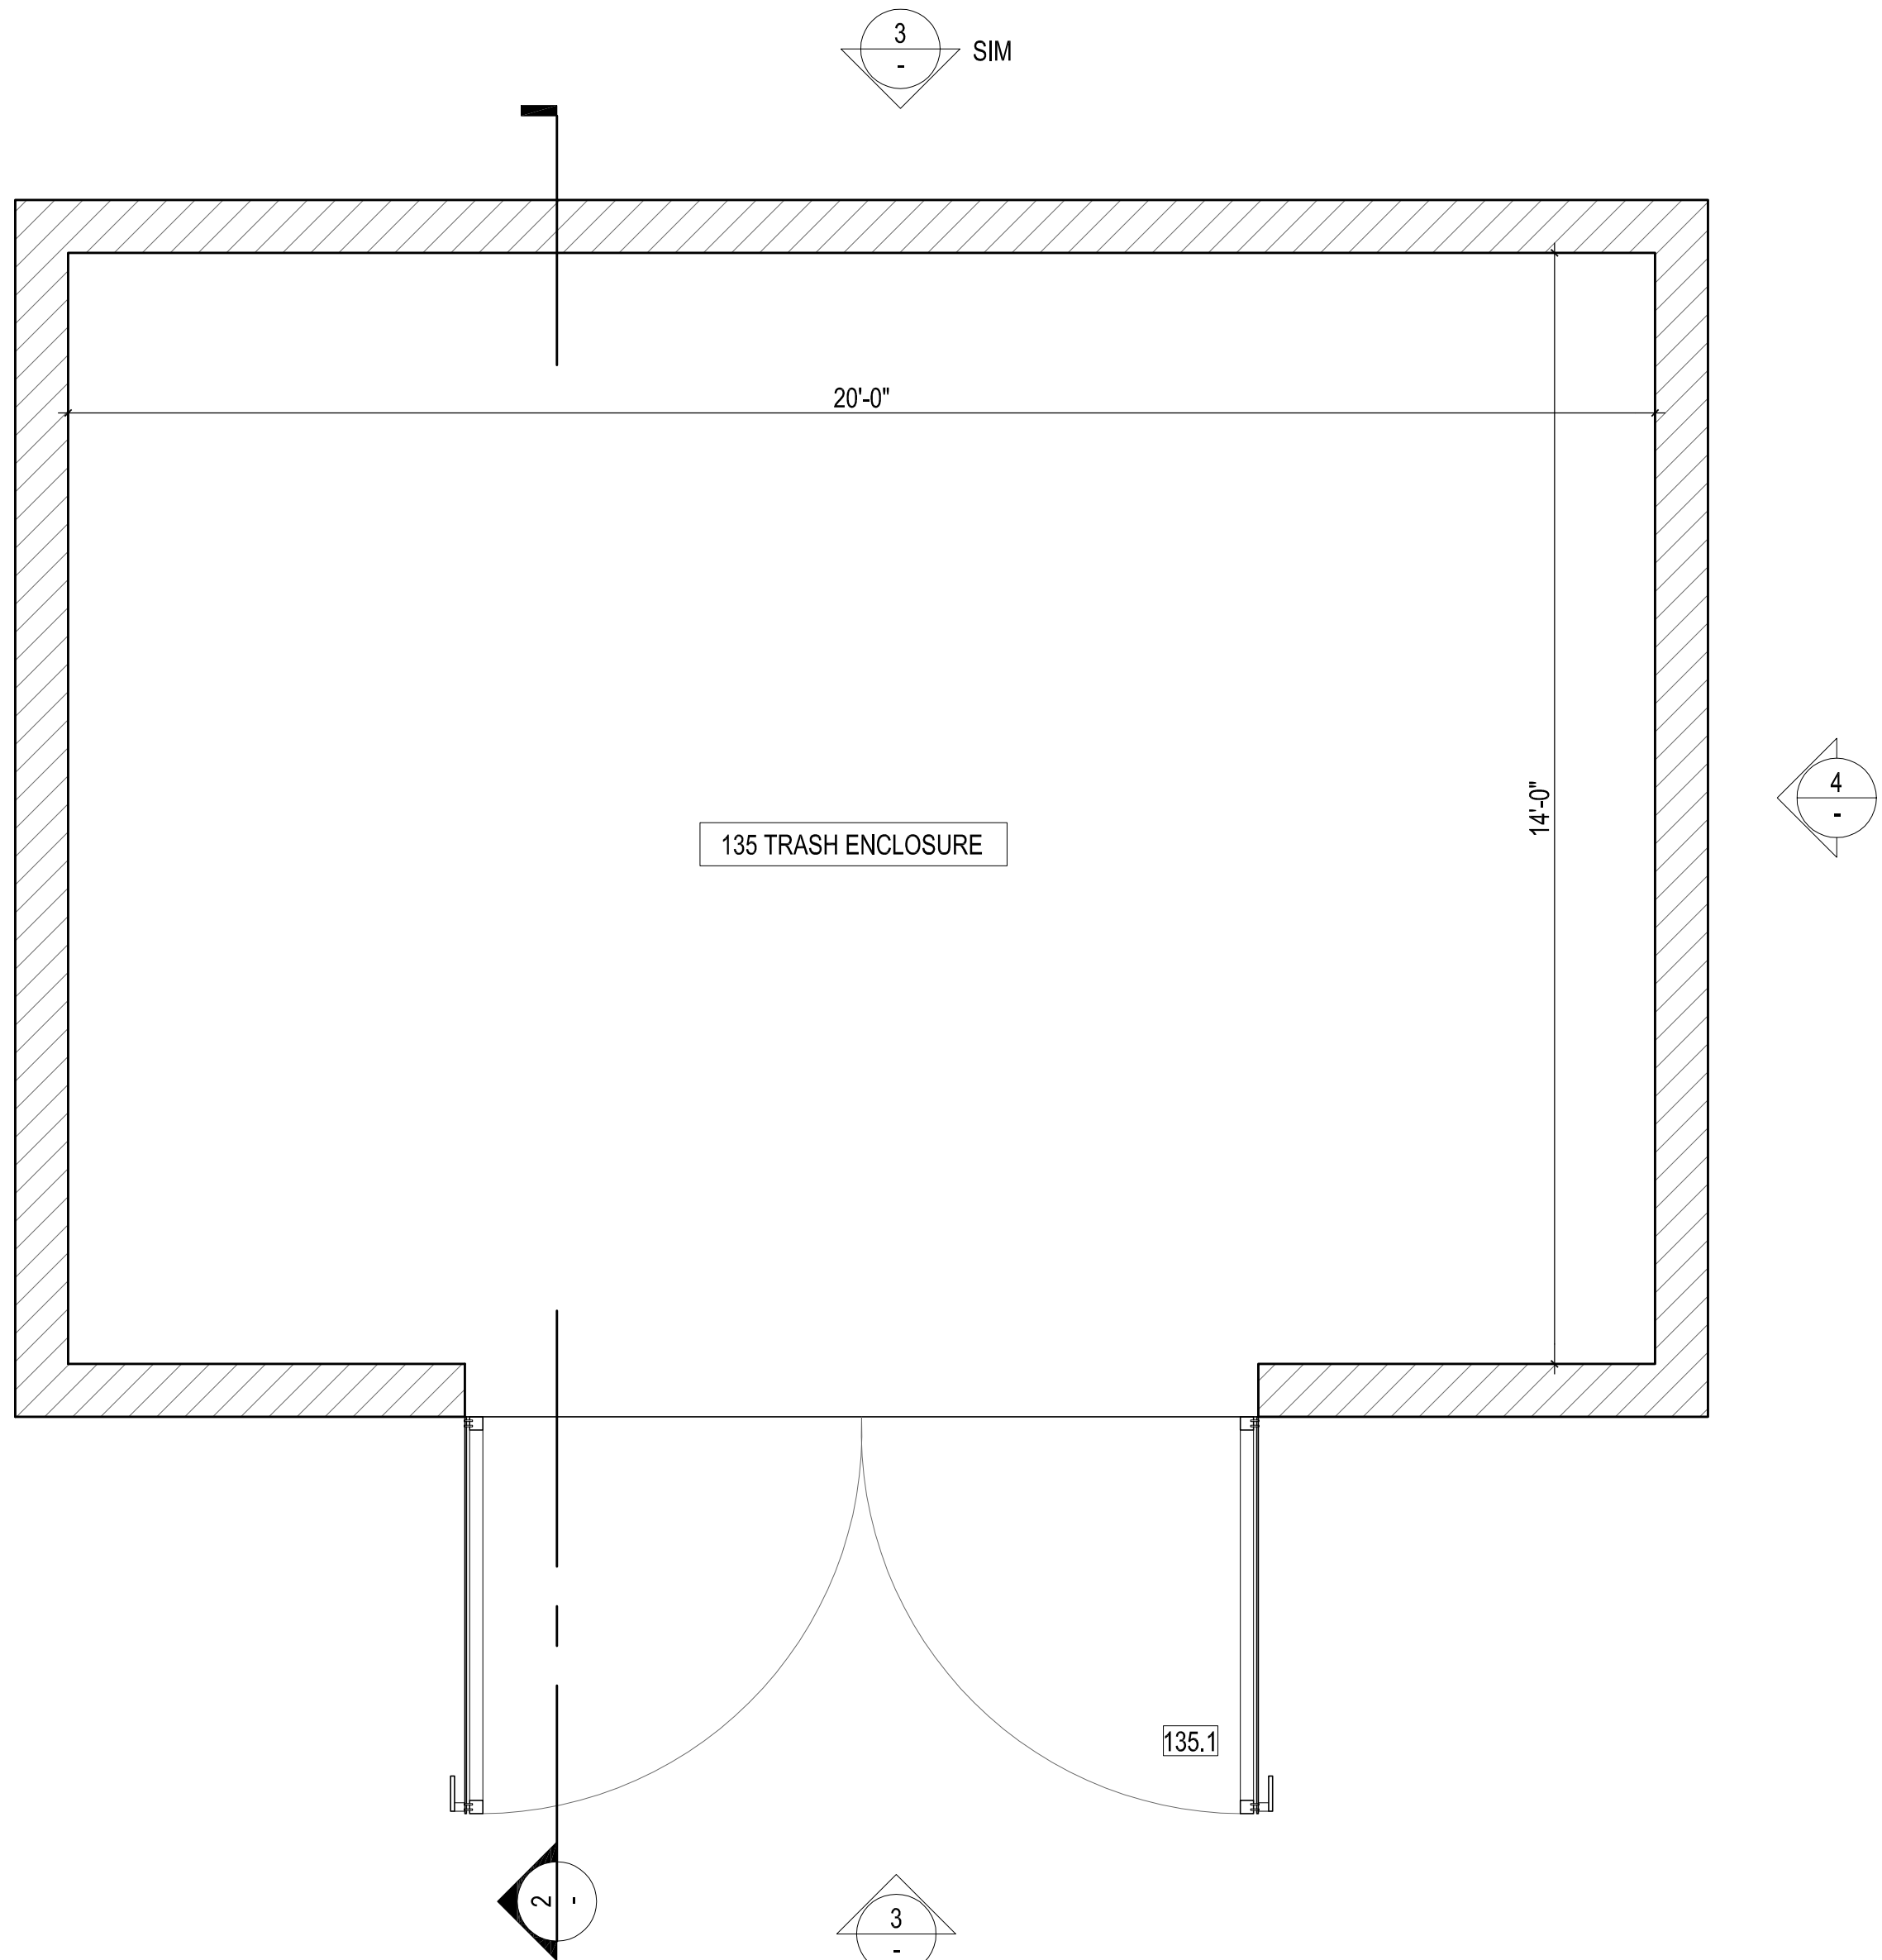

1  
A2.7  
1/2" = 1'-0"

FLOOR PLAN

TRASH ENCLOSURE KEY NOTES  
1 STUCCO, SEE A3.0

TRASH ENCLOSURE GENERAL NOTES:  
1. DESIGN DEVELOPMENT DRAWINGS ARE INTENDED FOR RFP PRICING AND NOT FOR CONSTRUCTION. FOLLOWING CONTRACTOR SELECTION PROCESS, DRAWINGS AND SPECIFICATIONS WILL BE PREPARED FOR PERMITTING AND CONSTRUCTION.  
2. SEE A3.0 FOR ASSEMBLY KEYNOTE LEGEND.  
3. SEE A0.2 FOR CODE COMPLIANCE AND ACCESSIBILITY REQUIREMENTS.




DOOR TAG	ROOM #	ROOM NAME	TYPE	MFR	FINISH	THICKNESS	NOMINAL WDTH	NOMINAL HT	HARDWARE	HARDWARE	HARDWARE	GLASS	DIVIDED LITE	U-VALUE	SHGC	REMARKS	DOOR TAG
							VERIFY RO	VERIFY RO	SPEC	TYPE	FINISH	TYPE	PATTERN				
1.1	1	ENTRY HALL	E	SIMPSON SOLID CORE SLAB OR EQUAL	CORDOBAN BROWN	1-3/4"	5'-8"	7'-0"	SCHLAGE MB15 ELECTRONIC READER SYSTEMS, ADA LEVERS		DARK BRONZE					PAIR 2'-10"	1.1
1.2			E	SIMPSON SOLID CORE SLAB OR EQUAL	CORDOBAN BROWN	1-3/4"	5'-8"	7'-0"	SCHLAGE MB15 ELECTRONIC READER SYSTEMS, ADA LEVERS		DARK BRONZE					PAIR 2'-10"	1.2
2.1	2	GATHERING SPACE	B	SIMPSON SOLID CORE SLAB OR EQUAL	CORDOBAN BROWN	1-3/4"	3'-0"	7'-0"	SCHLAGE MB15 ELECTRONIC READER SYSTEMS, ADA LEVERS		DARK BRONZE	WUI	1 x 1	TBD	TBD	MULLED UNIT	2.1
3.1	3	PANTRY	E	SIMPSON SOLID CORE SLAB OR EQUAL	CORDOBAN BROWN	1-3/4"	5'-8"	7'-0"	SCHLAGE MB15 ELECTRONIC READER SYSTEMS, ADA LEVERS		DARK BRONZE					PAIR 2'-10"	3.1
4.1	4	REST ROOM	D	SIMPSON SOLID CORE SLAB OR EQUAL	PAINT TBD	1-3/8"	3'-0"	7'-0"	ADA PASSAGE LEVEL WITH A ONE-SIDED DEADBOLT AND OCCUPANCY INDICATOR		DARK BRONZE						4.1
5.1	5	HALL	A	SIMPSON SOLID CORE SLAB OR EQUAL	CORDOBAN BROWN	1-3/4"	3'-0"	7'-0"	SCHLAGE MB15 ELECTRONIC READER SYSTEMS, ADA LEVERS		DARK BRONZE	WUI	1 x 1	TBD	TBD	MULLED UNIT	5.1
5.2			D	SIMPSON SOLID CORE SLAB OR EQUAL	CORDOBAN BROWN	1-3/8"	3'-0"	7'-0"	SCHLAGE MB15 ELECTRONIC READER SYSTEMS, ADA LEVERS		DARK BRONZE						5.2
6.1	6	CHECK IN OFFICE	B	SIMPSON SOLID CORE SLAB OR EQUAL	CORDOBAN BROWN	1-3/4"	3'-0"	7'-0"	SCHLAGE MB15 ELECTRONIC READER SYSTEMS, ADA LEVERS		DARK BRONZE	WUI	1 x 1	TBD	TBD	MULLED UNIT	6.1
7.1	7	SECURITY OFFICE	A	SIMPSON SOLID CORE SLAB OR EQUAL	CORDOBAN BROWN	1-3/4"	3'-0"	7'-0"	SCHLAGE MB15 ELECTRONIC READER SYSTEMS, ADA LEVERS		DARK BRONZE	WUI	1 x 1	TBD	TBD	MULLED UNIT	7.1
8.1	8	OFFICE SUPPORT	D	SIMPSON SOLID CORE SLAB OR EQUAL	PAINT TBD	1-3/8"	3'-0"	7'-0"	SCHLAGE MB15 ELECTRONIC READER SYSTEMS, ADA LEVERS		DARK BRONZE						8.1
9.1	9	REST ROOM	D	SIMPSON SOLID CORE SLAB OR EQUAL	PAINT TBD	1-3/8"	3'-0"	7'-0"	ADA PASSAGE LEVEL WITH A ONE-SIDED DEADBOLT AND OCCUPANCY INDICATOR		DARK BRONZE						9.1
10.1	10	LAUNDRY	D	SIMPSON SOLID CORE SLAB OR EQUAL	CORDOBAN BROWN	1-3/4"	3'-0"	7'-0"	SCHLAGE MB15 ELECTRONIC READER SYSTEMS, ADA LEVERS		DARK BRONZE						10.1
10.2			D	SIMPSON SOLID CORE SLAB OR EQUAL	PAINT TBD	1-3/8"	3'-0"	7'-0"	SCHLAGE MB15 ELECTRONIC READER SYSTEMS, ADA LEVERS		DARK BRONZE						10.2
11.1	11	MECHANICAL	E	SIMPSON SOLID CORE SLAB OR EQUAL	CORDOBAN BROWN	1-3/4"	5'-8"	7'-0"	SCHLAGE MB15 ELECTRONIC READER SYSTEMS, ADA LEVERS		DARK BRONZE					PAIR 2'-10"	11.1
101.1	101	SINGLE UNIT	B	SIMPSON SOLID CORE SLAB OR EQUAL	CORDOBAN BROWN	1-3/4"	3'-0"	7'-0"	SCHLAGE MB15 ELECTRONIC READER SYSTEMS, ADA LEVERS		DARK BRONZE	WUI	1 x 1	TBD	TBD	MULLED UNIT	101.1
101.2			C	SIMPSON SOLID CORE SLAB OR EQUAL	PAINT TBD	1-3/8"	3'-0"	7'-0"	PRMVACY		DARK BRONZE						101.2
102.1	102	SINGLE UNIT	A	SIMPSON SOLID CORE SLAB OR EQUAL	CORDOBAN BROWN	1-3/4"	3'-0"	7'-0"	SCHLAGE MB15 ELECTRONIC READER SYSTEMS, ADA LEVERS		DARK BRONZE	WUI	1 x 1	TBD	TBD	MULLED UNIT	102.1
102.2			C	SIMPSON SOLID CORE SLAB OR EQUAL	PAINT TBD	1-3/8"	3'-0"	7'-0"	PRMVACY		DARK BRONZE						102.2
103.1	103	SINGLE UNIT	B	SIMPSON SOLID CORE SLAB OR EQUAL	CORDOBAN BROWN	1-3/4"	3'-0"	7'-0"	SCHLAGE MB15 ELECTRONIC READER SYSTEMS, ADA LEVERS		DARK BRONZE	WUI	1 x 1	TBD	TBD	MULLED UNIT	103.1
103.2			C	SIMPSON SOLID CORE SLAB OR EQUAL	PAINT TBD	1-3/8"	3'-0"	7'-0"	PRMVACY		DARK BRONZE						103.2
104.1	104	SINGLE UNIT	A	SIMPSON SOLID CORE SLAB OR EQUAL	CORDOBAN BROWN	1-3/4"	3'-0"	7'-0"	SCHLAGE MB15 ELECTRONIC READER SYSTEMS, ADA LEVERS		DARK BRONZE	WUI	1 x 1	TBD	TBD	MULLED UNIT	104.1
104.2			C	SIMPSON SOLID CORE SLAB OR EQUAL	PAINT TBD	1-3/8"	3'-0"	7'-0"	PRMVACY		DARK BRONZE						104.2
105.1	105	SINGLE UNIT	B	SIMPSON SOLID CORE SLAB OR EQUAL	CORDOBAN BROWN	1-3/4"	3'-0"	7'-0"	SCHLAGE MB15 ELECTRONIC READER SYSTEMS, ADA LEVERS		DARK BRONZE	WUI	1 x 1	TBD	TBD	MULLED UNIT	105.1
105.2			C	SIMPSON SOLID CORE SLAB OR EQUAL	PAINT TBD	1-3/8"	3'-0"	7'-0"	PRMVACY		DARK BRONZE						105.2
106.1	106	SINGLE UNIT	A	SIMPSON SOLID CORE SLAB OR EQUAL	CORDOBAN BROWN	1-3/4"	3'-0"	7'-0"	SCHLAGE MB15 ELECTRONIC READER SYSTEMS, ADA LEVERS		DARK BRONZE	WUI	1 x 1	TBD	TBD	MULLED UNIT	106.1
106.2			C	SIMPSON SOLID CORE SLAB OR EQUAL	PAINT TBD	1-3/8"	3'-0"	7'-0"	PRMVACY		DARK BRONZE						106.2
107.1	107																



	ROOM		TYPE	MFR	FINISH	THICKNESS FRAME	NOMINAL WIDTH VERIFY RO	NOMINAL HT VERIFY RO	NOMINAL SILL HT VERIFY RO	NOMINAL HEAD HT VERIFY RO	GLASS TYPE	DIVIDED LITE PATTERN	U-VALUE	SHGC	REMARKS	WINDOW TAG	
TAG	#	NAME															
2.1	2	GATHERING SPACE	B	PELLA IMPERVA FIBER GLASS OR EQUAL	DARK BRONZE	2"	1'-10"	7'-0"		7'-0"	WUI, TG	NONE	TBD	TBD	STACKED/MULLED UNIT	2.1	
2.2			D	PELLA IMPERVA FIBER GLASS OR EQUAL	DARK BRONZE	2"	4'-0"	4'-0"		3'-6"	7'-6"	WUI, TG	2 x 2	TBD	TBD		2.2
2.3			D	PELLA IMPERVA FIBER GLASS OR EQUAL	DARK BRONZE	2"	4'-0"	4'-0"		3'-6"	7'-6"	WUI, TG	2 x 2	TBD	TBD		2.3
2.4			D	PELLA IMPERVA FIBER GLASS OR EQUAL	DARK BRONZE	2"	4'-0"	4'-0"		3'-6"	7'-6"	WUI, TG	2 x 2	TBD	TBD		2.4
2.5			D	PELLA IMPERVA FIBER GLASS OR EQUAL	DARK BRONZE	2"	4'-0"	4'-0"		3'-6"	7'-6"	WUI, TG	2 x 2	TBD	TBD		2.5
4.1	4	RESTROOM	C	PELLA IMPERVA FIBER GLASS OR EQUAL	DARK BRONZE	2"	2'-0"	2'-0"		5'-0"	7'-0"	WUI, TG	NONE	TBD	TBD		4.1
5.1			5	HALL	A	PELLA IMPERVA FIBER GLASS OR EQUAL	DARK BRONZE	2"	1'-10"	7'-0"		7'-0"	WUI, TG	NONE	TBD	TBD	STACKED/MULLED UNIT
6.1	6	CHECK IN OFFICE	B	PELLA IMPERVA FIBER GLASS OR EQUAL	DARK BRONZE	2"	2'-0"	7'-0"		7'-0"	WUI, TG	NONE	TBD	TBD	STACKED/MULLED UNIT	6.1	
6.2			E	FIXED GLAZING SET IN HOLLOW METAL FRAME	DARK BRONZE	2"	5'-0"	3'-0"		4'-0"	7'-0"	WUI, TG	NONE	N/A	N/A	INTERIOR WINDOW	6.2
7.1	7	SECURITY OFFICE	E	FIXED GLAZING SET IN HOLLOW METAL FRAME	DARK BRONZE	2"	5'-0"	3'-0"		4'-0"	7'-0"	WUI, TG	NONE	N/A	N/A	INTERIOR WINDOW	7.1
7.2			D	PELLA IMPERVA FIBER GLASS OR EQUAL	DARK BRONZE	2"	4'-0"	4'-0"		3'-6"	7'-6"	WUI, TG	2 x 2	TBD	TBD		7.2
8.1			8	OFFICE SUPPORT	D	PELLA IMPERVA FIBER GLASS OR EQUAL	DARK BRONZE	2"	4'-0"	4'-0"		3'-6"	7'-6"	WUI, TG	2 x 2	TBD	TBD
8.2	D	PELLA IMPERVA FIBER GLASS OR EQUAL			DARK BRONZE	2"	4'-0"	4'-0"		3'-6"	7'-6"	WUI, TG	2 x 2	TBD	TBD		8.2
11.1	11	MECHANICAL	D	PELLA IMPERVA FIBER GLASS OR EQUAL	DARK BRONZE	2"	4'-0"	4'-0"		3'-6"	7'-6"	WUI, TG	2 x 2	TBD	TBD		11.1
101.1			101	SINGLE UNIT	B	PELLA IMPERVA FIBER GLASS OR EQUAL	DARK BRONZE	2"	1'-10"	7'-0"		7'-0"	WUI, TG	NONE	TBD	TBD	STACKED/MULLED UNIT
101.2			C	PELLA IMPERVA FIBER GLASS OR EQUAL	DARK BRONZE	2"	3'-6"	4'-0"		3'-0"	7'-0"	WUI, TG	NONE	TBD	TBD		101.2
102.1	102	SINGLE UNIT	A	PELLA IMPERVA FIBER GLASS OR EQUAL	DARK BRONZE	2"	1'-10"	7'-0"		7'-0"	WUI, TG	NONE	TBD	TBD	STACKED/MULLED UNIT	102.1	
102.2			C	PELLA IMPERVA FIBER GLASS OR EQUAL	DARK BRONZE	2"	3'-6"	4'-0"		3'-0"	7'-0"	WUI, TG	NONE	TBD	TBD		102.2
103.1	103	SINGLE UNIT	B	PELLA IMPERVA FIBER GLASS OR EQUAL	DARK BRONZE	2"	1'-10"	7'-0"		7'-0"	WUI, TG	NONE	TBD	TBD	STACKED/MULLED UNIT	103.1	
103.2			C	PELLA IMPERVA FIBER GLASS OR EQUAL	DARK BRONZE	2"	3'-6"	4'-0"		3'-0"	7'-0"	WUI, TG	NONE	TBD	TBD		103.2
104.1	104	SINGLE UNIT	A	PELLA IMPERVA FIBER GLASS OR EQUAL	DARK BRONZE	2"	1'-10"	7'-0"		7'-0"	WUI, TG	NONE	TBD	TBD	STACKED/MULLED UNIT	104.1	
104.2			C	PELLA IMPERVA FIBER GLASS OR EQUAL	DARK BRONZE	2"	3'-6"	4'-0"		3'-0"	7'-0"	WUI, TG	NONE	TBD	TBD		104.2
105.1	105	SINGLE UNIT	B	PELLA IMPERVA FIBER GLASS OR EQUAL	DARK BRONZE	2"	1'-10"	7'-0"		7'-0"	WUI, TG	NONE	TBD	TBD	STACKED/MULLED UNIT	105.1	
105.2			C	PELLA IMPERVA FIBER GLASS OR EQUAL	DARK BRONZE	2"	3'-6"	4'-0"		3'-0"	7'-0"	WUI, TG	NONE	TBD	TBD		105.2
106.1	106	SINGLE UNIT	A	PELLA IMPERVA FIBER GLASS OR EQUAL	DARK BRONZE	2"	1'-10"	7'-0"		7'-0"	WUI, TG	NONE	TBD	TBD	STACKED/MULLED UNIT	106.1	
106.2			C	PELLA IMPERVA FIBER GLASS OR EQUAL	DARK BRONZE	2"	3'-6"	4'-0"		3'-0"	7'-0"	WUI, TG	NONE	TBD	TBD		106.2
107.1	107	SINGLE UNIT	B	PELLA IMPERVA FIBER GLASS OR EQUAL	DARK BRONZE	2"	1'-10"	7'-0"		7'-0"	WUI, TG	NONE	TBD	TBD	STACKED/MULLED UNIT	107.1	
107.2			C	PELLA IMPERVA FIBER GLASS OR EQUAL	DARK BRONZE	2"	3'-6"	4'-0"		3'-0"	7'-0"	WUI, TG	NONE	TBD	TBD		107.2
108.1	108</																

Figure 1 consists of four schematic diagrams labeled A, B, C, and D, representing different experimental conditions. Each diagram shows a rectangular display area with a central fixation point (F) and two stimuli, A and B, positioned symmetrically on either side of the center. The diagrams illustrate the layout of the display, including the location of the stimuli (A and B) and the location of the fixation point (F). A legend indicates that the hatched area represents 'FRUSTED PRIVACY GLASS'.

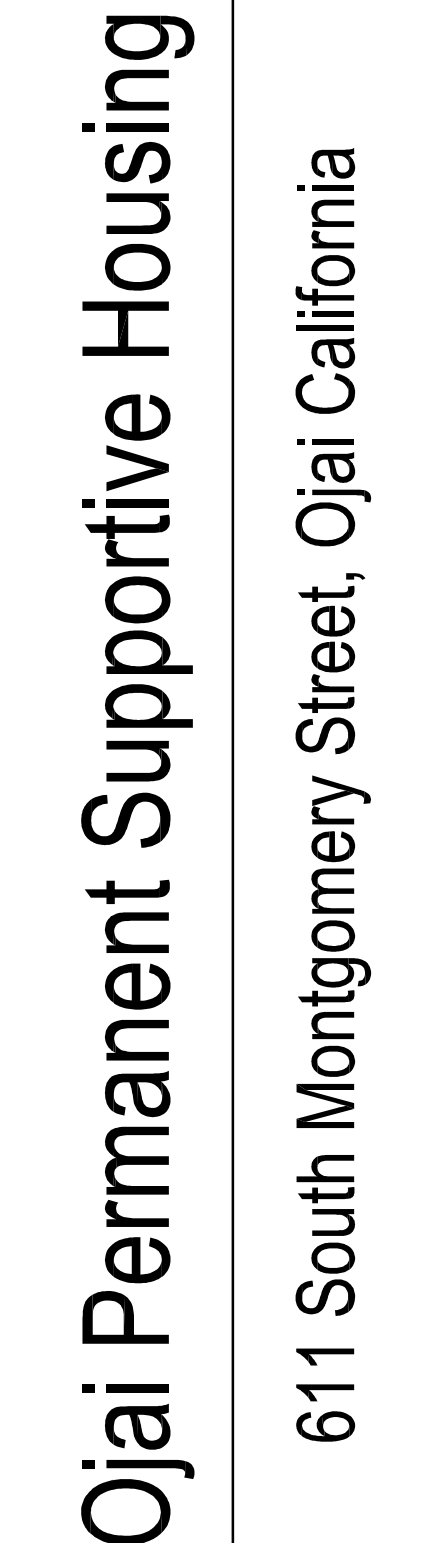

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Design  
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## A2.10



FINISH SCHEDULE

ROOM		FLOOR	CEILING	WALLS				REMARKS
#	NAME			NORTH	SOUTH	EAST	WEST	
01	ENTRY HALL	SEALED CONC	OPEN TO STRCT, VAULTED	-	-	STUCCO	STUCCO	UNCONDITIONED SPACE
02	GATHERING SPACE	SEALED CONC	OPEN TO STRCT, VAULTED	PAINTED COMPRESSED STRAW PANEL	PAINTED COMPRESSED STRAW PANEL	PAINTED COMPRESSED STRAW PANEL	PAINTED COMPRESSED STRAW PANEL	
03	PANTRY	SEALED CONC	PAINTED INTERIOR PANELS	PAINTED COMPRESSED STRAW PANEL	PAINTED COMPRESSED STRAW PANEL	PAINTED COMPRESSED STRAW PANEL	PAINTED COMPRESSED STRAW PANEL	
04	RESTROOM	SEALED CONC	PAINTED INTERIOR PANELS	FRP	FRP	FRP	FRP	
05	HALL	SEALED CONC	PAINTED INTERIOR PANELS	PAINTED COMPRESSED STRAW PANEL	PAINTED COMPRESSED STRAW PANEL	PAINTED COMPRESSED STRAW PANEL	PAINTED COMPRESSED STRAW PANEL	
06	CHECK IN OFFICE	SEALED CONC	PAINTED INTERIOR PANELS	PAINTED COMPRESSED STRAW PANEL	PAINTED COMPRESSED STRAW PANEL	PAINTED COMPRESSED STRAW PANEL	PAINTED COMPRESSED STRAW PANEL	
07	SECURITY OFFICE	SEALED CONC	PAINTED INTERIOR PANELS	PAINTED COMPRESSED STRAW PANEL	PAINTED COMPRESSED STRAW PANEL	PAINTED COMPRESSED STRAW PANEL	PAINTED COMPRESSED STRAW PANEL	
08	SUPPORT OFFICE	SEALED CONC	PAINTED INTERIOR PANELS	PAINTED COMPRESSED STRAW PANEL	PAINTED COMPRESSED STRAW PANEL	PAINTED COMPRESSED STRAW PANEL	PAINTED COMPRESSED STRAW PANEL	
09	RESTROOM	SEALED CONC	PAINTED INTERIOR PANELS	FRP	FRP	FRP	FRP	
10	LAUNDRY	SEALED CONC	PAINTED INTERIOR PANELS	PAINTED COMPRESSED STRAW PANEL	PAINTED COMPRESSED STRAW PANEL	PAINTED COMPRESSED STRAW PANEL	PAINTED COMPRESSED STRAW PANEL	
101-130	SINGLE/DOUBLE	SEALED CONC	PAINTED INTERIOR PANELS	PAINTED COMPRESSED STRAW PANEL	PAINTED COMPRESSED STRAW PANEL	PAINTED COMPRESSED STRAW PANEL	PAINTED COMPRESSED STRAW PANEL	
101R-130R	ENSUITE RESTROOMS	SEALED CONC	PAINTED INTERIOR PANELS	FRP	FRP	FRP	FRP	
134	STORAGE BUILDING	SEALED CONC	OPEN TO STRCT	PAINTED COMPRESSED STRAW PANEL	PAINTED COMPRESSED STRAW PANEL	PAINTED COMPRESSED STRAW PANEL	PAINTED COMPRESSED STRAW PANEL	UNCONDITIONED SPACE
135	TRASH ENCLOSURE	SEALED CONC	N/A	PAINTED	PAINTED	PAINTED	PAINTED	UNCONDITIONED SPACE

Drawn By: DJ

Checked By:

Job No. 2407

Revisions:

No.	Date	By

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
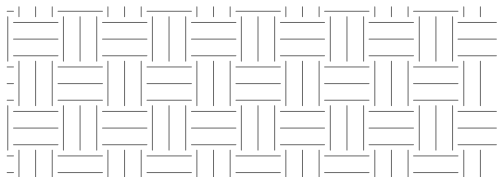

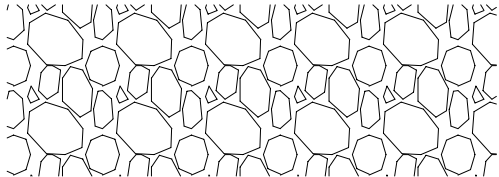
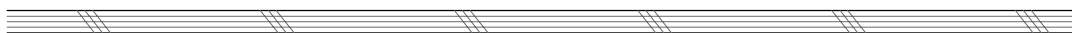
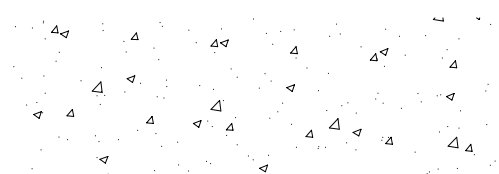

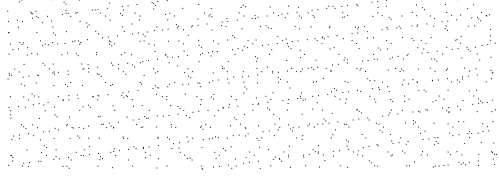

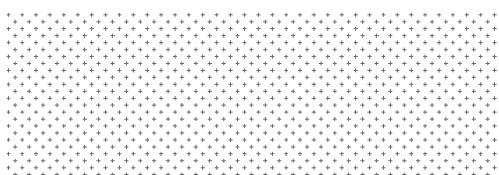

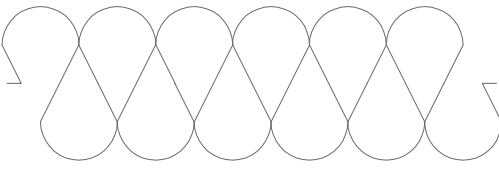
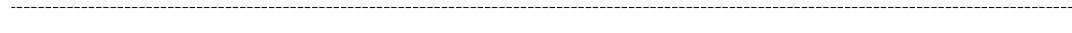
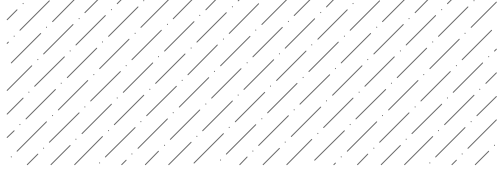
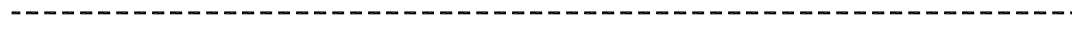
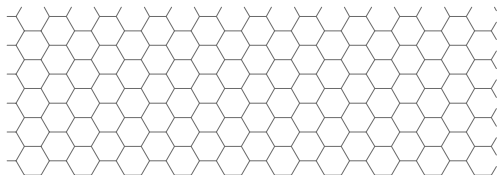

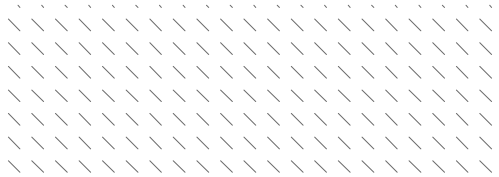

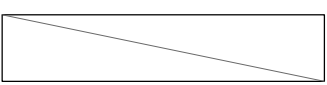
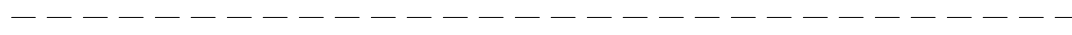
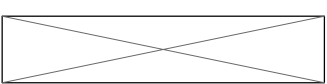



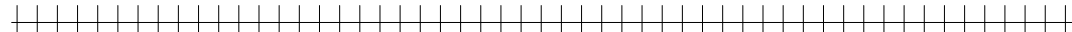



25 July 2025

Design Development

Schedules



MATERIALS LEGEND

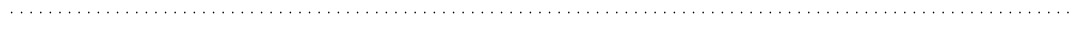	COMPRESSED STRAW PANEL		EARTH
	FIBER CEMENT PANEL		CAPPILARY BREAK
	PLYWOOD		CONCRETE
	INTERIOR WOOD PANELING		PLASTER
	GYPSUM BOARD (GWB)		FROSTED PRIVACY GLASS
	WATER AND AIR BARRIER (WAB)		INSUL 1
	POLYETHYLENE BUILDING WRAP (PBW)		INSUL 2
	LIQUID APPLIED WATER & AIR BARRIER (LWAB) / BITUMINOUS DAMPRPOOFING (BDP)		INSUL 3
	SELF ADHERED FLASHING (SAF)		FIBERGLASS
	THERMOPLASTIC ROOFING MEMBRANE (TMR)		WOOD FRAMING / SHIM
	VAPOR RETARDER (VR)		WOOD FRAMING / DIMENSIONAL LUMBER
	WOOD FRAMING SILL SEALER		
	ACOUSTIC CEILING TILE (ACT)		
	CARPET (CPT)		
	MORTAR NET		
	DRAINAGE MAT (DM)		
	BENTONITE WATERPROOFING (BWP-1)		
	GEOTEXTILE FABRIC		

ASSEMBLY KEYNOTE LEGEND

- GENERAL NOTES:
- SEE A0.1 FOR ABBREVIATIONS.
  - SEE OUTLINE SPECIFICATIONS FOR ADDITIONAL INFORMATION.
  - ALL MATERIALS AND SYSTEMS TO BE INSTALLED PER MANUFACTURER'S RECOMMENDATIONS.
  - GENERAL CONTRACTOR TO SEAL ALL PENETRATIONS AND PROVIDE WEATHER TIGHT BUILDING ENVELOPE.
  - SEAL PERIMETER OF ACOUSTIC WALLS WITH NON-HARDENING MASTIC.
  - SEAL ALL MECHANICAL AND ELECTRICAL PENETRATIONS WITH NON-HARDENING MASTIC.
  - STAGGER MECHANICAL AND ELECTRICAL PENETRATIONS @ ACOUSTIC WALL @ MIN. (2) STUD BAYS.
  - SEE INTERIOR ELEVATIONS AND ROOM FINISH SCHEDULE FOR ADDL WALL FINISHES.

0: WALLS

REF	ASSEMBLY DESCRIPTION
01	EXTERIOR WALL: STUCCO FINISH (LA HABRA SMOOTH, SANTA BARBARA FINISH, COLOR P-6 EL DORADO COLOR) O/WATER AND AIR BARRIER, O/COMPRESSED STRAW PANELS, O/FRAMING PER STRUCTURAL WITH INSUL 1 AT STUD CAVITY WITH PAINTED COMPRESSED STRAW PANELS AT INTERIOR FINISH SIDE. NOTE: SEE OUTLINE SPECIFICATIONS FOR WALL ASSEMBLY BID ALTERNATES.
02	TRASH ENCLOSURE WALL: STUCCO TO MATCH WALL TYPE 01 O/REINFORCED 8" CMU BLOCK WITH PAINT ON INTERIOR FACE.

10: ROOFS

REF	ASSEMBLY DESCRIPTION
10	TYPICAL CLAY TILE ROOFING O/ CLASS A ROOFING MEMBRANE ASSEMBLY O/COMPRESSED STRAW PANELS O/TRUSSES PER STRUCTURAL. NOTE: SEE OUTLINE SPECIFICATIONS FOR ROOF ASSEMBLY BID ALTERNATES.
11	GATHERING SPACE CLAY TILE ROOFING O/ CLASS A ROOFING MEMBRANE ASSEMBLY O/COMPRESSED STRAW PANELS O/2X6 PURLINS WITH 5.5" CLOSED CELL SPAY FOAM O/PAINTED COMPRESSED STRAW PANELS AT INTERIOR FINISH SIDE, O/EXPOSED FRAMING PER STRUCTURAL. NOTE: SEE OUTLINE SPECIFICATIONS FOR ROOF ASSEMBLY BID ALTERNATES.


20: FLOORS

REF	ASSEMBLY DESCRIPTION
20	HARD TROWELED CONCRETE FLOORS WITH "GLAZE AND SEAL WET LOOK GREEN" WATER-BASED LACQUER FINISH. SAW-CUT 1/8" CONTROL JOINTS, LOCATE CONTROL JOINTS UNDER PARTITION WALLS AND COORDINATE ALL LOCATIONS WITH ARCHITECT THROUGH SUBMITTAL PROCESS.

30: CEILINGS AND SOFFITS

REF	ASSEMBLY DESCRIPTION
30	PAINTED COMPRESSED STRAW PANELS O/ STRUCTURE.
31	PAINTED COMPRESSED STRAW PANELS O/ STRUCTURE WITH SOFFIT VENT.

INTERIOR WALL TYPE LEGEND

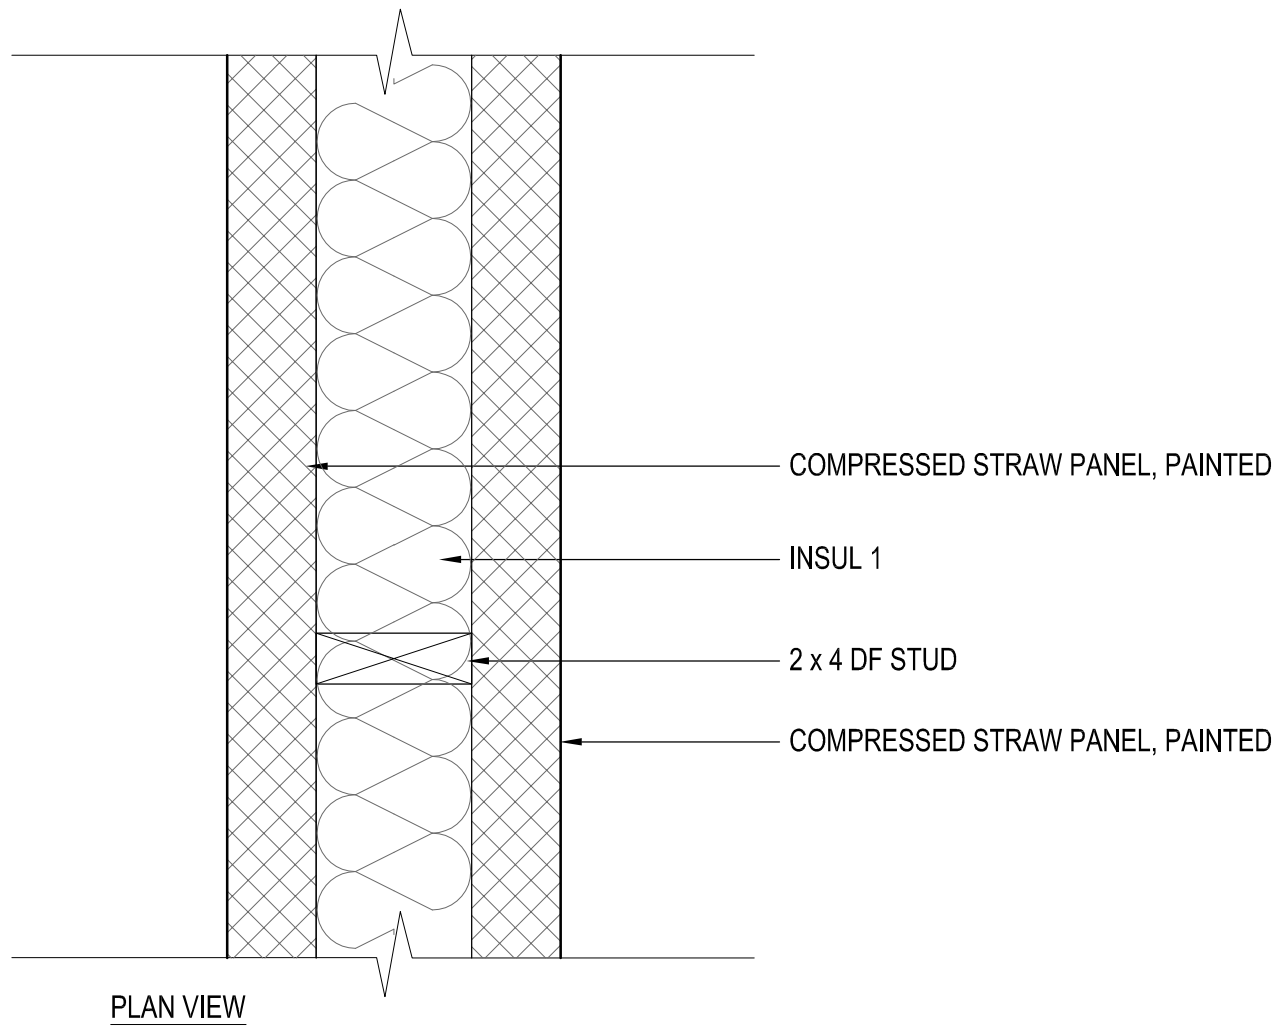

WALL TYPE A: 1 HOUR RATED ACOUSTIC PARTITION

- NOTES:
- SEAL PERIMETER OF ACOUSTIC WALLS WITH NON-HARDENING MASTIC.
  - SEAL ALL MECHANICAL AND ELECTRICAL PENETRATIONS WITH NON-HARDENING MASTIC.
  - STAGGER MECHANICAL AND ELECTRICAL PENETRATIONS AT ACOUSTIC WALL MIN (2) STUD BAYS.
  - DO NOT CONNECT STAGGERED STUDS.
  - PROVIDE INTUMESCENT SEALANT AT PANEL JOINTS PER MANUFACTURER'S REQUIREMENTS TO MAINTAIN 1-HOUR RATING.

Drawn By: DJ  
Checked By:  
Job No. 2407

Revisions:		
No.	Date	By

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25 July 2025

Design  
Development

Assembly  
Keynote Legend

A3.0



# Ojai Permanent Supportive Housing

611 South Montgomery Street, Ojai California

Drawn By: DJ  
Checked By:  
Job No. 2407  
Revisions:  
No. Date By


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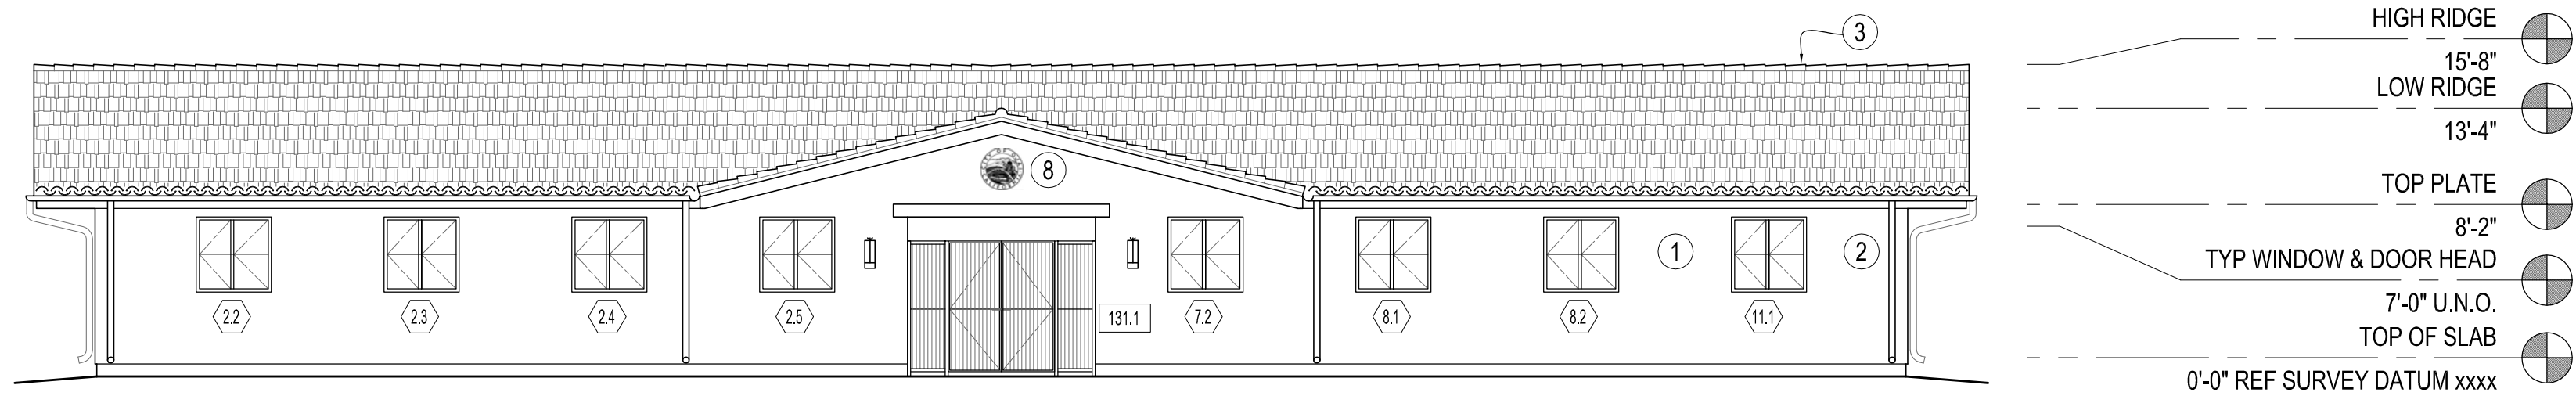
Design  
Development

Exterior  
Elevations


A3.1




4 SOUTH ELEVATION  
A3.1 1/8" = 1'-0"

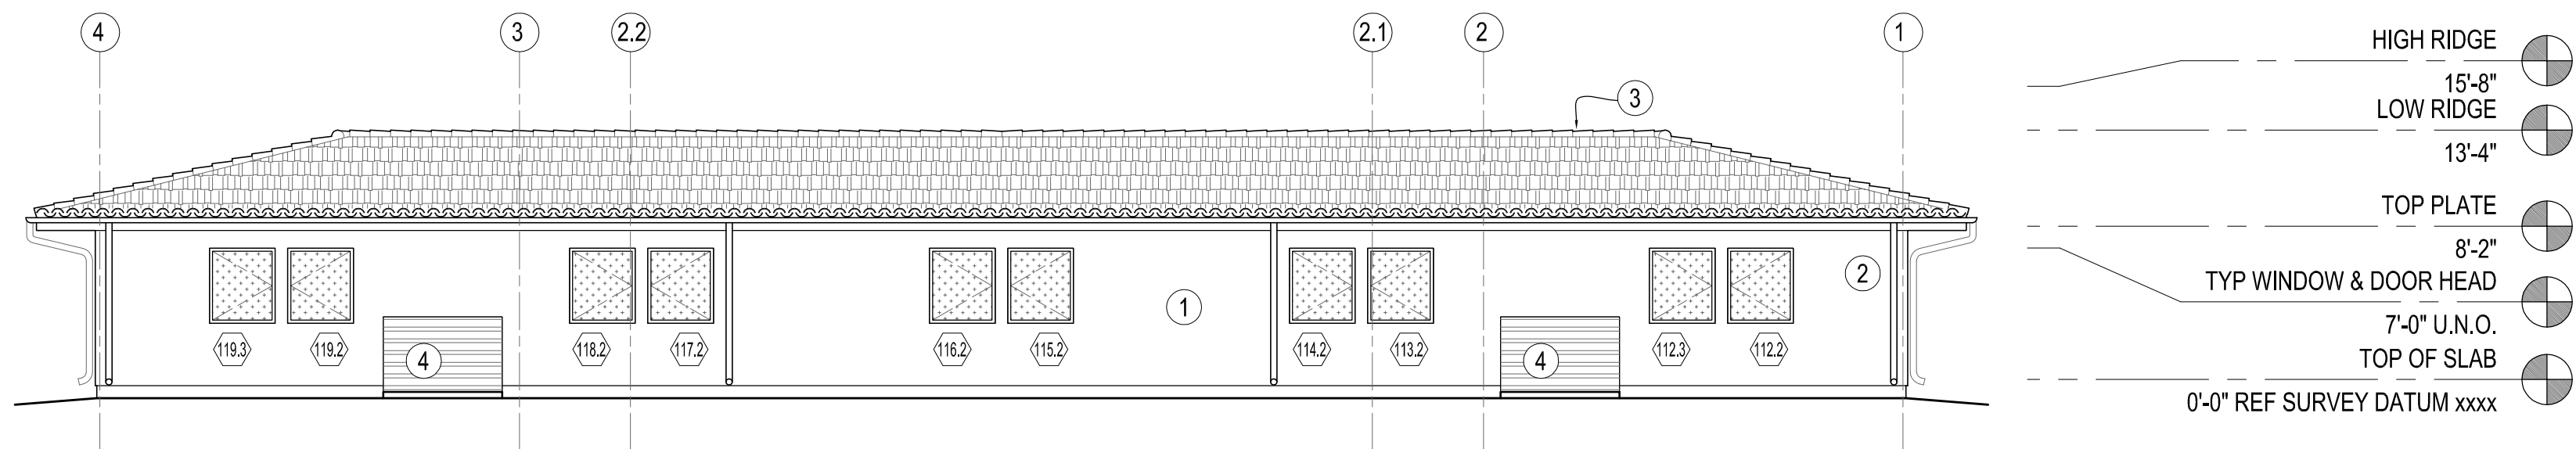

3 NORTH ELEVATION  
A3.1 1/8" = 1'-0"

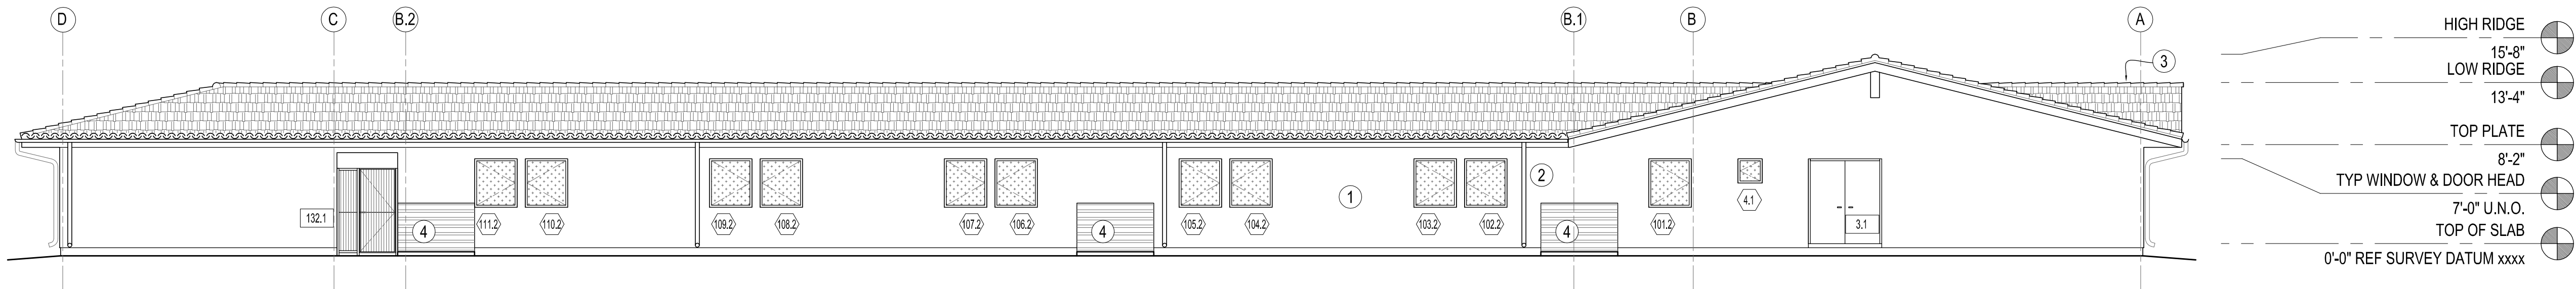

2 EAST ELEVATION  
A3.1 1/8" = 1'-0"

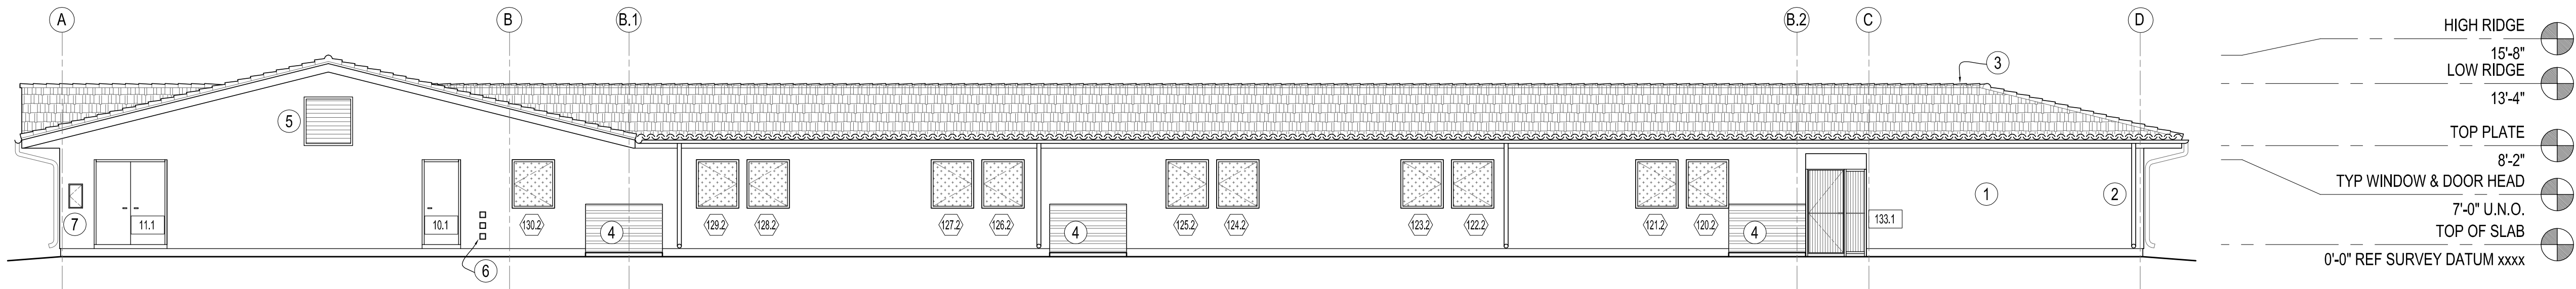

1 WEST ELEVATION  
A3.1 1/8" = 1'-0"

## ELEVATION KEY NOTES

- 1 STUCCO, SEE A3.0
- 2 GUTTER AND DOWNSPOUT
- 3 ROOFING, SEE A3.0
- 4 NON-COMBUSTIBLE HVAC SCREEN
- 5 GABLE VENT, SEE A2.3
- 6 DRYER VENT
- 7 ELECTRIC METER
- 8 ENTRY SIGN

## ELEVATION GENERAL NOTES:

1. DESIGN DEVELOPMENT DRAWINGS ARE INTENDED FOR RFP PRICING AND NOT FOR CONSTRUCTION. FOLLOWING CONTRACTOR SELECTION PROCESS, DRAWINGS AND SPECIFICATIONS WILL BE PREPARED FOR PERMITTING AND CONSTRUCTION.
2. BUILDINGS TO COMPLY WITH CALIFORNIA BUILDING CODE CHAPTER 7A MATERIALS AND CONSTRUCTION METHODS FOR WILDFIRE EXPOSURE.
3. SEE A3.0 FOR ASSEMBLY KEYNOTE LEGEND.
4. HVAC UNITS AT BUILDING EXTERIOR ARE DIAGRAMMATIC AND SHOWN FOR REFERENCE ONLY, SEE MECHANICAL DRAWINGS.



611 South Montgomery Street, Ojai California


## Exterior Elevations

### A3.2



- ELEVATION GENERAL NOTES:**
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  2. BUILDINGS TO COMPLY WITH CALIFORNIA BUILDING CODE CHAPTER 7A MATERIALS AND CONSTRUCTION METHODS FOR WILDFIRE EXPOSURE.
  3. SEE A3.0 FOR ASSEMBLY KEYNOTE LEGEND.
  4. HVAC UNITS AT BUILDING EXTERIOR ARE DIAGRAMMATIC AND SHOWN FOR REFERENCE ONLY, SEE MECHANICAL DRAWINGS.




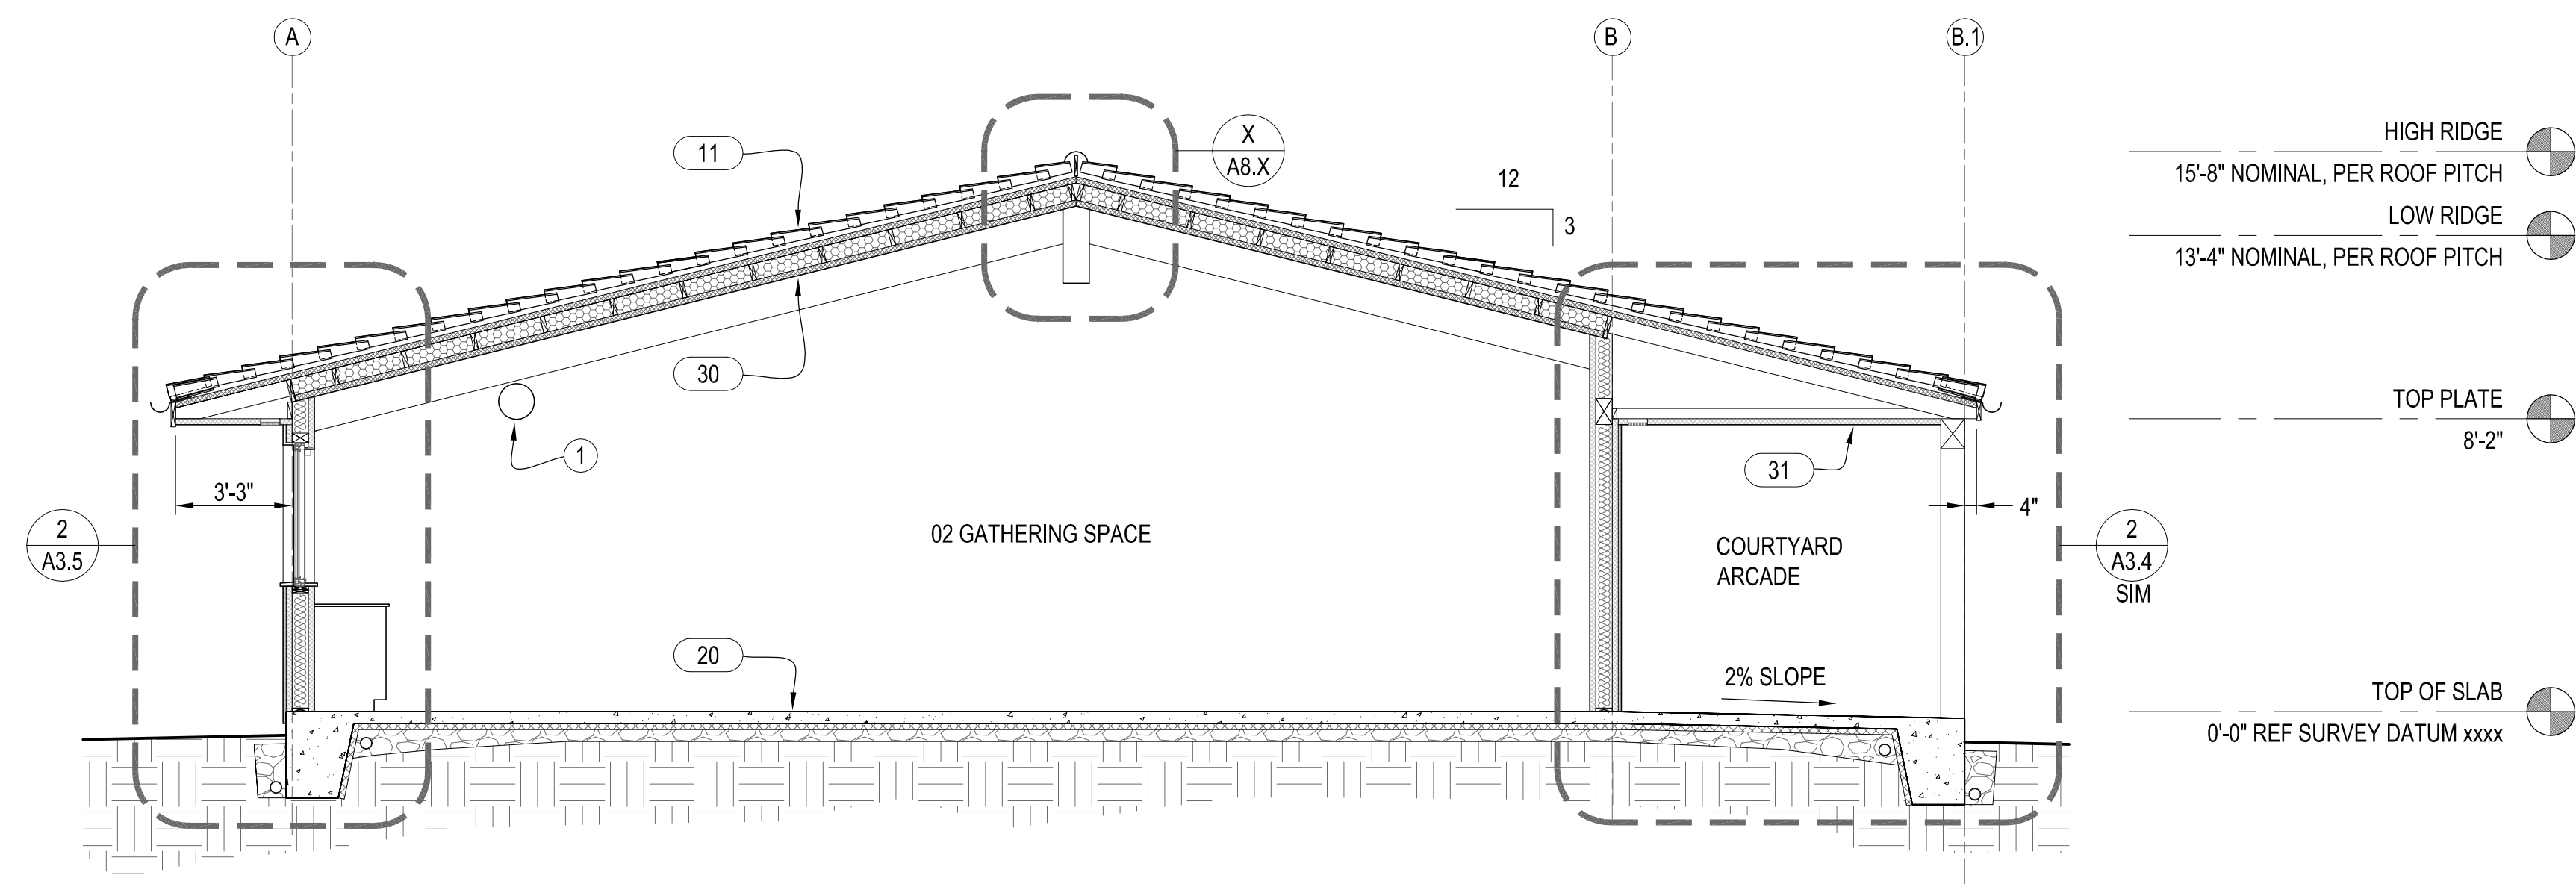


- SECTION GENERAL NOTES:
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  - BUILDINGS TO COMPLY WITH CALIFORNIA BUILDING CODE CHAPTER 7A MATERIALS AND CONSTRUCTION METHODS FOR WILDFIRE EXPOSURE.
  - GRIDLINE INDICATES FACE OF FRAMING, SEE STRUCTURAL.
  - SEE A3.0 FOR ASSEMBLY KEYNOTE LEGEND.

- SECTION KEY NOTES
- HVAC DUCT, SEE MECHANICAL DRAWINGS

4  
A3.3  
BUILDING SECTION  
1/4" = 1'-0"

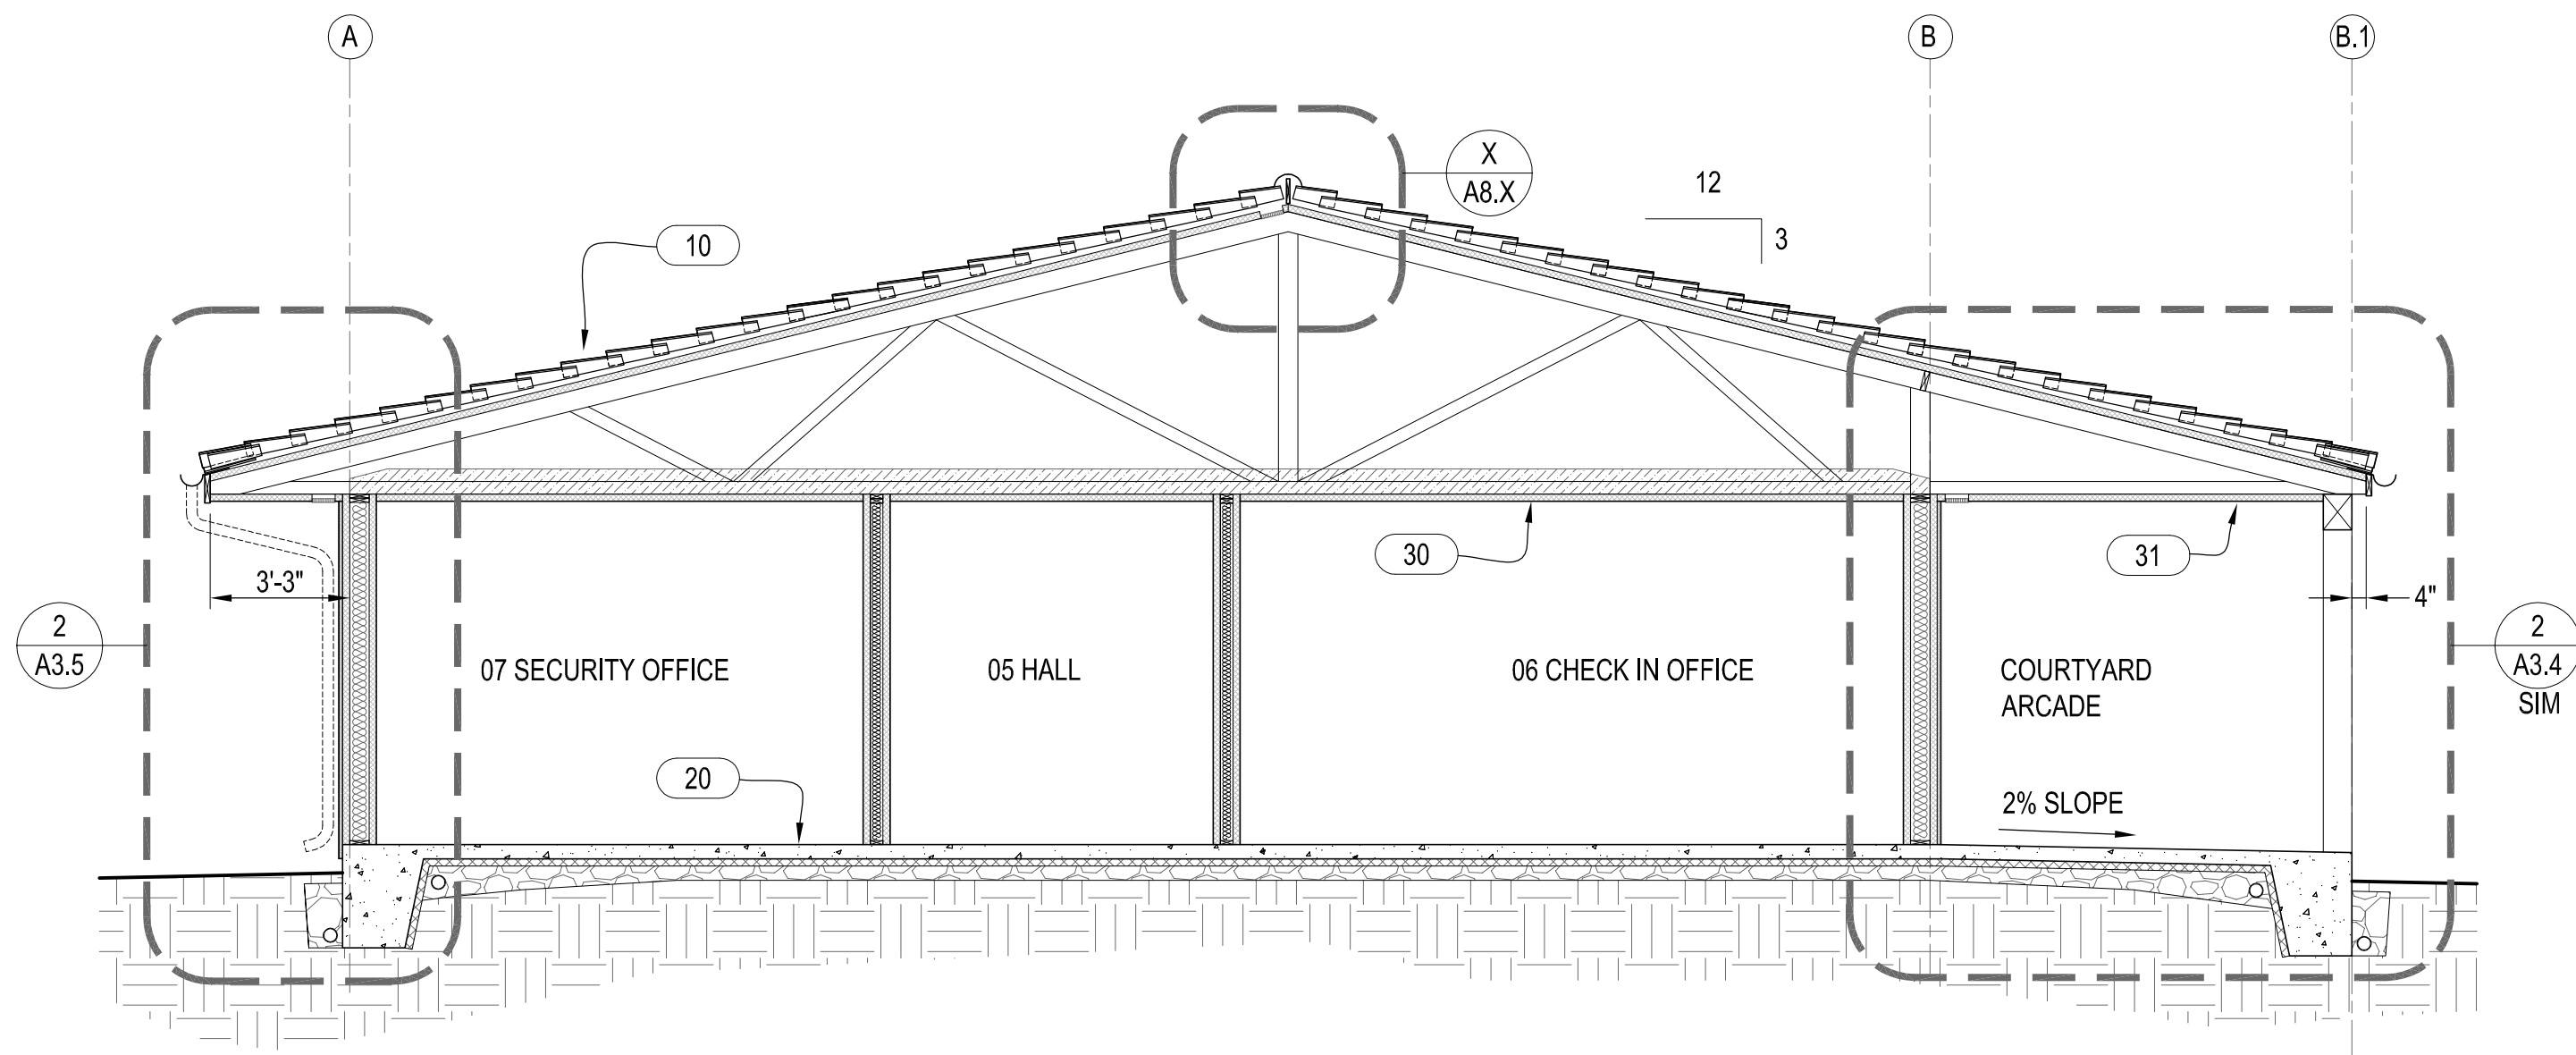

2  
A3.3  
BUILDING SECTION  
1/4" = 1'-0"

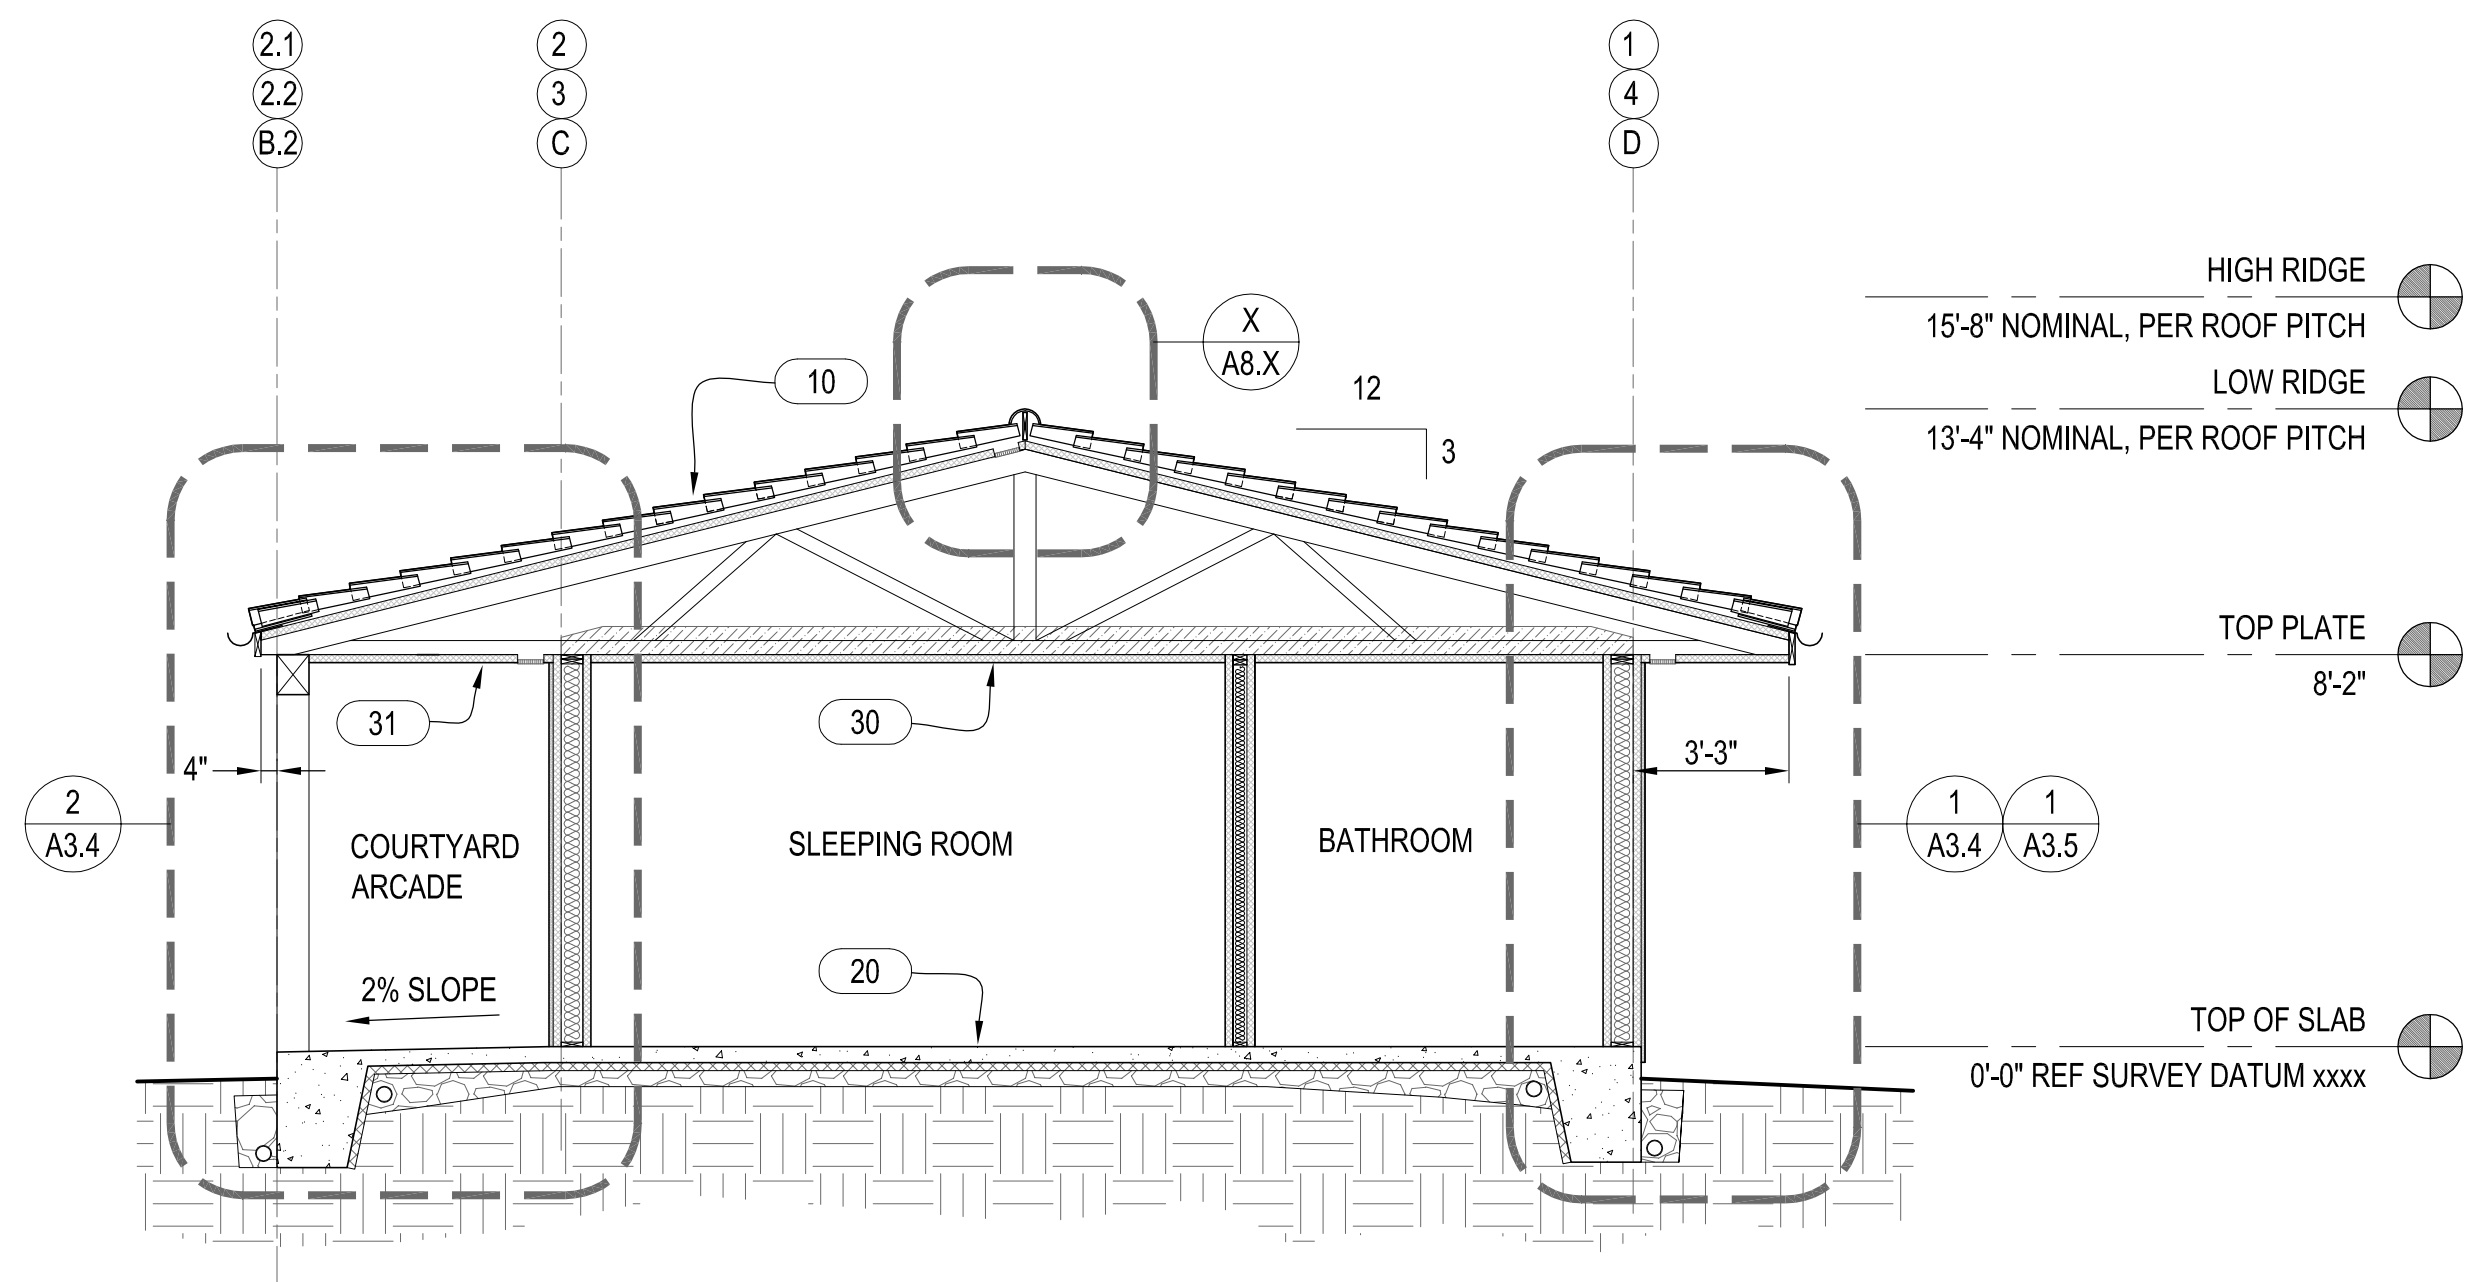

1  
A3.3  
TYPICAL BUILDING SECTION  
1/4" = 1'-0"

Drawn By:	DJ	
Checked By:		
Job No.	2407	
Revisions:		
No.	Date	By

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25 July 2025

Design Development



Ojai Permanent Supportive Housing

611 South Montgomery Street, Ojai California

Drawn By:	DJ	
Checked By:		
Job No.	2407	
Revisions:		
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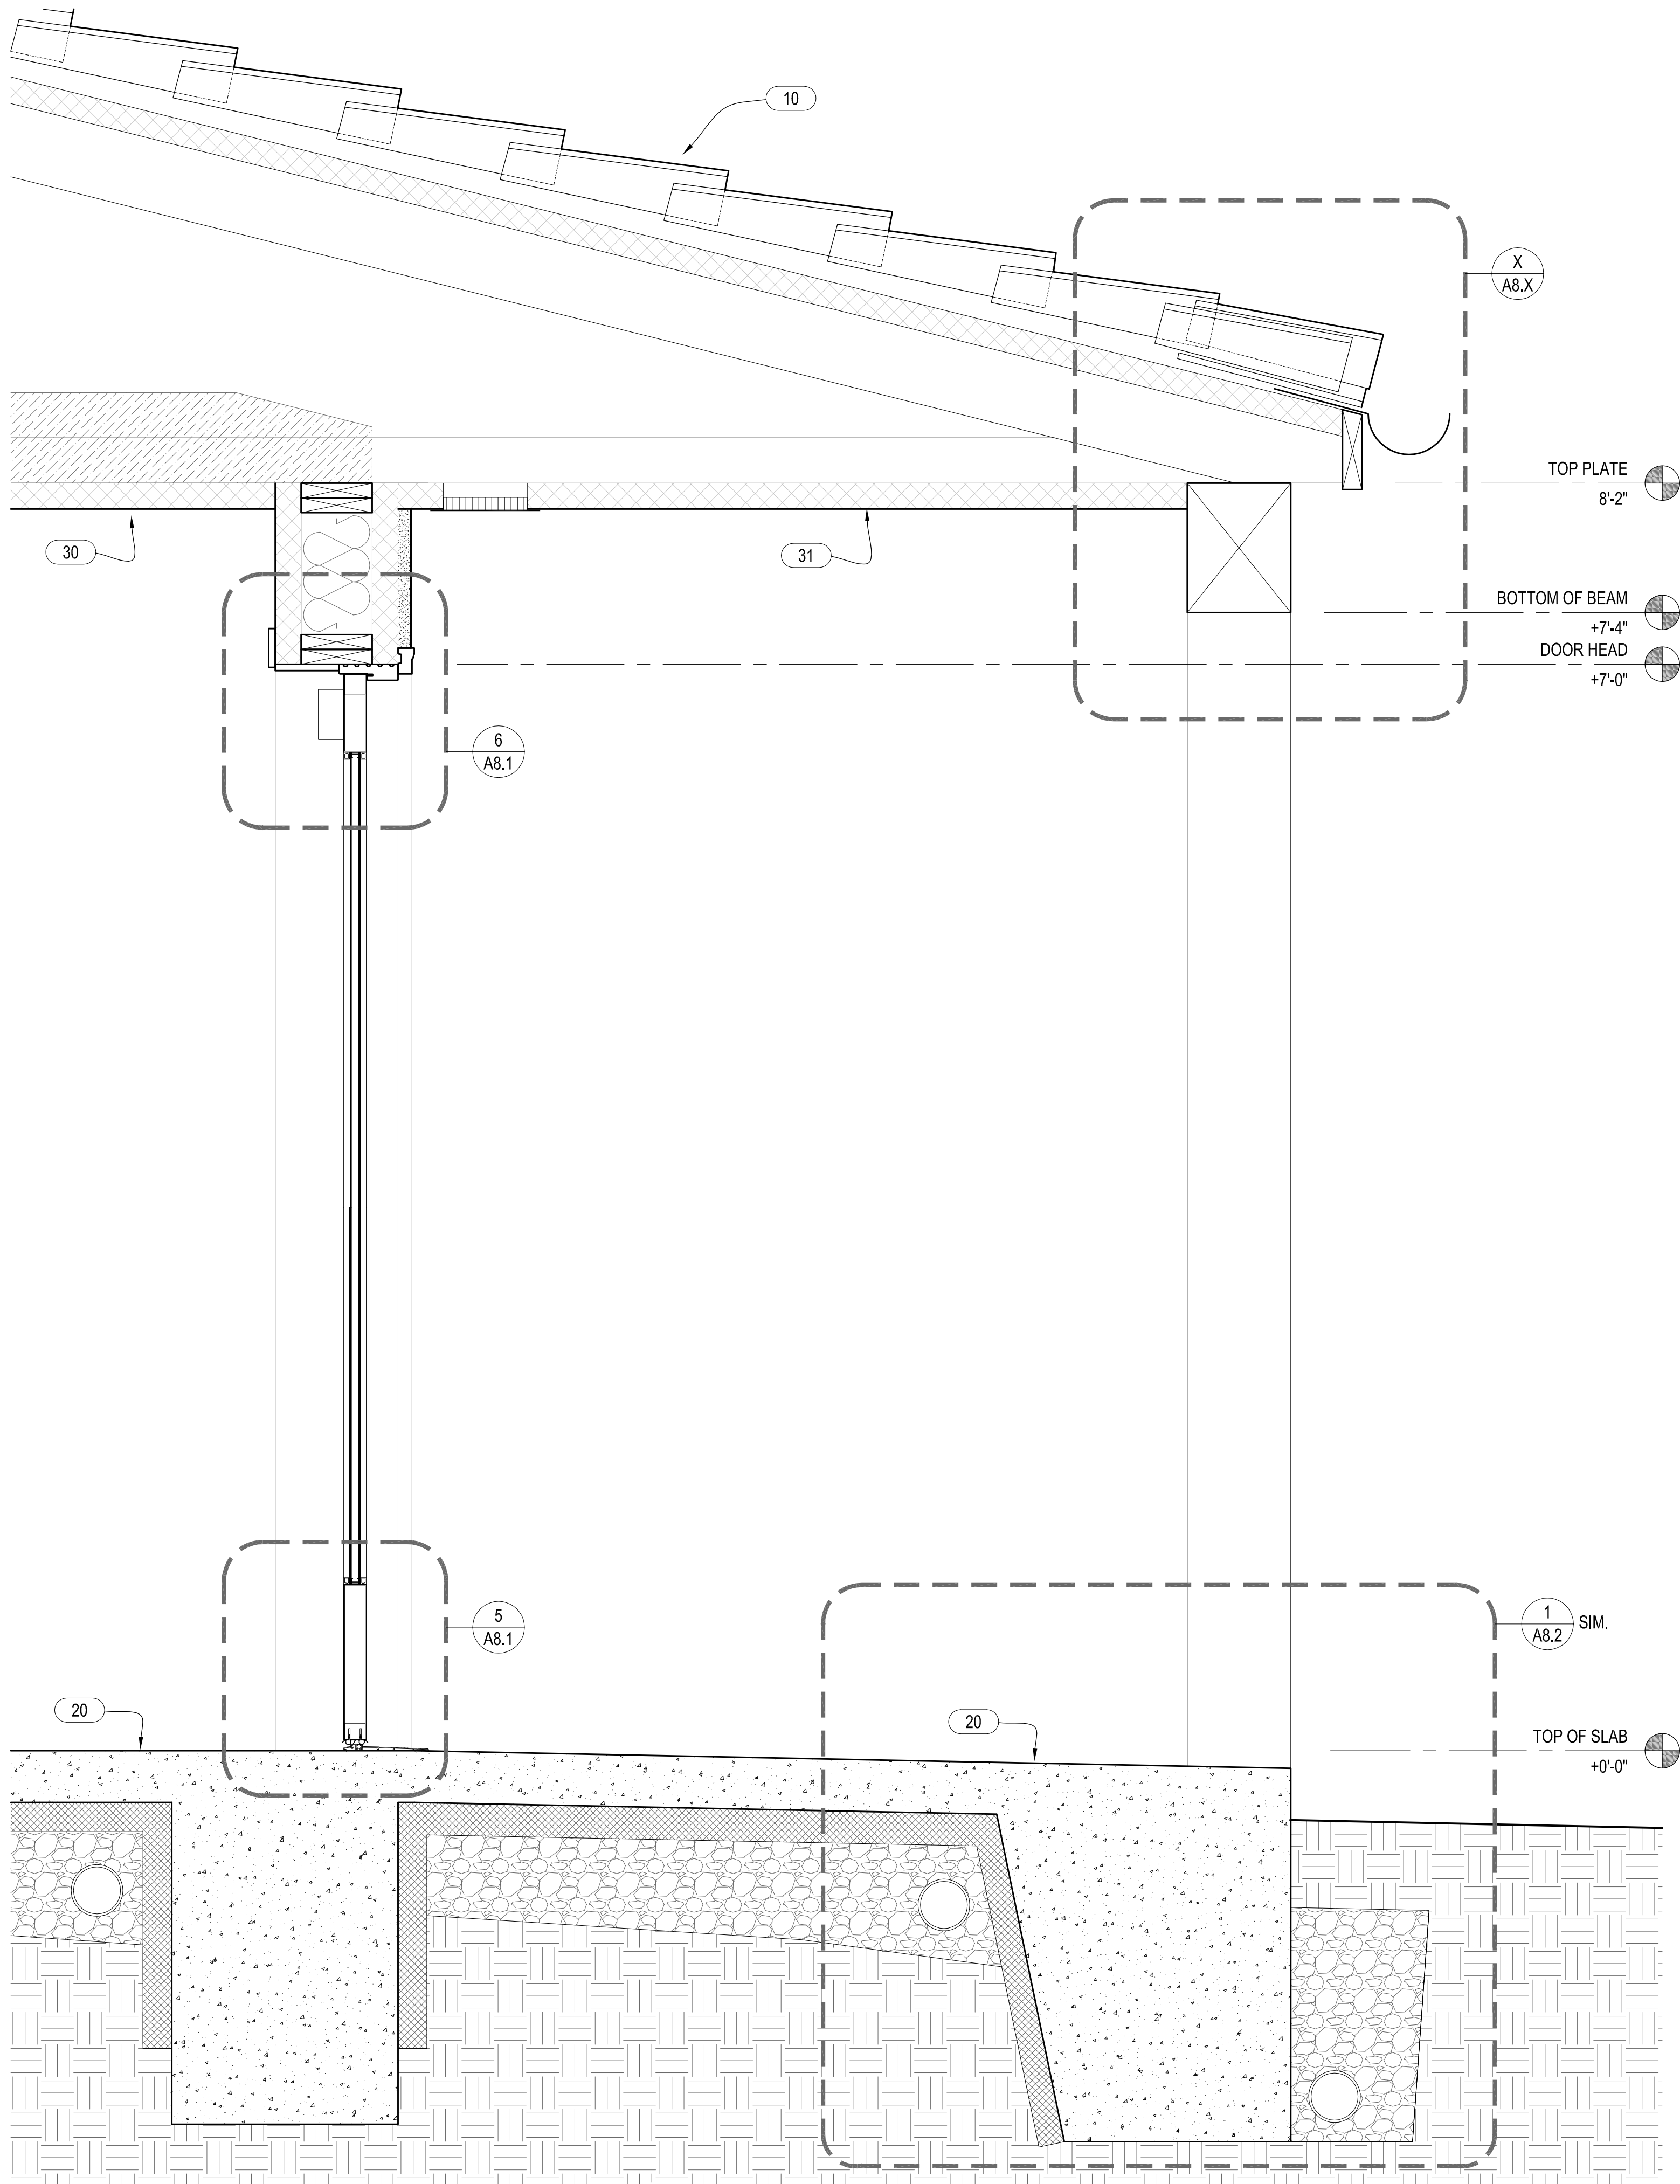
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25 July 2025

Design  
Development


Wall  
Sections

A3.4



WALL SECTION @ DOOR


1 1/2" = 1'-0"

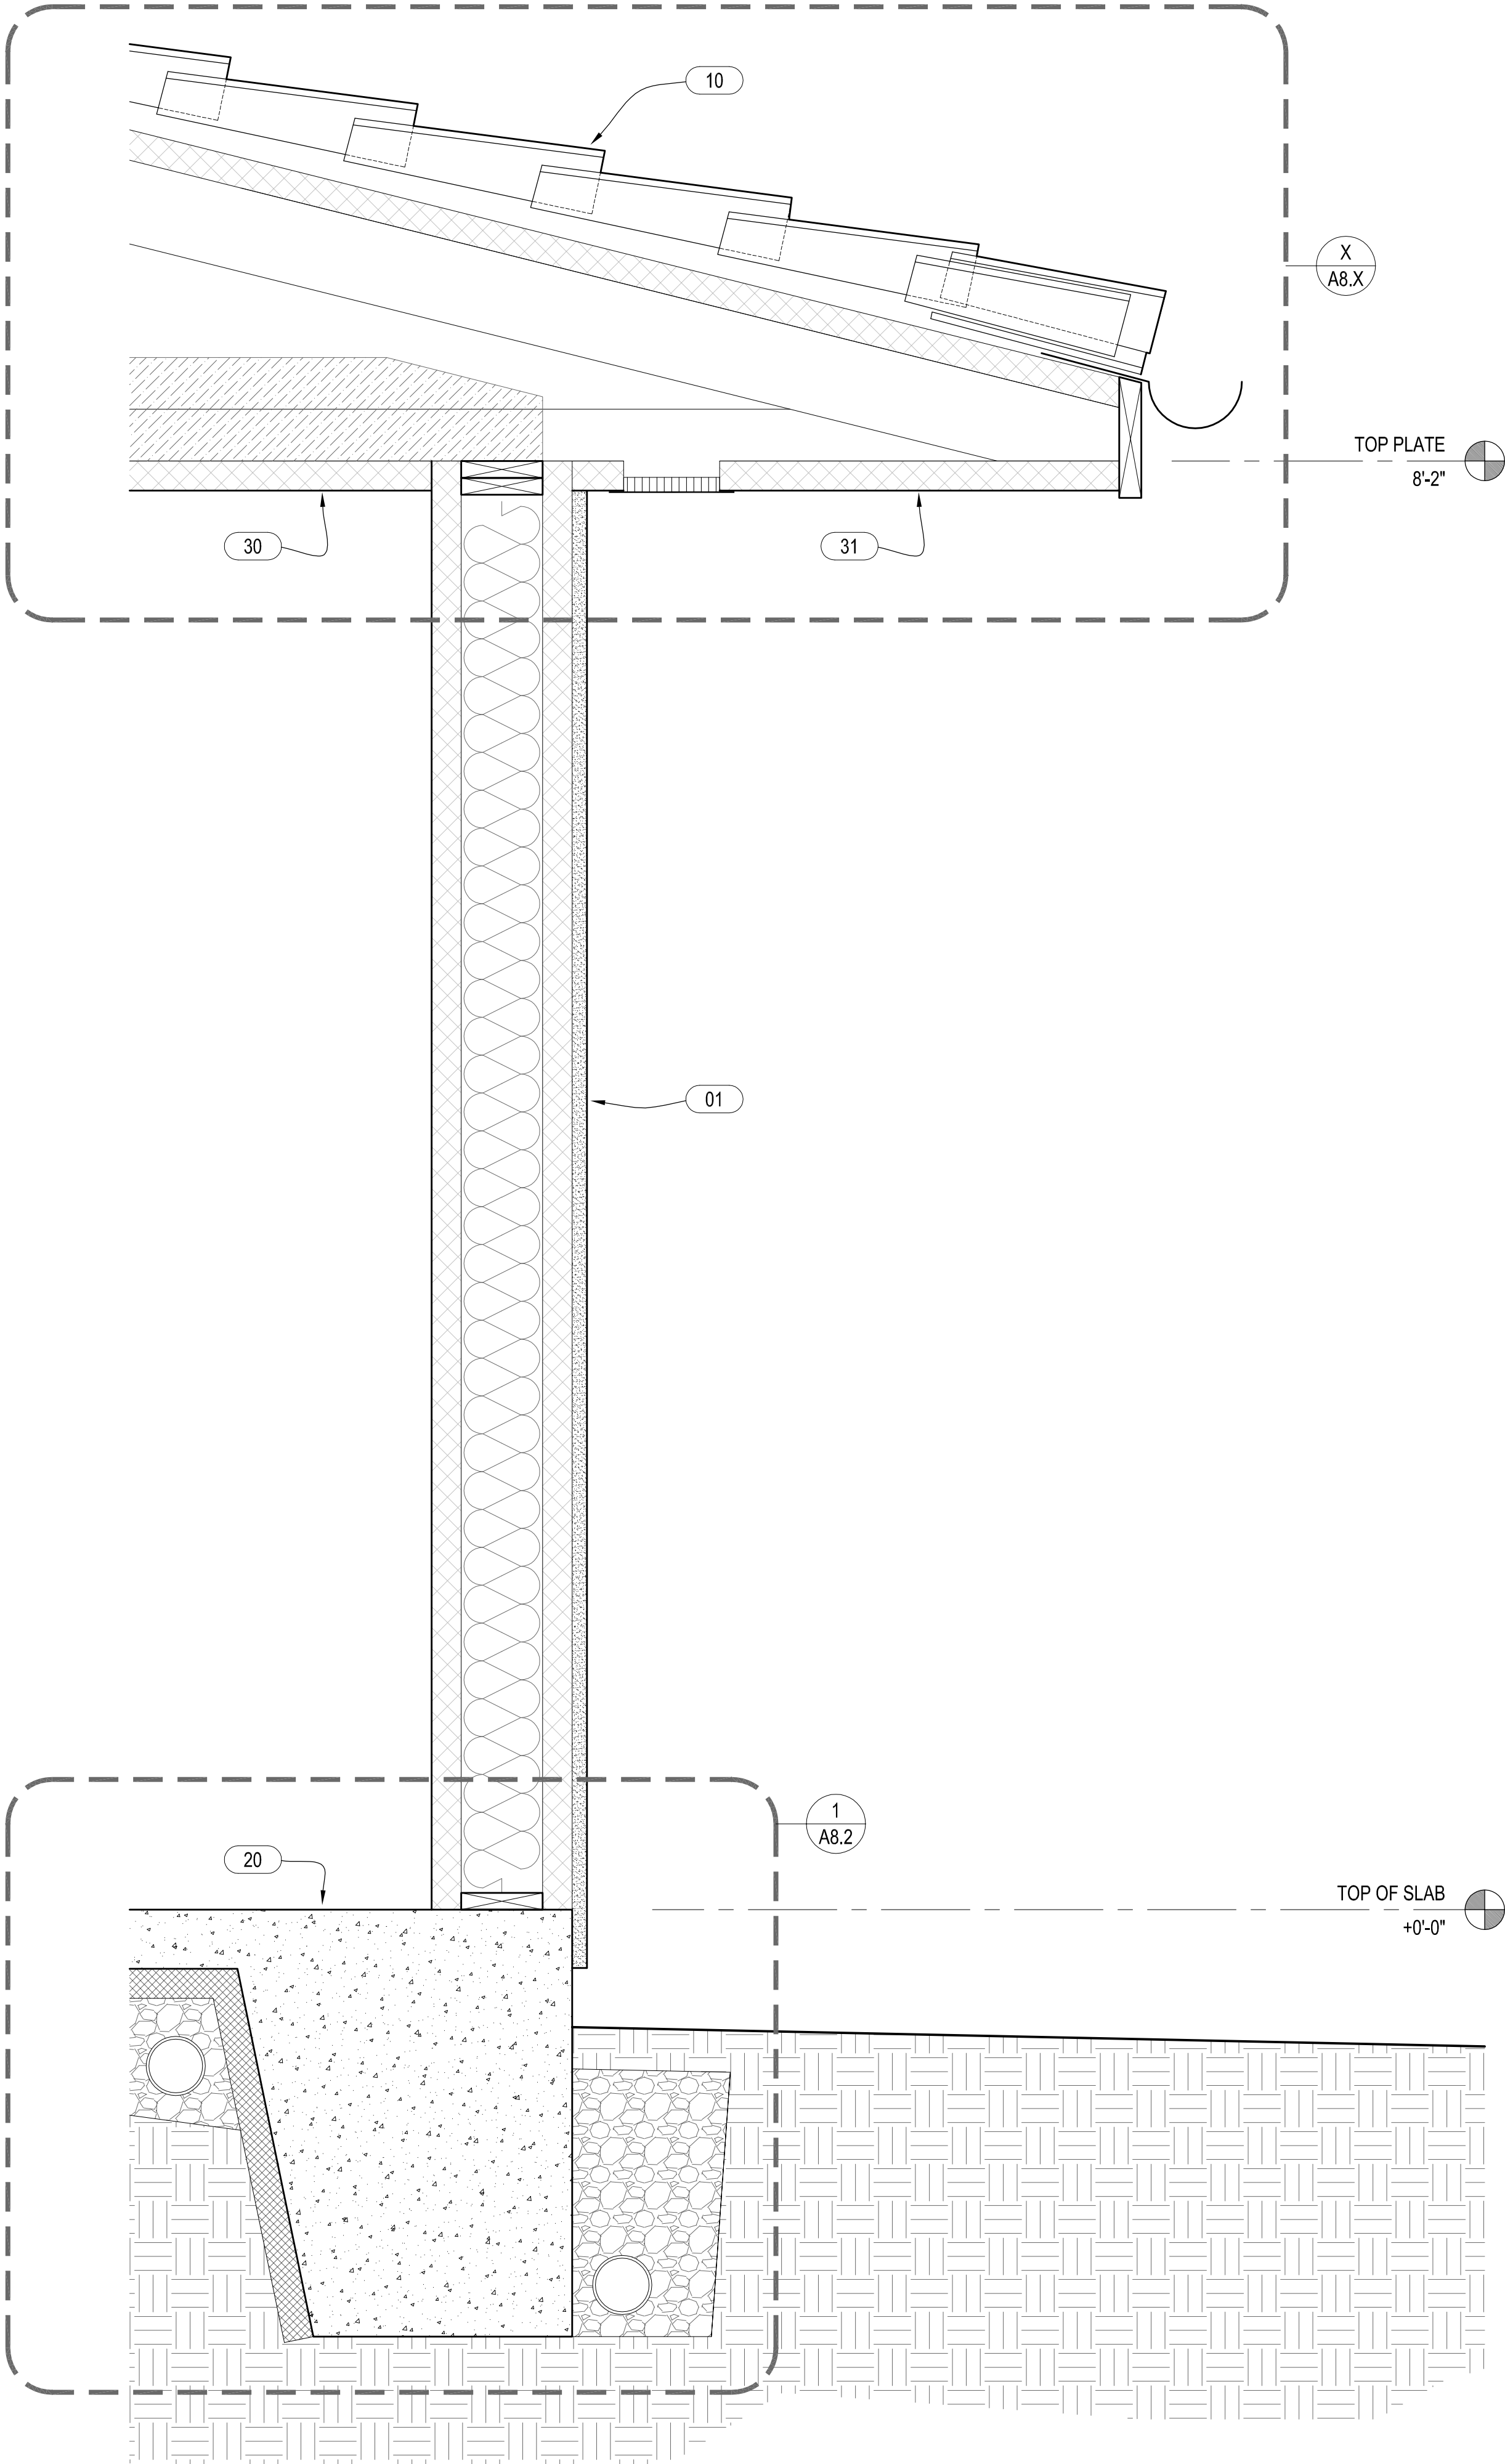

WALL SECTION - TYPICAL

1 1/2" = 1'-0"



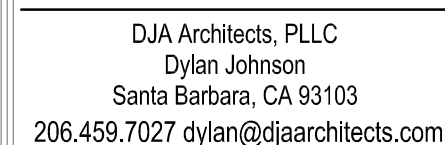

# Ojai Permanent Supportive Housing

611 South Montgomery Street, Ojai California

Drawn By: DJ  
 Checked By: \_\_\_\_\_  
 Job No. 2407  
 Revisions:  
 No. \_\_\_\_\_ Date \_\_\_\_\_ By \_\_\_\_\_  
 \_\_\_\_\_  
 \_\_\_\_\_  
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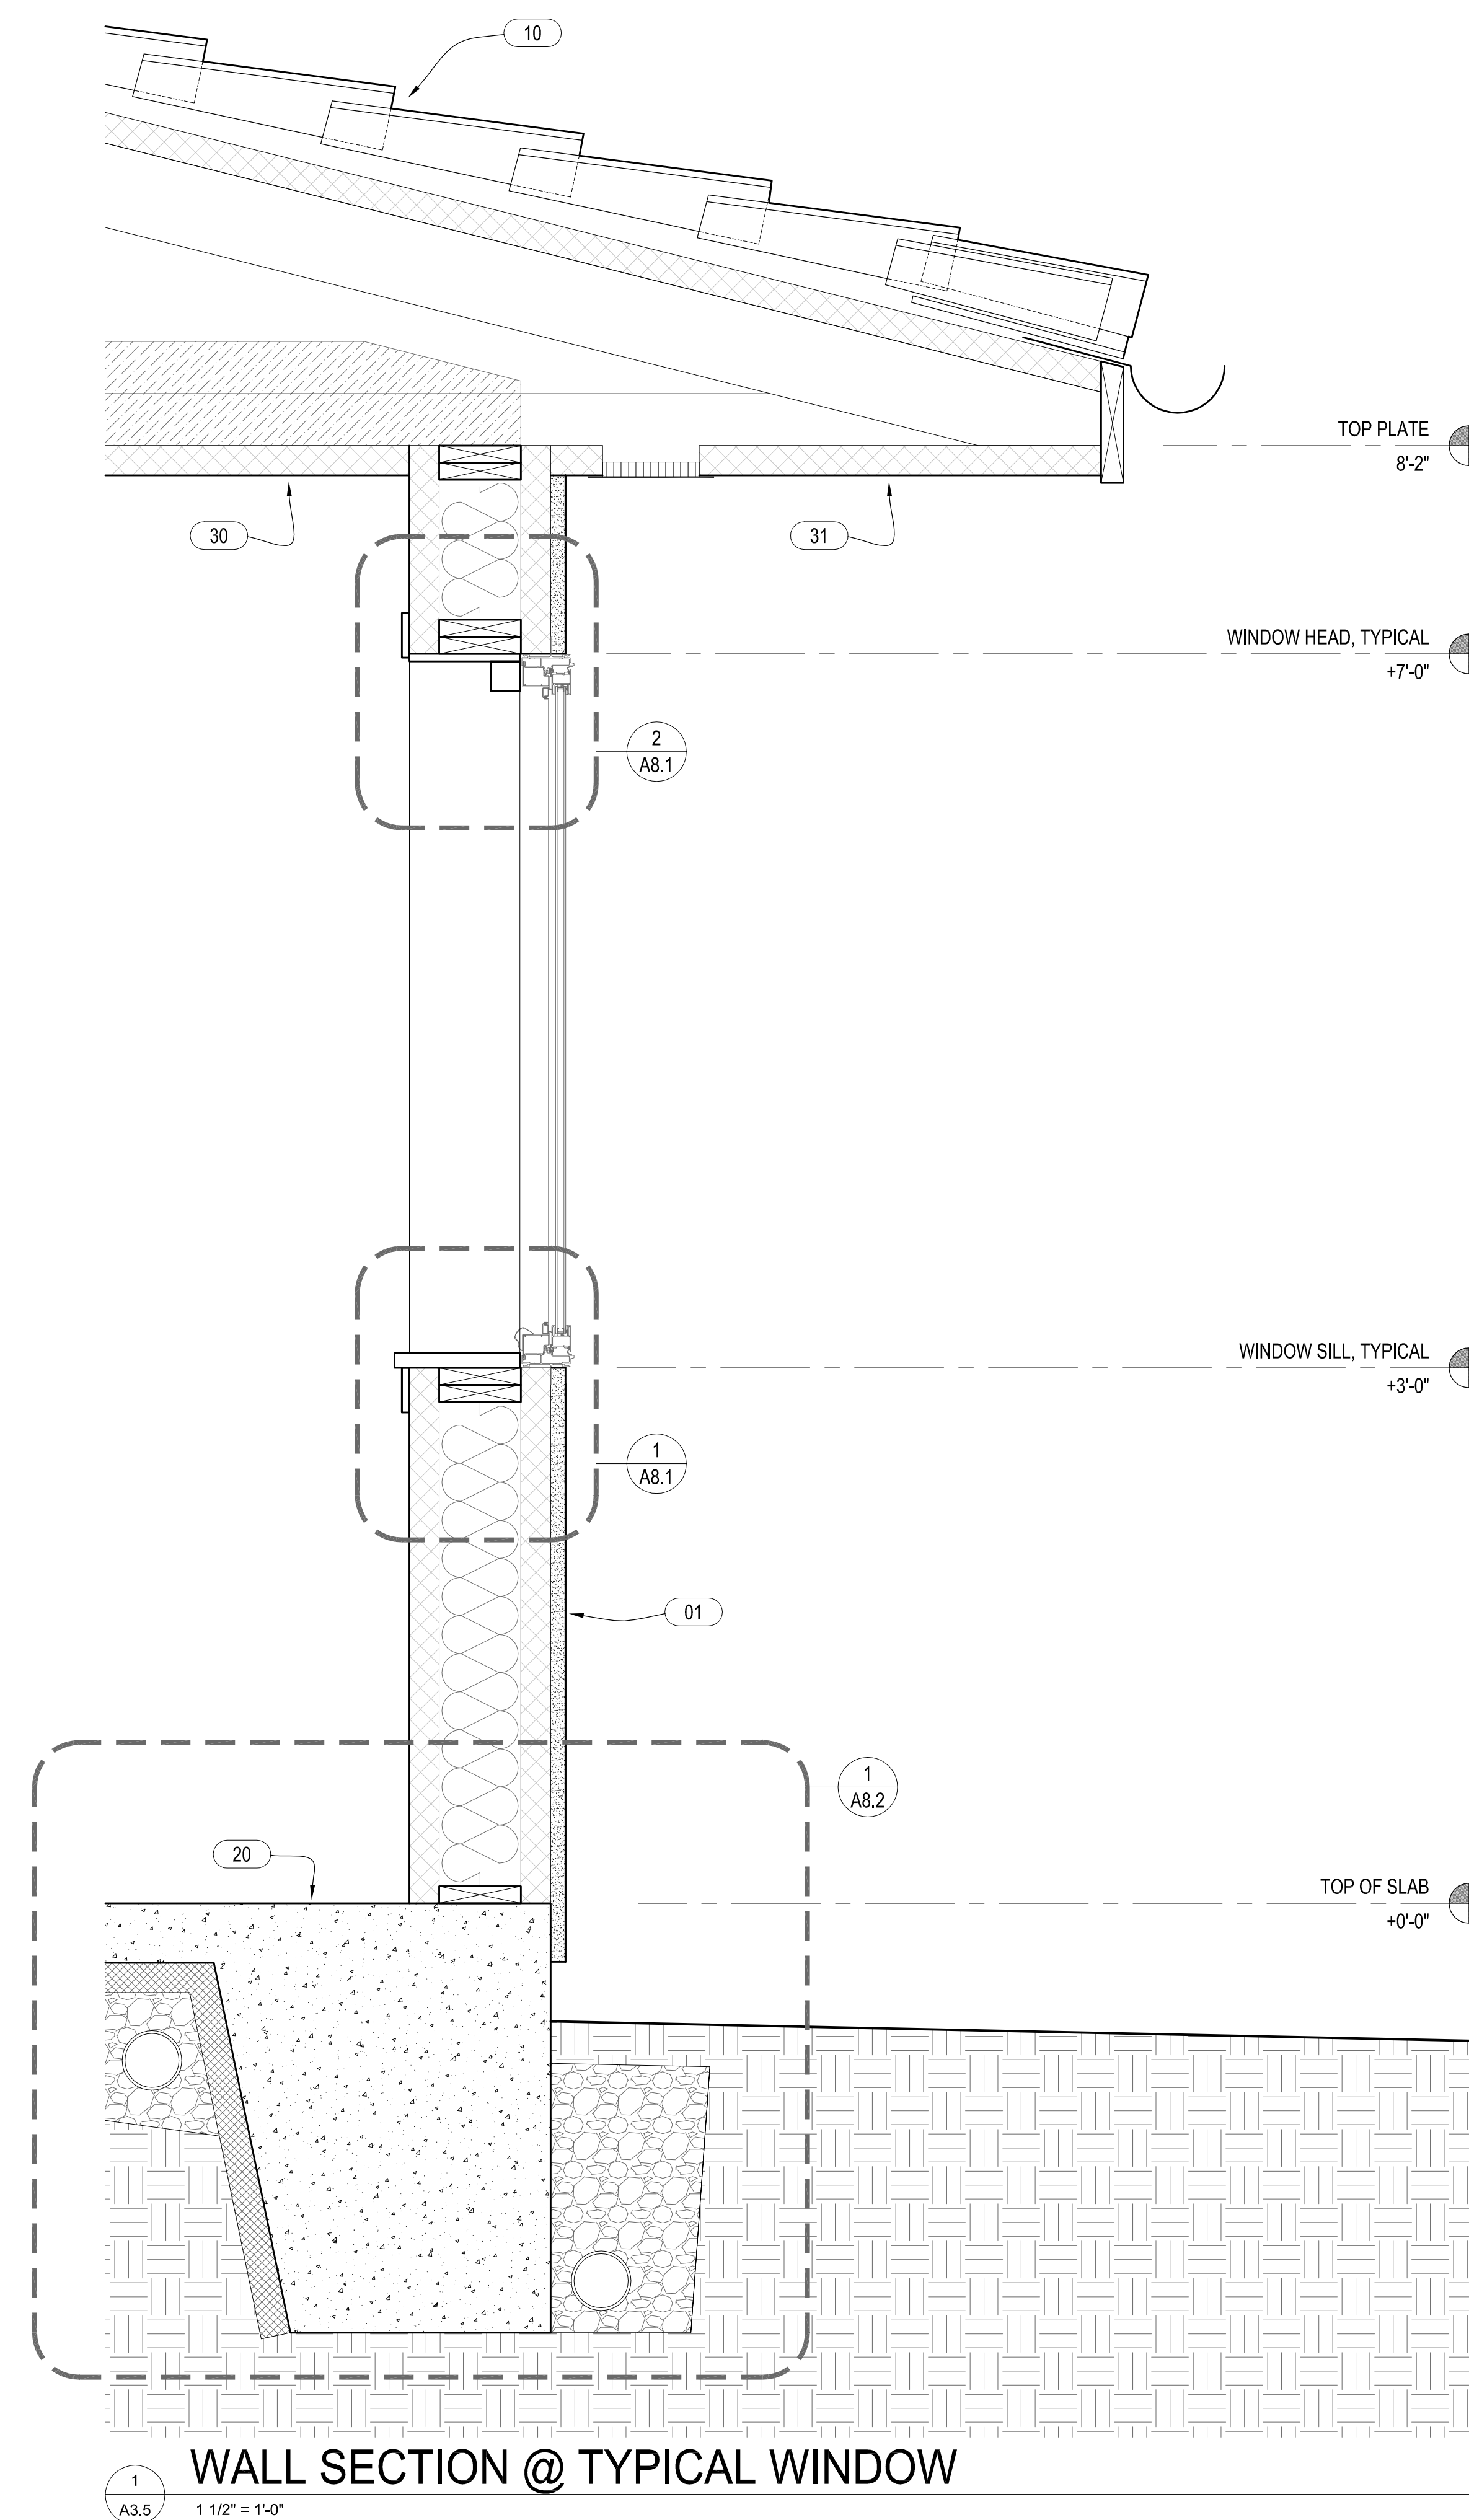
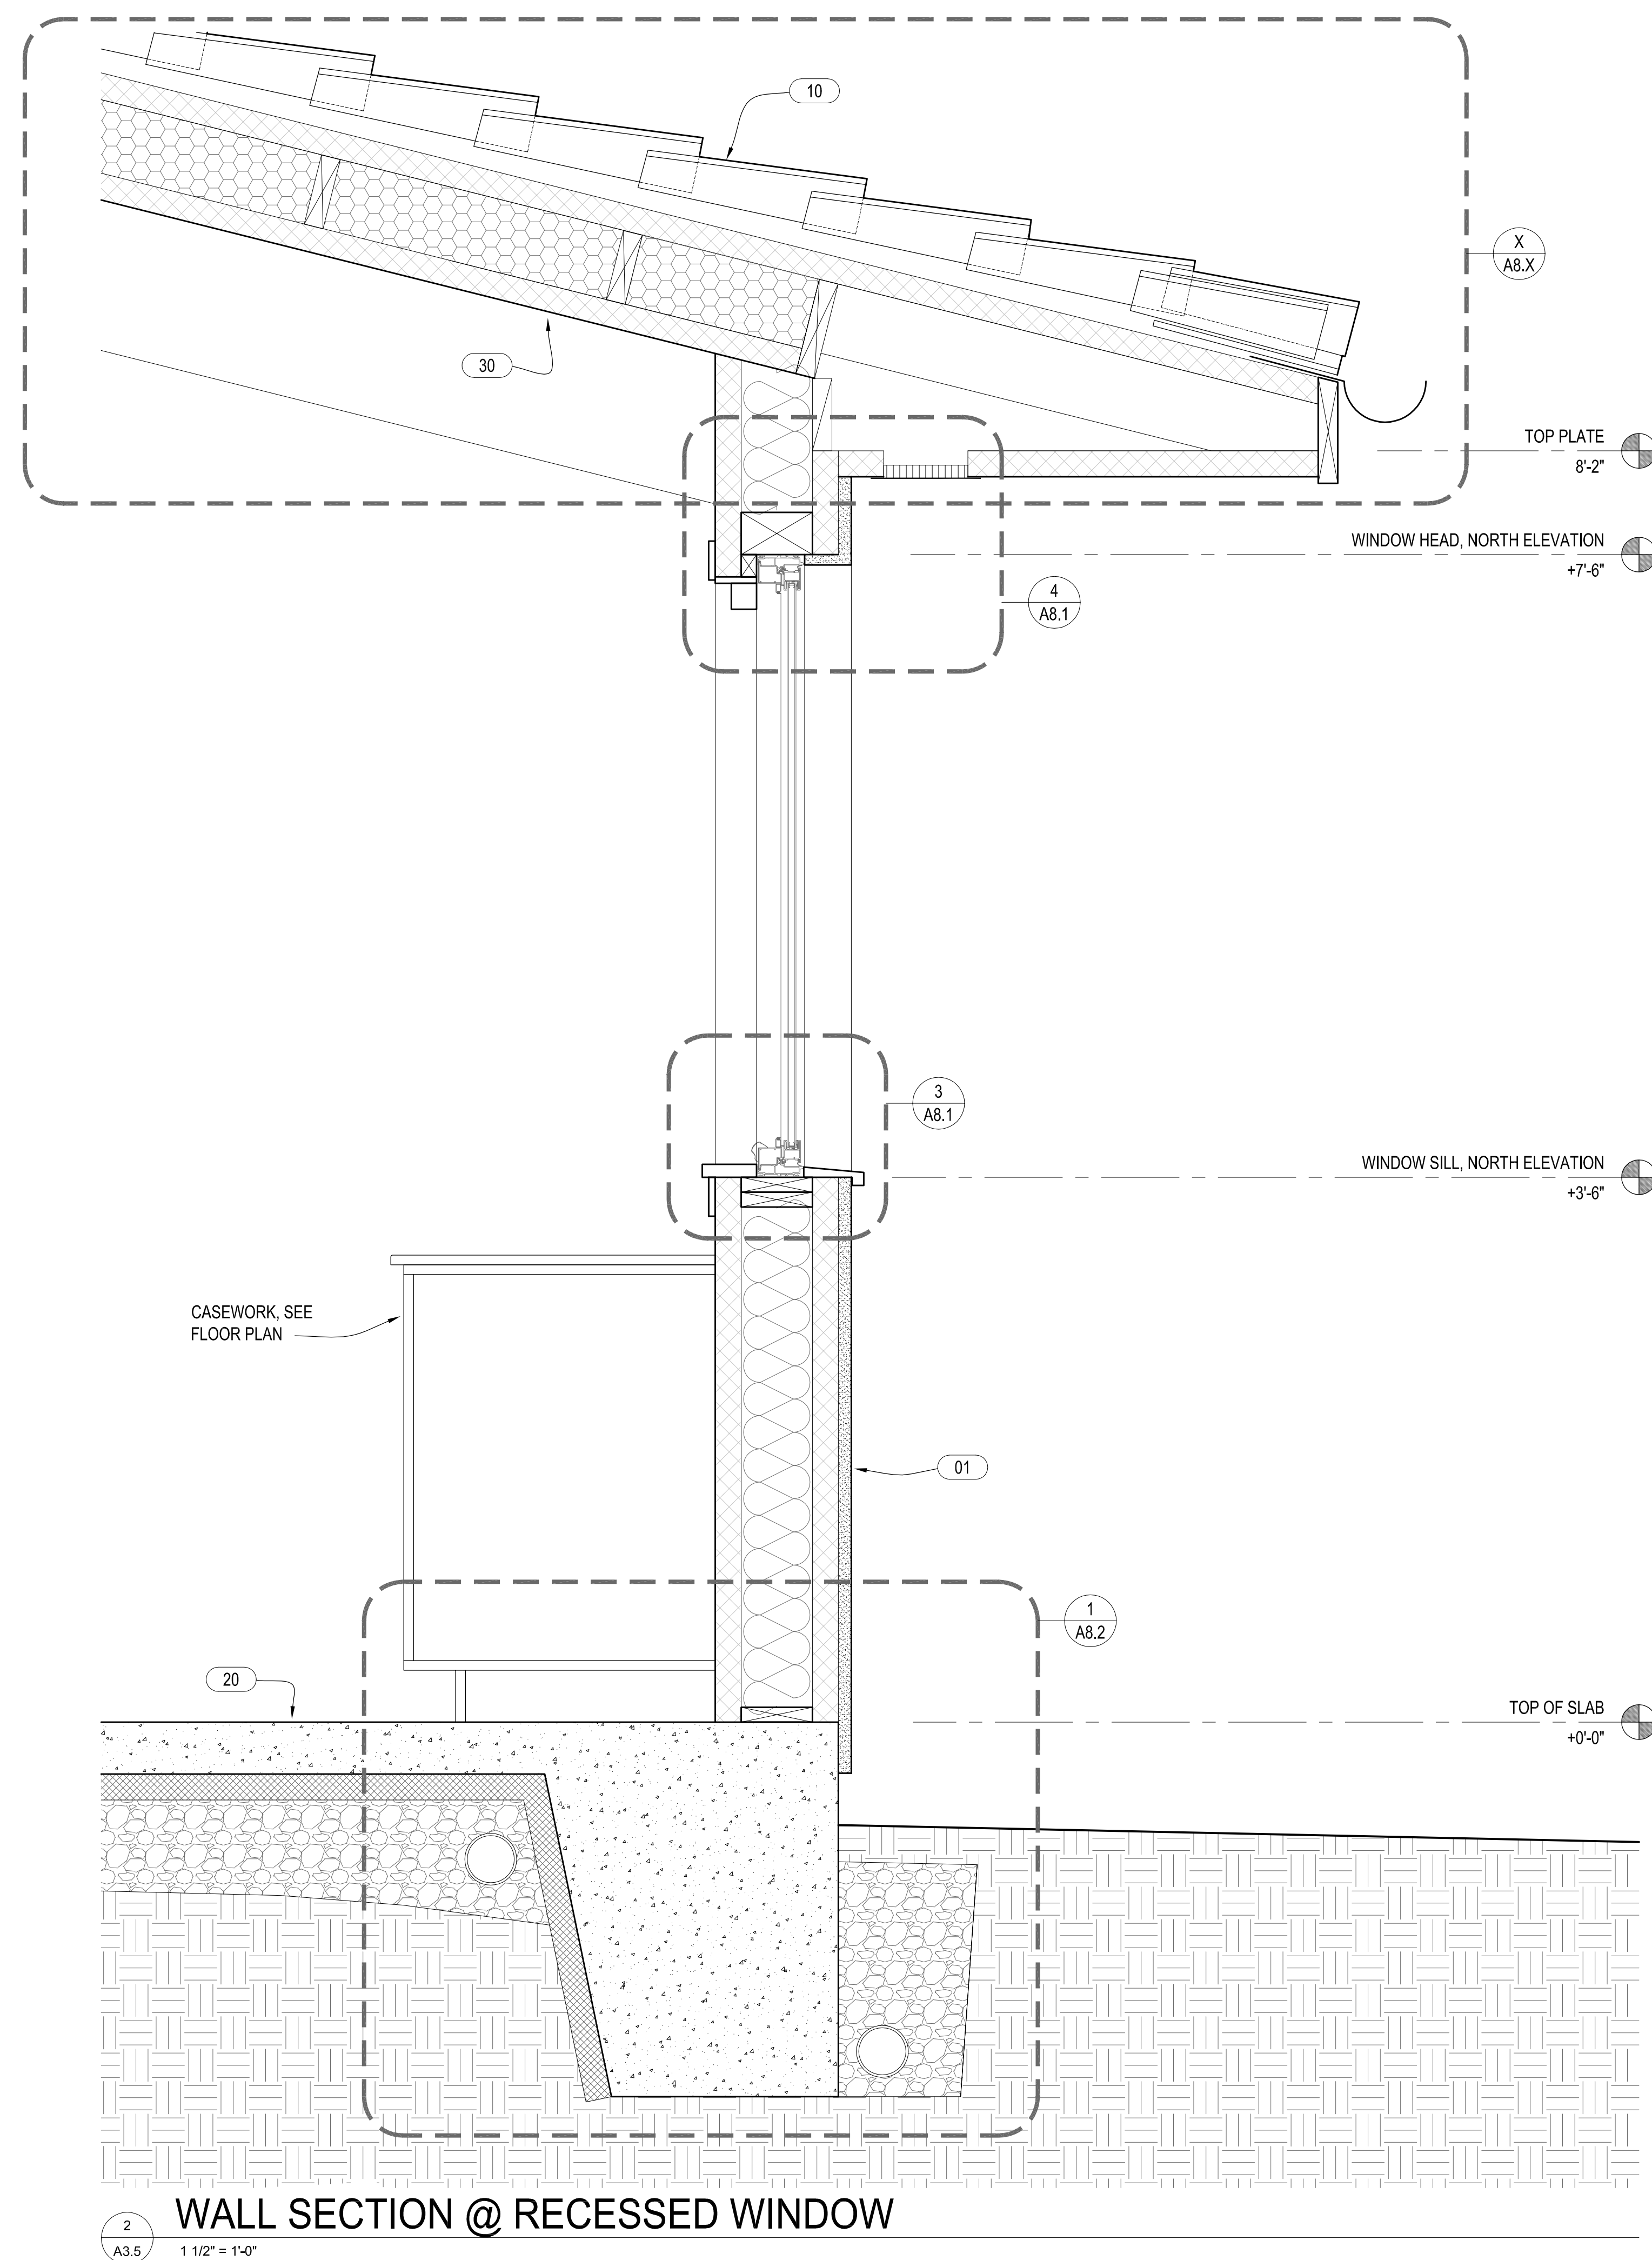
NOT FOR CONSTRUCTION

25 July 2025

Design  
Development

## Wall Sections

## A3.5






INTERIOR ELEVATION GENERAL NOTES:

1. DESIGN DEVELOPMENT DRAWINGS ARE INTENDED FOR RFP PRICING AND NOT FOR CONSTRUCTION. FOLLOWING CONTRACTOR SELECTION PROCESS, DRAWINGS AND SPECIFICATIONS WILL BE PREPARED FOR PERMITTING AND CONSTRUCTION.
2. SEE ARCHITECTURAL OUTLINE SPECIFICATIONS FOR ADDITIONAL PRODUCT AND MATERIAL INFORMATION.
3. SEE A3.0 FOR ASSEMBLY KEYNOTE LEGEND.
4. SEE A0.2 FOR CODE COMPLIANCE AND ACCESSIBILITY REQUIREMENTS.
5. PROVIDE WINDOW COVERINGS AT ALL GLAZING.
6. SEE A6.1, A6.2 AND ELECTRICAL DRAWINGS FOR OUTLETS.


INTERIOR ELEVATION KEY NOTES

- 1 INTERIOR CASEWORK, ADA ACCESSIBLE
- 2 INTERIOR CASEWORK, LOWER CABINETS
- 3 OPEN SHELVING
- 4 DISHWASHER
- 5 SINK WITH UNDERSINK DISPOSAL
- 6 UTILITY SINK
- 7 MOP SINK
- 8 FLOOR DRAIN
- 9 DRINKING FOUNTAIN WITH CANE GUARD AND ADA CLEARANCES
- 10 HVAC DUCT, SEE MECHANICAL
- 11 HVAC, PAD AND ENCLOSURE, SEE MECHANICAL DRAWINGS
- 12 REFRIGERATOR
- 13 FREEZER
- 14 WASHING MACHINE
- 15 DRYER
- 16 WINDOW COVERING
- 17 MOTORIZED SCREEN, SEE ELECTRICAL DRAWINGS
- 18 HVAC GRILLE, SEE MECHANICAL DRAWINGS
- 19 FIRE EXTINGUISHER ON BRACKET
- 20 FEC

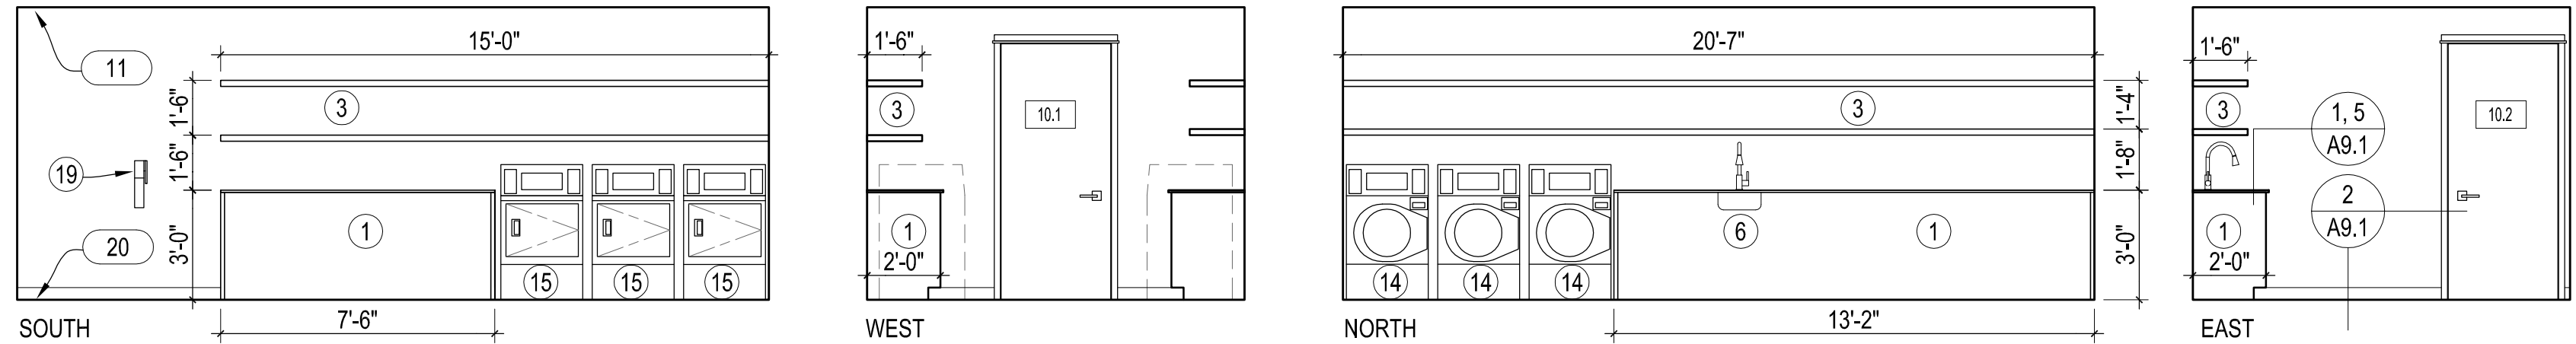


10 LAUNDRY ROOM

7  
A5.1  
1/4" = 1'-0"

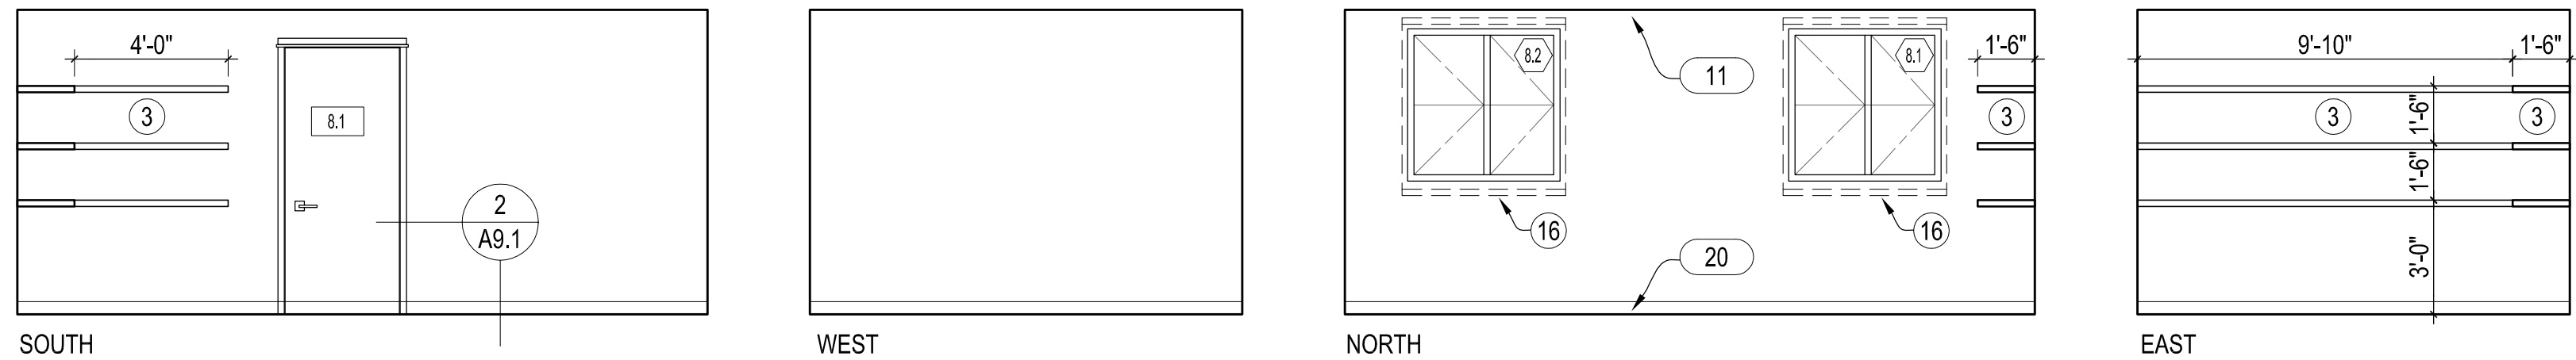

08 SUPPORT OFFICE

6  
A5.1  
1/4" = 1'-0"

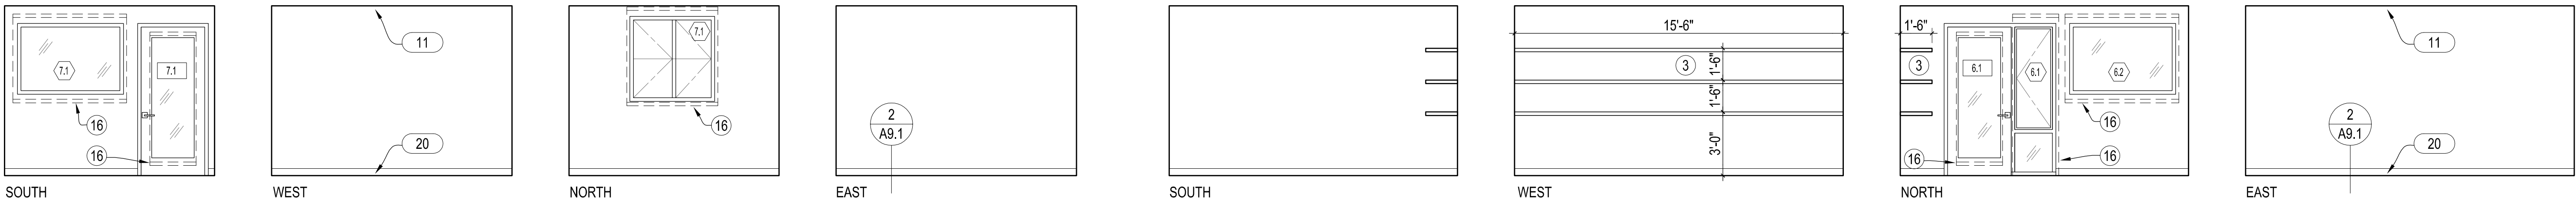


07 SECURITY OFFICE

5  
A5.1  
1/4" = 1'-0"


06 CHECK IN OFFICE

4  
A5.1  
1/4" = 1'-0"

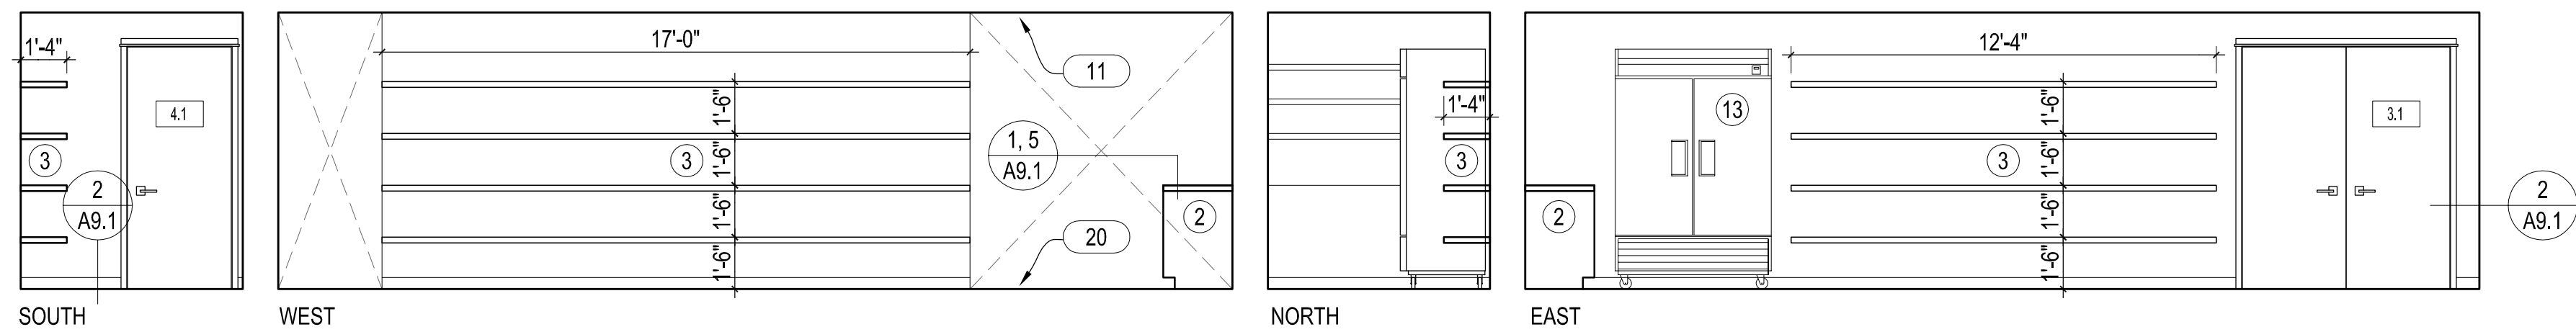


03 PANTRY

3  
A5.1  
1/4" = 1'-0"

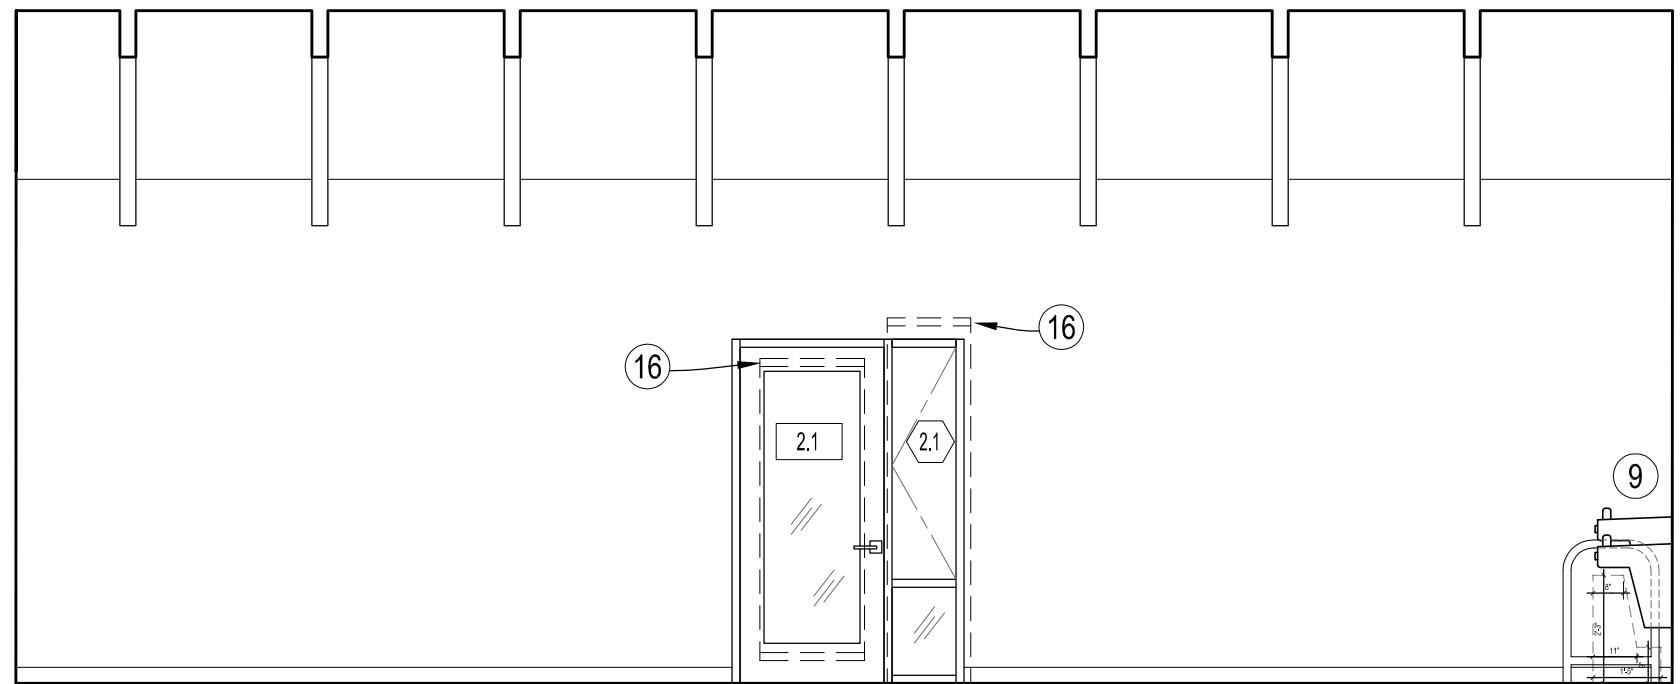



02 GATHERING SPACE (CONT.)

2  
A5.1  
1/4" = 1'-0"

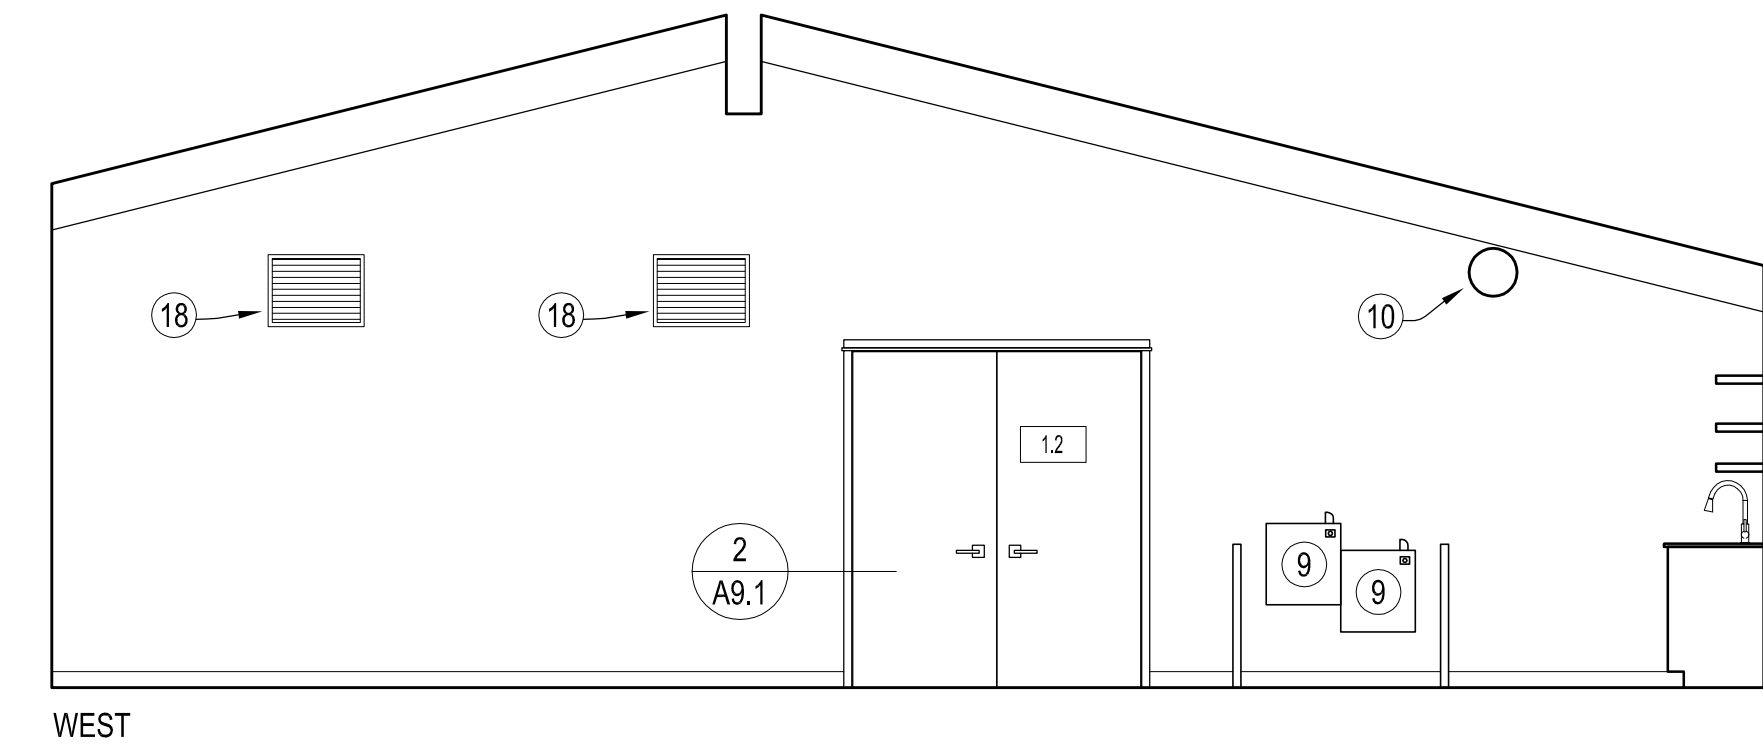

02 GATHERING SPACE

1  
A5.1  
1/4" = 1'-0"

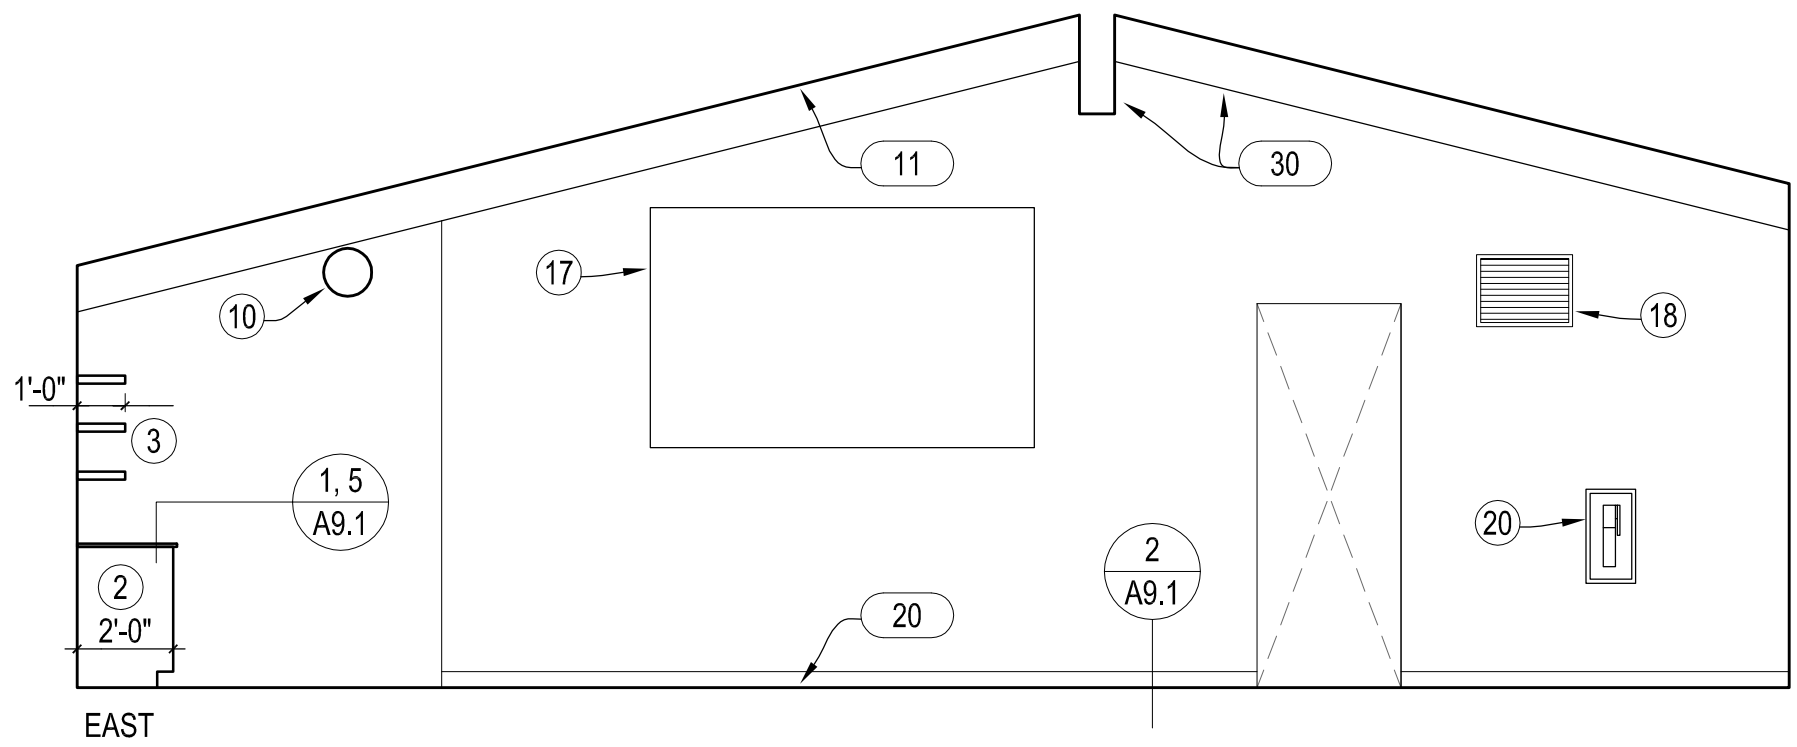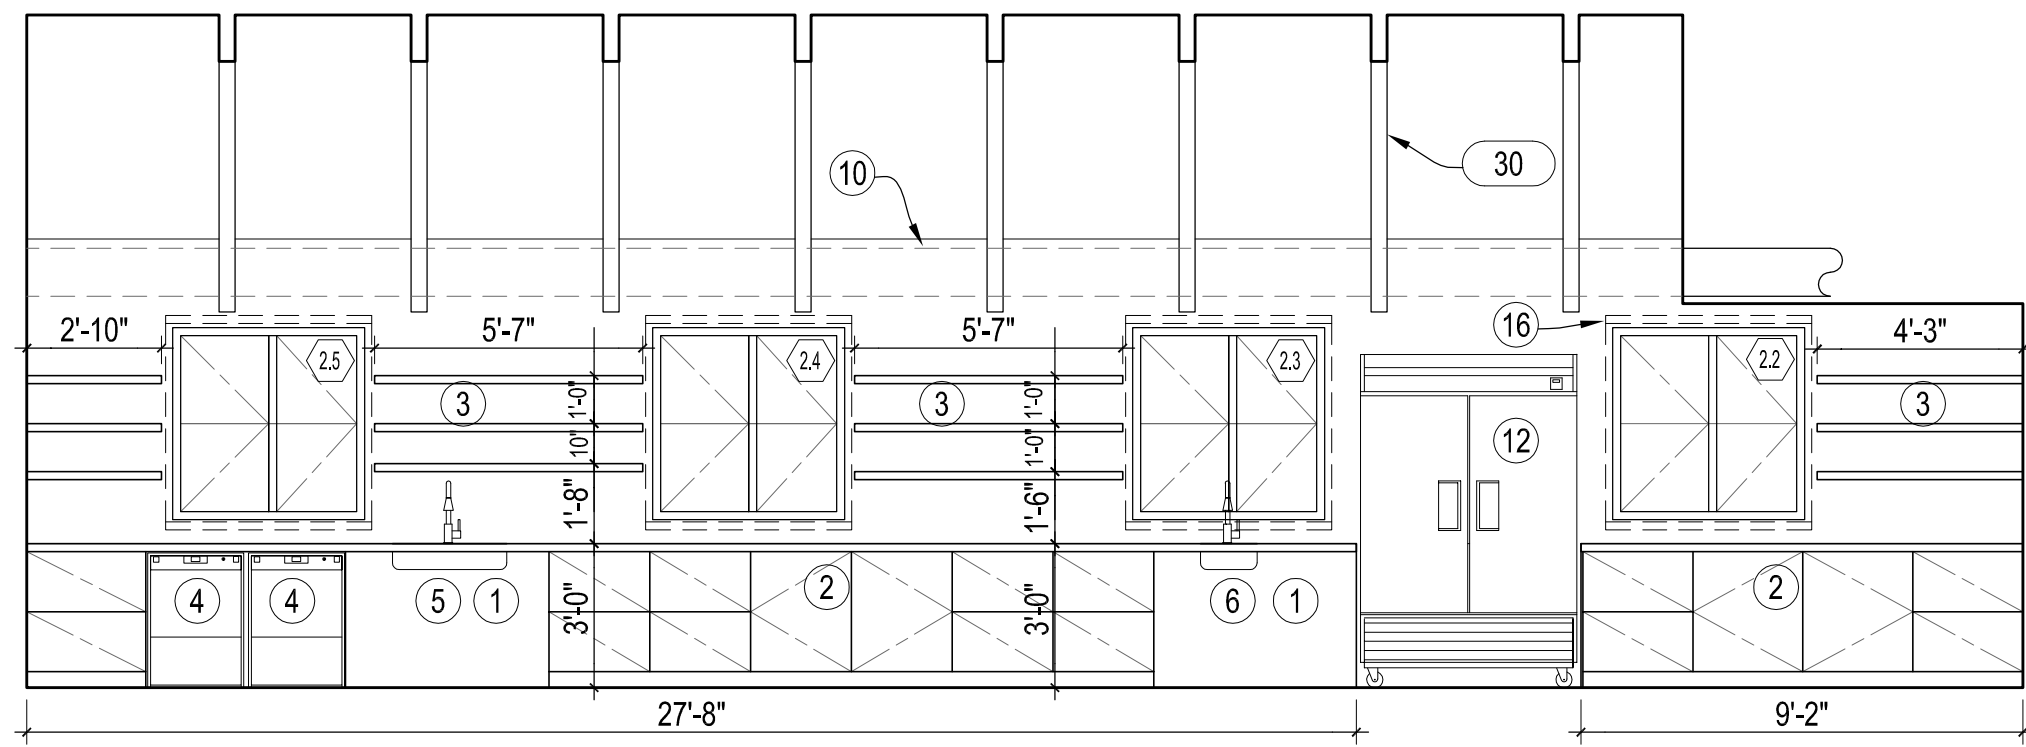



# Ojai Permanent Supportive Housing

611 South Montgomery Street, Ojai California

Drawn By: DJ  
Checked By: 2407  
Revisions:  
No. Date By

NOT FOR CONSTRUCTION

25 July 2025

Design  
Development

Reflected  
Ceiling Plan

A6.1

## REFLECTED CEILING PLAN GENERAL NOTES:


- RCP FOR FIXTURE AND DEVICE LAYOUT, SEE ELECTRICAL AND MECHANICAL DRAWINGS FOR ADDITIONAL INFORMATION.
- SEE A6.2 FOR TYPICAL RESIDENTIAL UNIT RCPs
- ALL SPACES CEILING HEIGHT 8'-0" AFF UNO (GATHERING SPACE IS VAULTED, OPEN TO STRUCTURE)
- ALL SOFFITS 8'-0" AFF UNO, SEE A8.1 FOR CORBEL DETAILS
- SPRINKLER SYSTEM NOT SHOWN. TO BE PROVIDED DESIGN-BUILD UNDER DEFERRED SUBMITTAL. PROVIDE COORDINATION DRAWING WITH RCPs.
- SEE ENERGY DOCUMENTATION FOR MINIMUM PERFORMANCE STANDARDS.
- ALL LUMINAIRES TO BE LED, DIMMABLE, 2700K 90+ CRI.
- SEE A2.9 FOR DEVICE SCHEDULES.
- UNO, FIXTURES TO BE INSTALLED ALIGNED WITH ONE ANOTHER AND CENTERED BETWEEN STRUCTURE AND/OR WALLS.
- SEE STRUCTURAL DRAWINGS FOR BEAM SIZES AND CLEAR HEADROOM BELOW BEAMS.
- AT GATHERING AREA COUNTERTOPS, PROVIDE EQUALLY SPACED GFCI OUTLETS AT 24" O.C.
- ALL CONDUIT, PIPING AND DUCTWORK TO BE CONCEALED.
- SEE A3.0 FOR ASSEMBLY KEYNOTE SCHEDULE.
- LAYOUT OF GENERAL USE DUPLEX OUTLETS ARE SHOWN. ELECTRICAL SYSTEM SHALL INCLUDE POWER SUPPLY TO APPLIANCES AND MECHANICAL SYSTEM AS REQUIRED. PROVIDE GFCI OUTLETS AND WEATHER PROTECTION PER 2022 CEC.
- MANUFACTURER'S LITERATURE SHOWING PROPOSED LED AND/OR LOW VOLTAGE LIGHT FIXTURES ARE HIGH EFFICACY AND CALIFORNIA CERTIFIED IS TO BE ON-SITE AT TIME OF FIELD INSPECTION.
- FIRESTOP ALL PENETRATIONS IN RATED WALLS SEPARATING UNITS.
- PROVIDE GFCI PROTECTION TO ALL 120V RECEPTACLES INSTALLED IN BATHROOMS, OUTDOORS, GATHERING SPACE, MECHANICAL, STORAGE BUILDING AND LAUNDRY.
- PROVIDE GFCI PROTECTION FOR DISHWASHER OUTLETS.
- PROVIDE OCCUPANCY AND HUMIDITY SENSORS PER CEC.
- PROVIDE TIMERS AS REQUIRED BY CODE FOR OUTDOOR FIXTURES.
- PROVIDE MINIMUM QNTY OF GENERAL USE OUTLETS EVERY 6' ALONG WALLS OF OFFICES, HALLS, MECHANICAL AND LAUNDRY.
- ALL PENETRATIONS AT RATED WALLS AND CEILINGS TO BE FIRESTOPPED AND SEALED TO MAINTAIN REQUIRED FIRE RESISTANCE RATING.

## ELECTRICAL FIXTURE AND DEVICE LEGEND


- R1 RECESSED FIXTURE 1 - FIRE RATED DISK 4" DISK LIGHT, DIMMABLE, 2700K 90+ CRI., WET RATED - DARK SKY COMPLIANT, CENTER IN ROOM, BETWEEN STRCT, OR MOUNT 24" OFF WALL UNO
- W1 EXTERIOR WALL MOUNTED SCENCE
- P1 PENDANTS, MILLENNIUM LIGHTING RWHC17R, MATTE BLACK FINISH, 2700K HALF MIRROR BULBS, MOUNT BOTTOM OF FIXTURE 7'-0" AFF, CENTER BETWEEN STRCT
- 5-0" Ø CEILING FAN
- W WALL SWITCH , MOUNT CENTER AT 48" AFF (SUBSCRIPT "D" INDICATES DIMMER,TYP)
- W3 WALL SWITCH (3 WAY) , MOUNT CENTER AT 48" AFF
- W4 WALL SWITCH (TIMER), MOUNT CENTER AT 48" AFF
- W5 WALL SWITCH - HUMIDITY SENSOR
- W6 WALL SWITCH - OCCUPANCY SENSOR
- TAMPER RESISTANT GENERAL USE DUPLEX OUTLET  
MOUNT TOP CENTER AT 12" AFF (36" AFF WHEN ABV COUNTERTOP)
- TAMPER RESISTANT FLOOR OUTLET
- TAMPER RESISTANT GFCI OUTLET, PROVIDE POST-MOUNTED UL LISTED COVER AT EXTERIOR
- SMOKE & CARBON MONOXIDE ALARM, INTERCONNECTED
- DATA OUTLET
- TELEPHONE JACK
- HARDWIRED SECURITY CAMERA, REVIEW COVERAGE WITH OWNER
- EXIT SIGN
- ELEC PANEL, SEE ELECTRICAL DRAWINGS
- ACCOUSTIC PANEL

## HVAC LEGEND SEE MECHANICAL DRAWINGS FOR ADDL INFORMATION

- EF EXHAUST FAN, SEE MECHANICAL DRAWINGS
- WALL MOUNTED MINI SPLIT

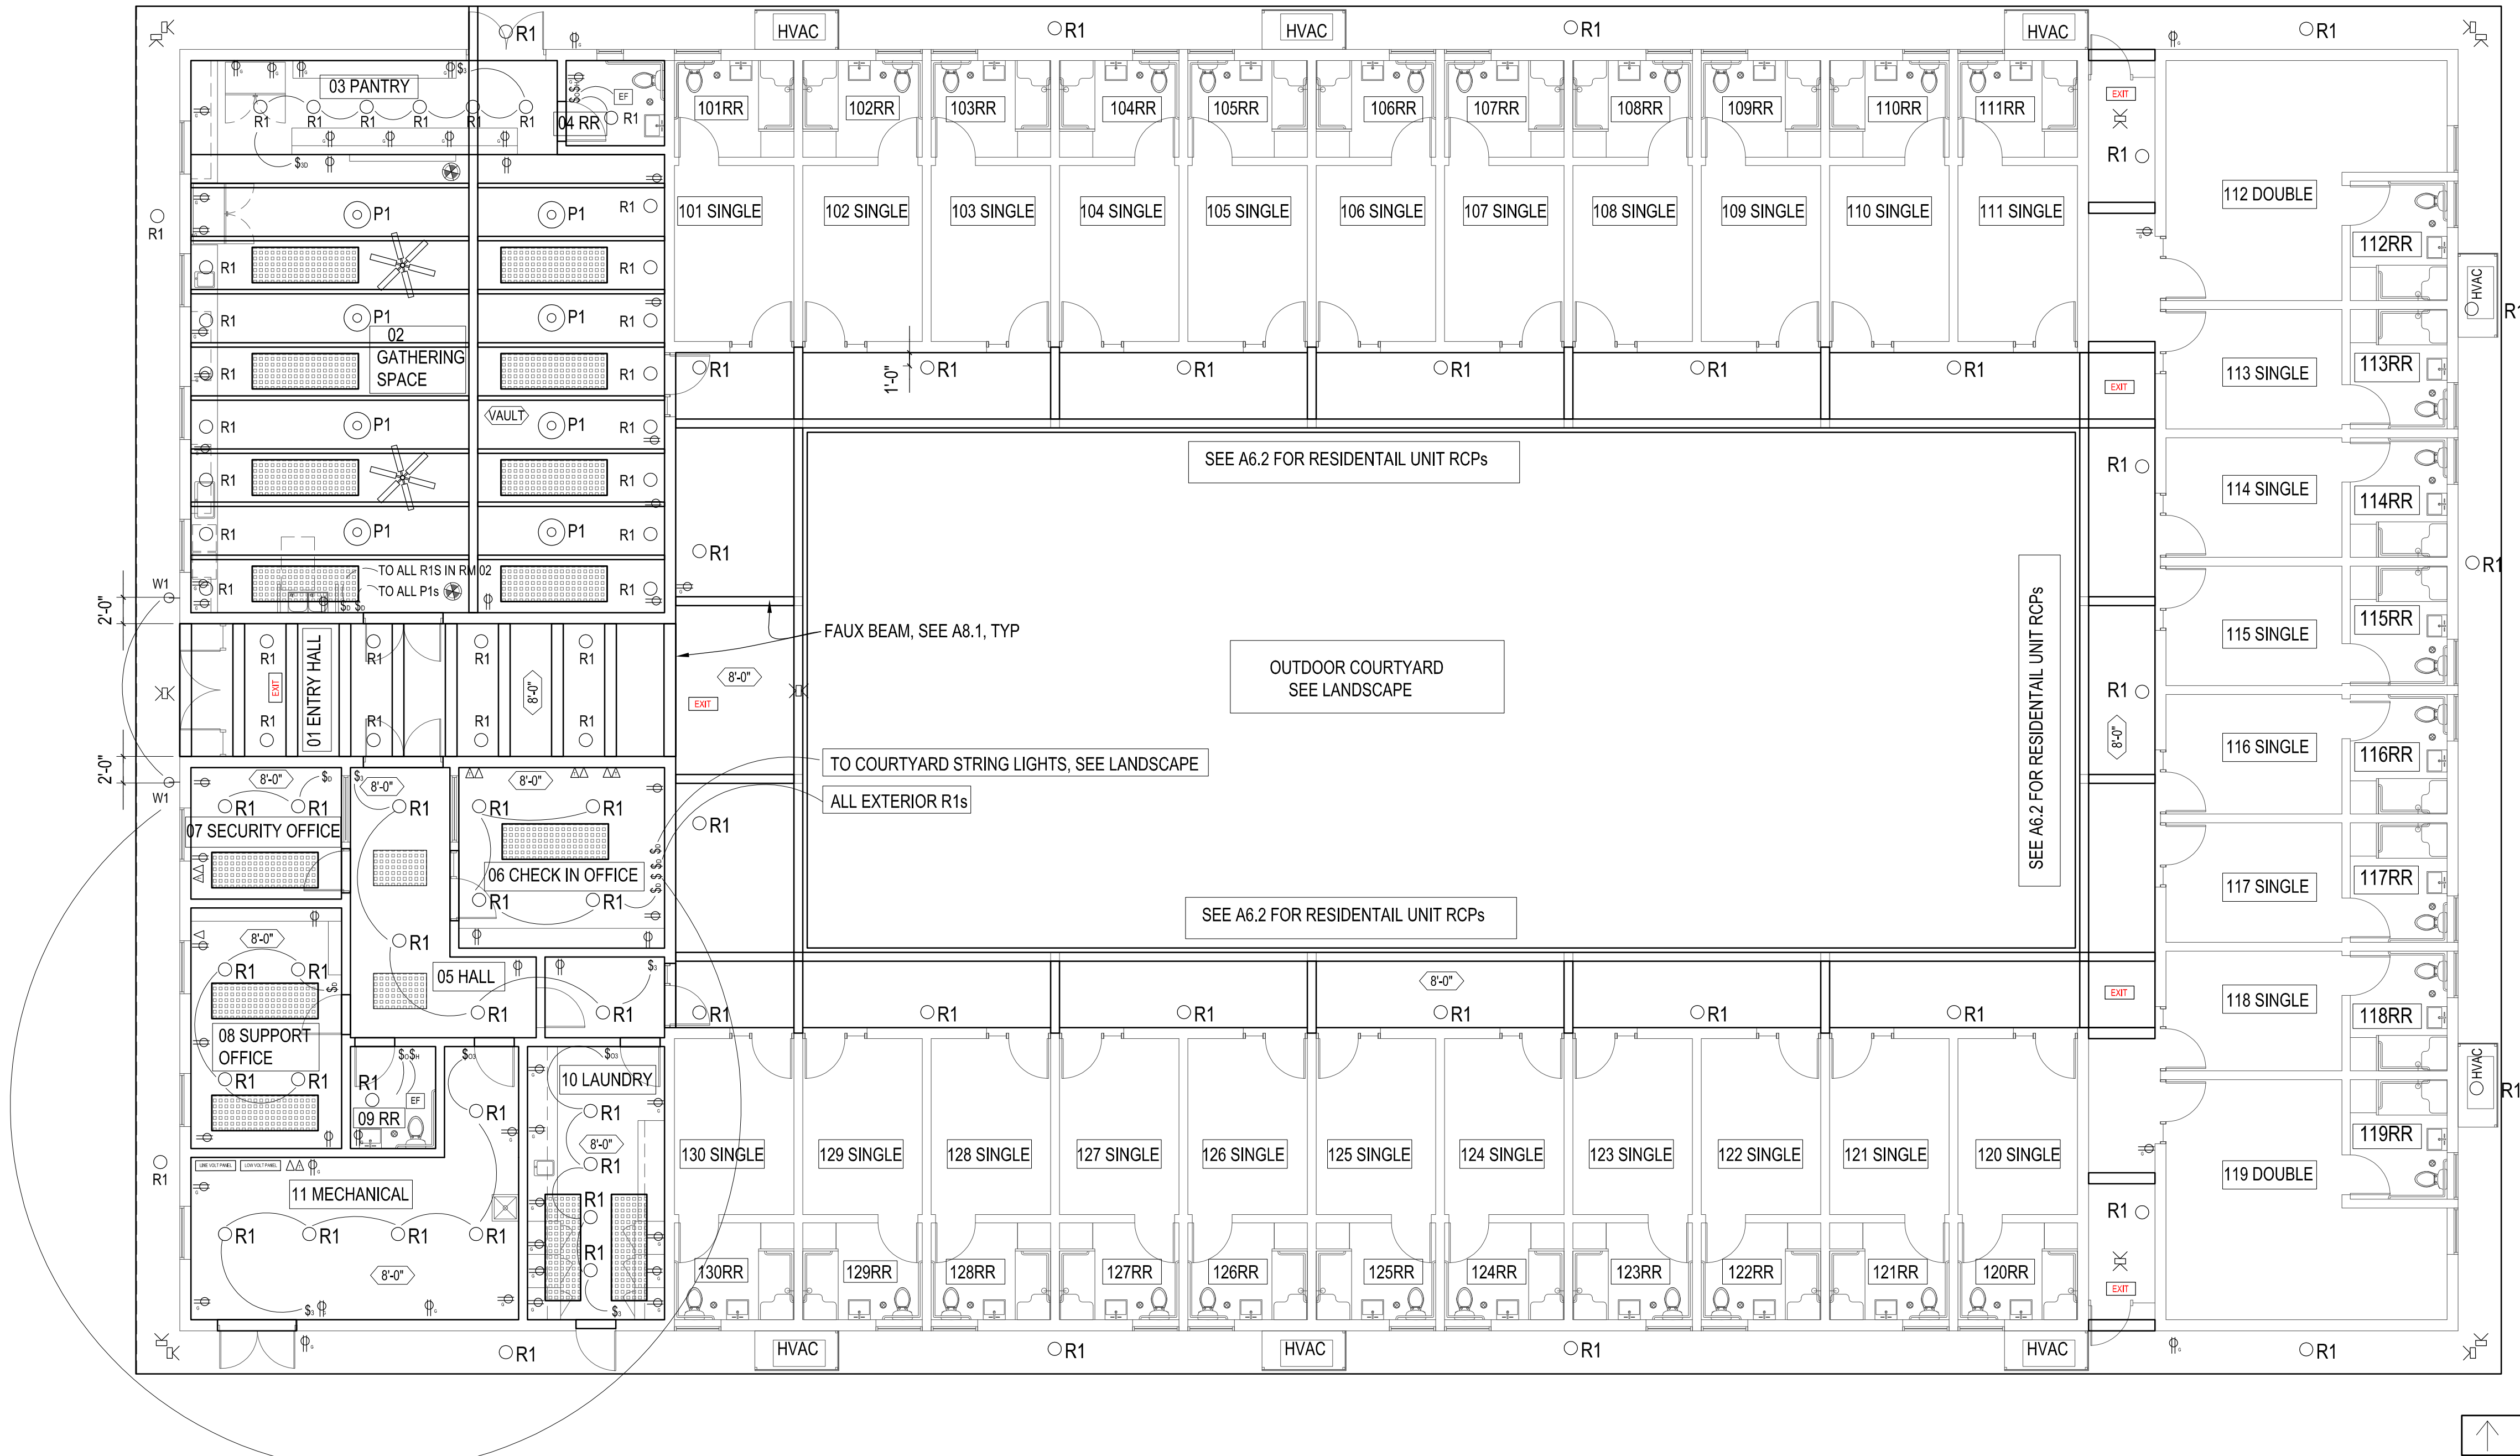



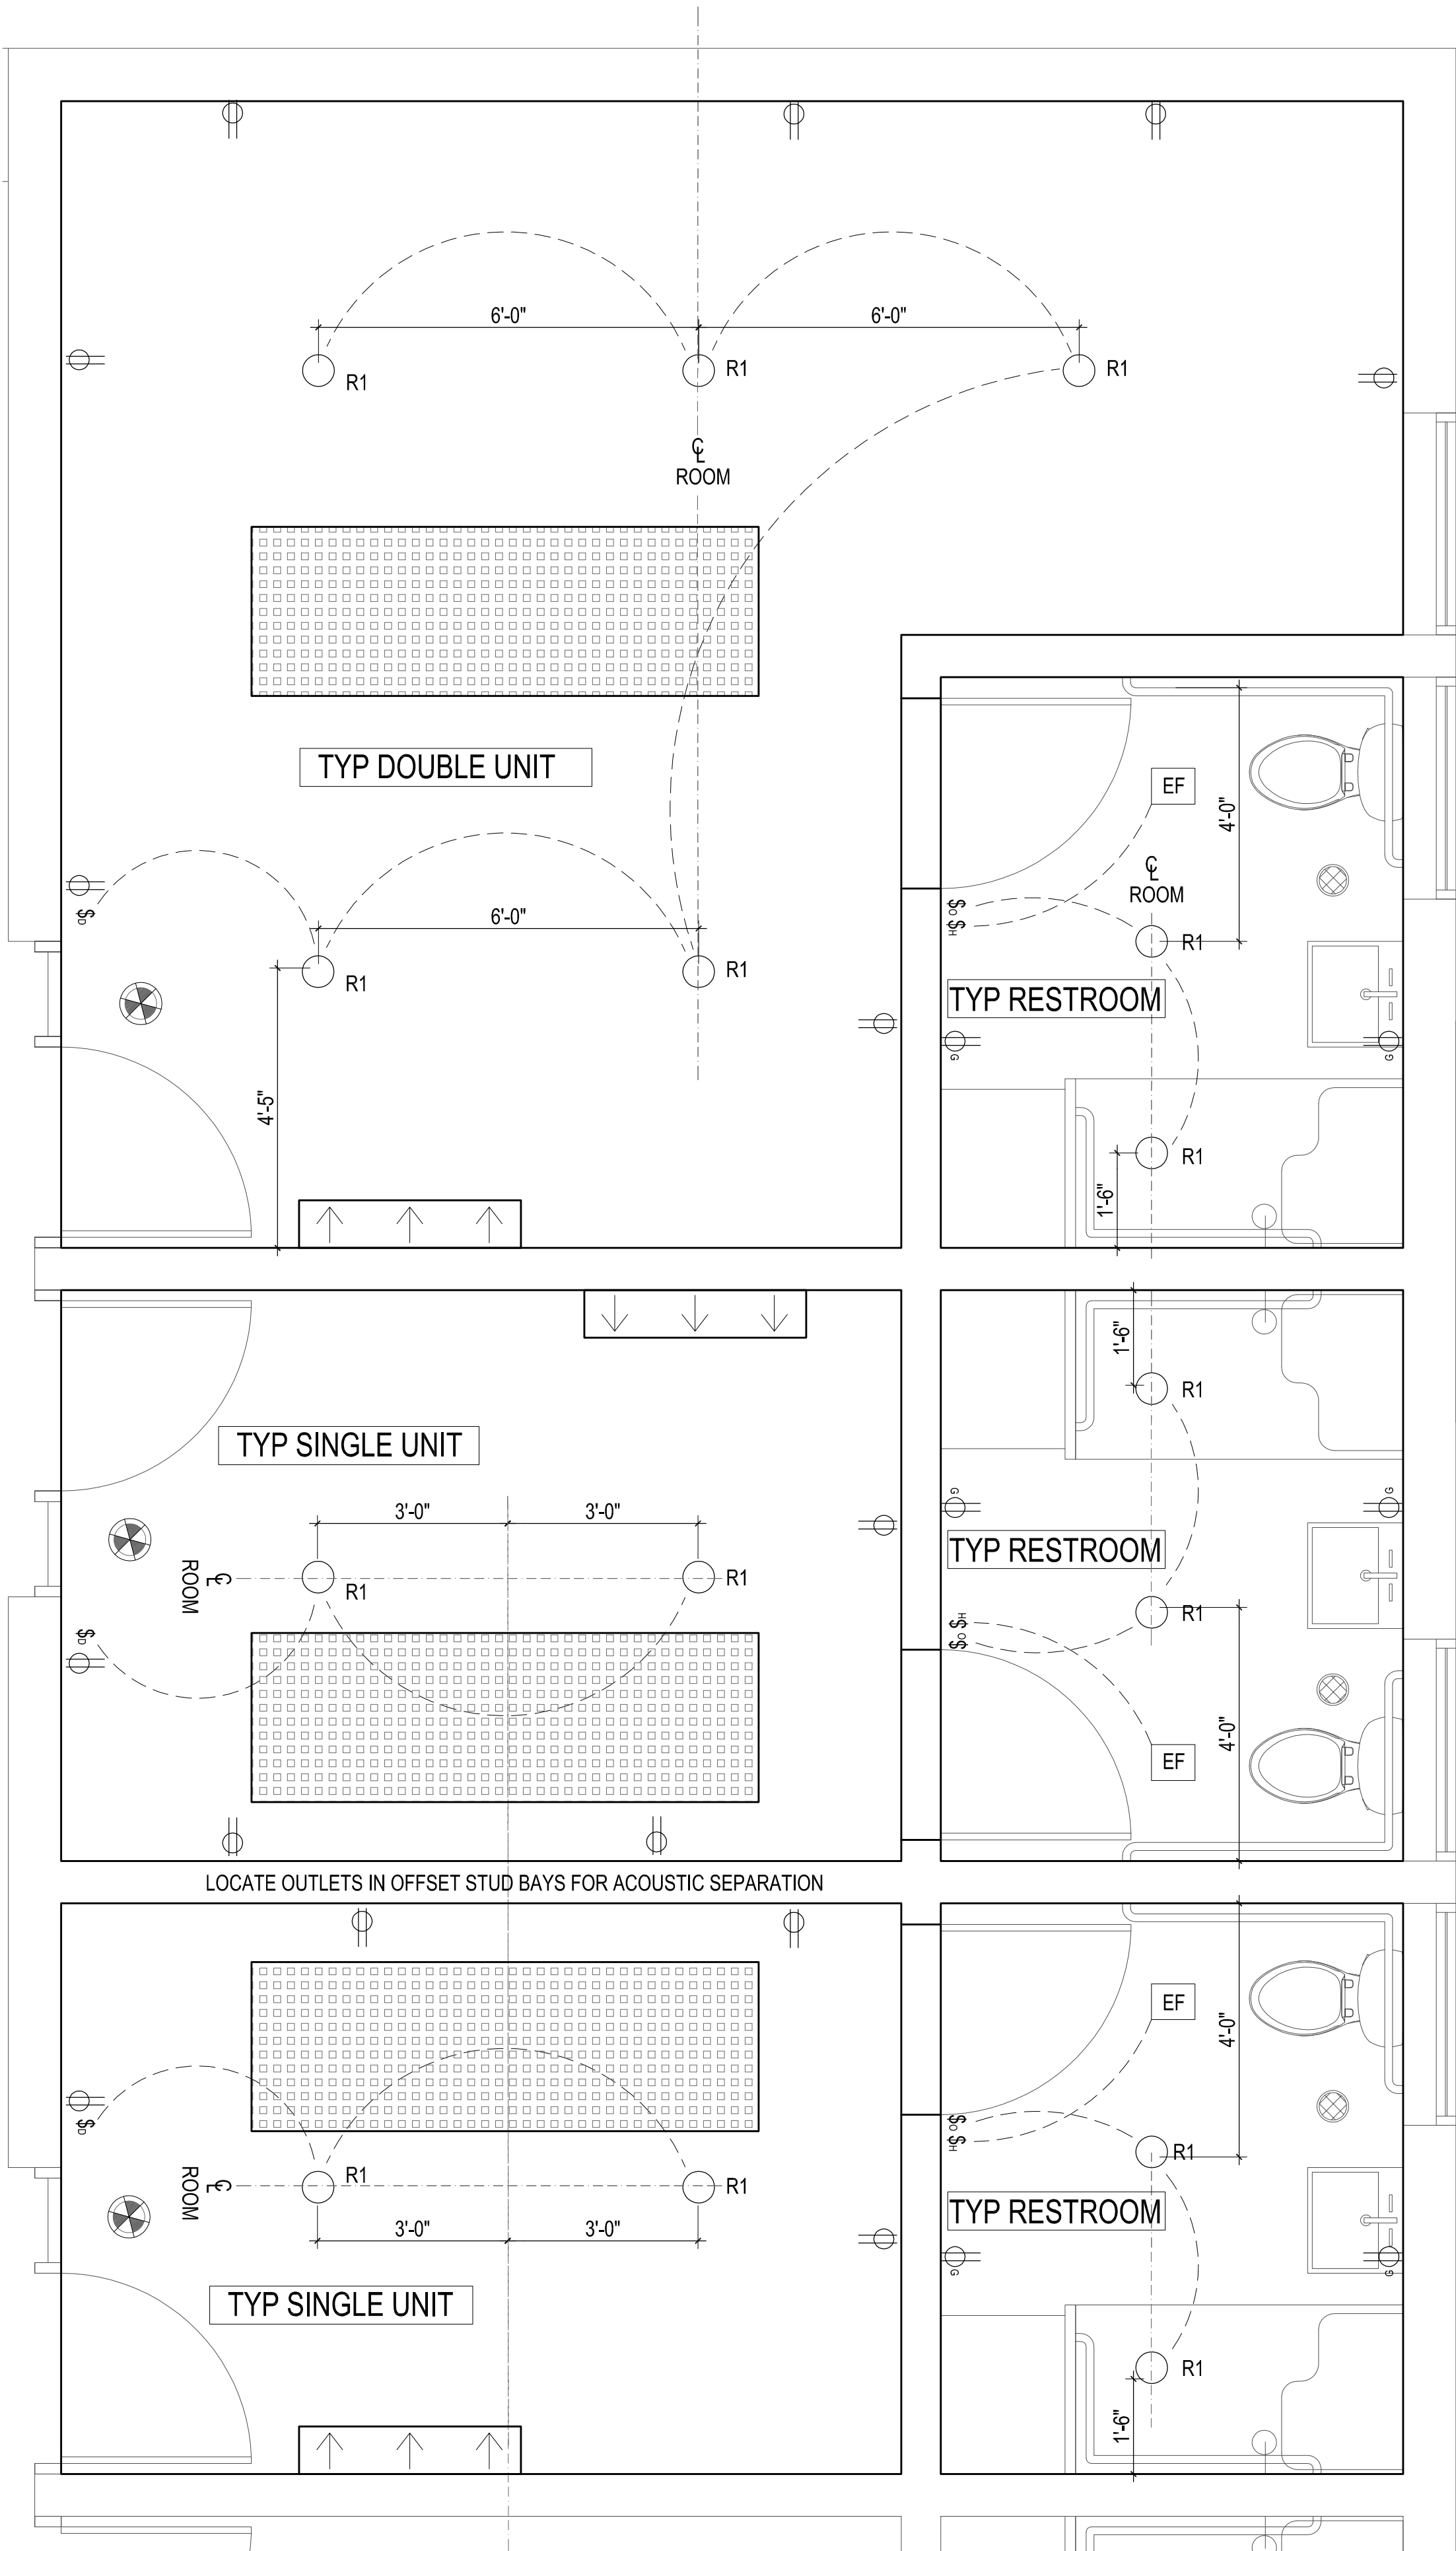

- REFLECTED CEILING PLAN GENERAL NOTES:
1. RCP FOR FIXTURE AND DEVICE LAYOUT, SEE ELECTRICAL AND MECHANICAL DRAWINGS FOR ADDITIONAL INFORMATION.
  2. SEE A6.2 FOR TYPICAL RESIDENTIAL UNIT RCPS
  3. ALL SPACES CEILING HEIGHT 8'-0" AFF UNO (GATHERING SPACE IS VAULTED, OPEN TO STRUCTURE)
  4. ALL SOFFITS 8'-0" AFF UNO, SEE A8.1 FOR CORBEL DETAILS
  5. SPRINKLER SYSTEM NOT SHOWN. TO BE PROVIDED DESIGN-BUILD UNDER DEFERRED SUBMITTAL. PROVIDE COORDINATION DRAWING WITH RCPS.
  6. SEE ENERGY DOCUMENTATION FOR MINIMUM PERFORMANCE STANDARDS.
  7. ALL LUMINAIRES TO BE LED, DIMMABLE, 2700K 90+ CRI.
  8. SEE A2.9 FOR DEVICE SCHEDULES.
  9. UNO, FIXTURES TO BE INSTALLED ALIGNED WITH ONE ANOTHER AND CENTERED BETWEEN STRUCTURE AND/OR WALLS.
  10. SEE STRUCTURAL DRAWINGS FOR BEAM SIZES AND CLEAR HEADROOM BELOW BEAMS.
  11. AT GATHERING AREA COUNTERTOPS, PROVIDE EQUALLY SPACED GFCI OUTLETS AT 24" O.C.
  12. ALL CONDUIT, PIPING AND DUCTWORK TO BE CONCEALED.
  13. SEE A3.0 FOR ASSEMBLY KEYNOTE SCHEDULE.
  14. LAYOUT OF GENERAL USE DUPLEX OUTLETS ARE SHOWN. ELECTRICAL SYSTEM SHALL INCLUDE POWER SUPPLY TO APPLIANCES AND MECHANICAL SYSTEM AS REQUIRED. PROVIDE GFCI OUTLETS AND WEATHER PROTECTION PER 2022 CEC.
  15. MANUFACTURER'S LITERATURE SHOWING PROPOSED LED AND/OR LOW VOLTAGE LIGHT FIXTURES ARE HIGH EFFICACY AND CALIFORNIA CERTIFIED IS TO BE ON-SITE AT TIME OF FIELD INSPECTION.
  16. FIRESTOP ALL PENETRATIONS IN RATED WALLS SEPARATING UNITS.
  17. PROVIDE GFCI PROTECTION TO ALL 120V RECEPTACLES INSTALLED IN BATHROOMS, OUTDOORS, GATHERING SPACE, MECHANICAL, STORAGE BUILDING AND LAUNDRY.
  18. PROVIDE GFCI PROTECTION FOR DISHWASHER OUTLETS.
  19. PROVIDE OCCUPANCY AND HUMIDITY SENSORS PER CEC.
  20. PROVIDE TIMERS AS REQUIRED BY CODE FOR OUTDOOR FIXTURES.
  21. PROVIDE MINIMUM QNTY OF GENERAL USE OUTLETS EVERY 6' ALONG WALLS OF OFFICES, HALLS, MECHANICAL AND LAUNDRY.
  22. ALL PENETRATIONS AT RATED WALLS AND CEILINGS TO BE FIRESTOPPED AND SEALED TO MAINTAIN REQUIRED FIRE RESISTANCE RATING.

ELECTRICAL FIXTURE AND DEVICE LEGEND

- R1 RECESSED FIXTURE 1 - FIRE RATED DISK 4" DISK LIGHT, DIMMABLE, 2700K 90+ CRI., WET RATED - DARK SKY COMPLIANT, CENTER IN ROOM, BETWEEN STRCT, OR MOUNT 24" OFF WALL UNO
- W1 EXTERIOR WALL MOUNTED SCONCE
- P1 PENDANTS, MILLENNIUM LIGHTING RWHC17R, MATTE BLACK FINISH, 2700K HALF MIRROR BULBS, MOUNT BOTTOM OF FIXTURE 7'-0" AFF, CENTER BETWEEN STRCT
- 5'-0" Ø CEILING FAN
- S WALL SWITCH , MOUNT CENTER AT 48" AFF (SUBSCRIPT "D" INDICATES DIMMER,TYP)
- S3 WALL SWITCH (3 WAY) , MOUNT CENTER AT 48" AFF
- S7 WALL SWITCH (TIMER), MOUNT CENTER AT 48" AFF
- S4 WALL SWITCH - HUMIDITY SENSOR
- S5 WALL SWITCH - OCCUPANCY SENSOR
- TAMPER RESISTANT GENERAL USE DUPLEX OUTLET MOUNT TOP CENTER AT 12" AFF (36" AFF WHEN ABV COUNTERTOP)
- F TAMPER RESISTANT FLOOR OUTLET
- G TAMPER RESISTANT GFCI OUTLET, PROVIDE POST-MOUNTED UL LISTED COVER AT EXTERIOR
- SMOKE & CARBON MONOXIDE ALARM, INTERCONNECTED
- DATA OUTLET
- TELEPHONE JACK
- HARDWIRED SECURITY CAMERA, REVIEW COVERAGE WITH OWNER
- EXIT EXIT SIGN
- LINE VOLT PANEL
- LOW VOLT PANEL
- ELEC PANEL, SEE ELECTRICAL DRAWINGS
- ACCOUSTIC PANEL

HVAC LEGEND SEE MECHANICAL DRAWINGS FOR ADDL INFORMATION

- EF EXHAUST FAN, SEE MECHANICAL DRAWINGS
- WALL MOUNTED MINI SPLIT

Ojai Permanent Supportive Housing

611 South Montgomery Street, Ojai California

Drawn By: DJ  
Checked By:  
Job No. 2407

Revisions:		
No.	Date	By

NOT FOR CONSTRUCTION

25 July 2025

Design  
Development

Enlarged  
Unit RCPs

A6.2



# Ojai Permanent Supportive Housing

611 South Montgomery Street, Ojai California

Drawn By:	DJ	
Checked By:		
Job No.	2407	
Revisions:		
No.	Date	E


NOT FOR CONSTRUCTION

25 July 2025

Design  
Development


Exterior  
Details

A8.1

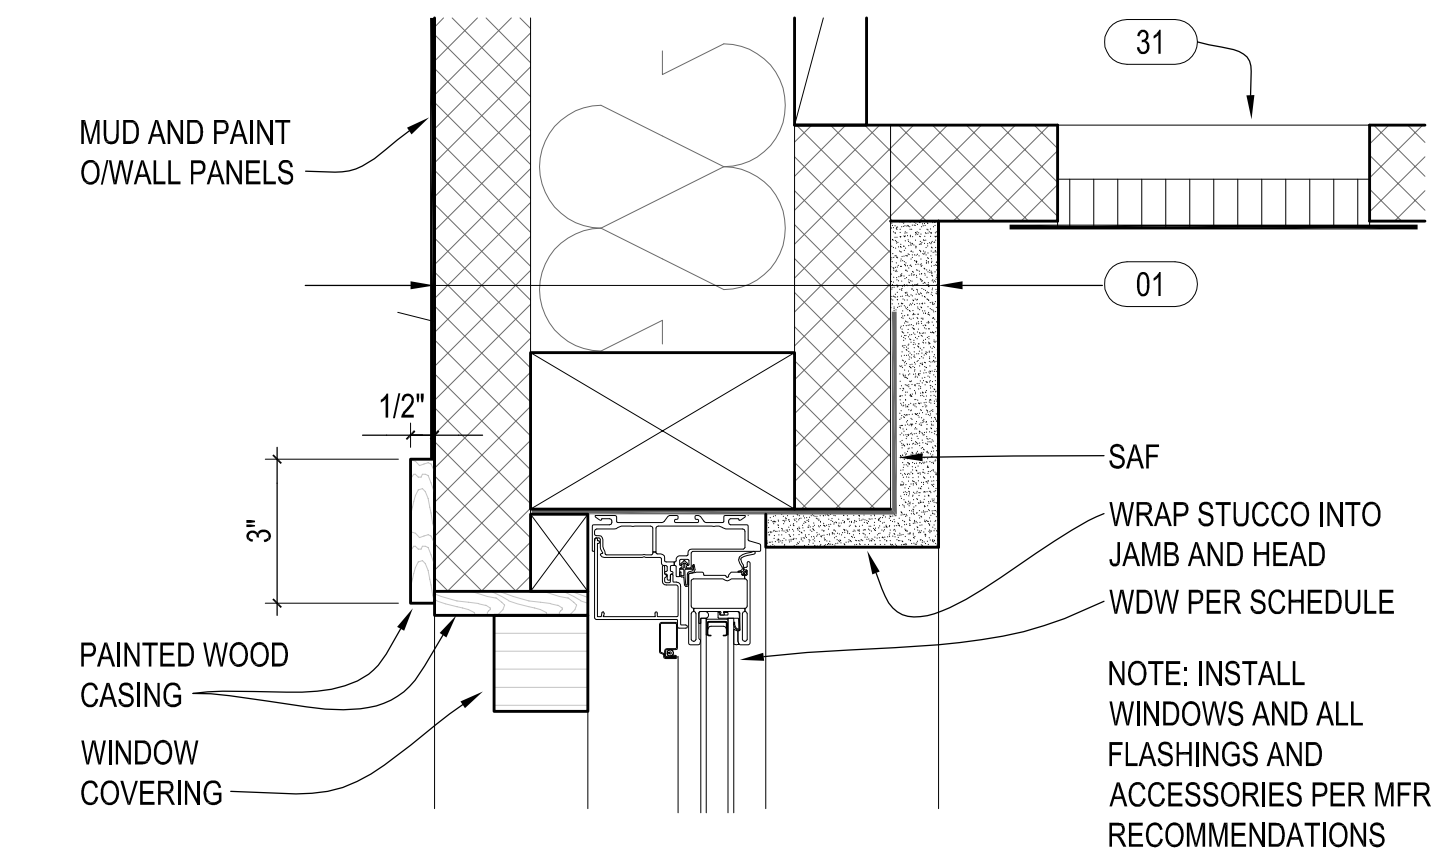


4  
A8.1  
3"=1'-0"

## RECESSED WINDOW HEAD & JAMB

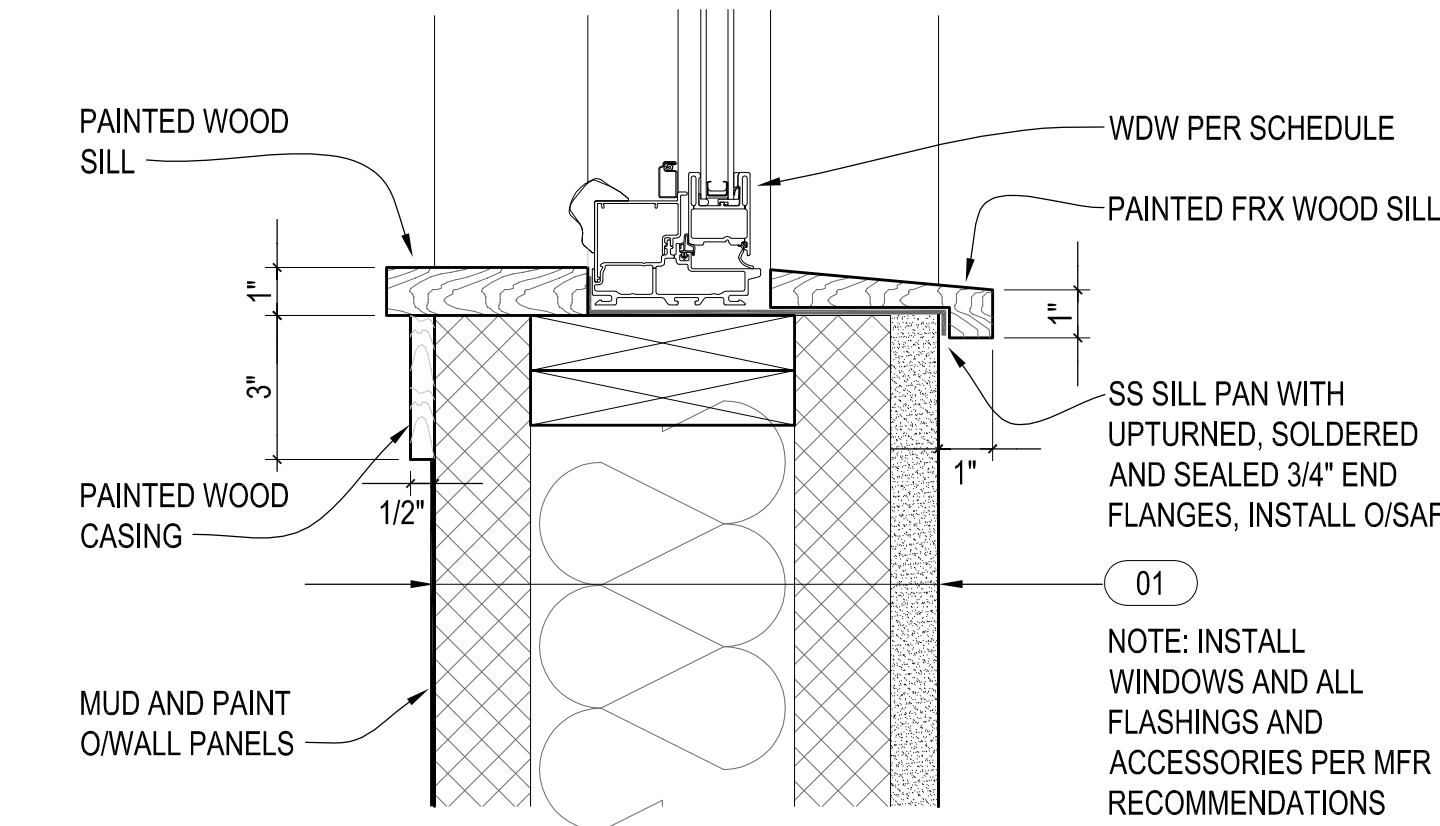


3  
A8.1  
3"=1'-0"

## RECESSED WINDOW SILL

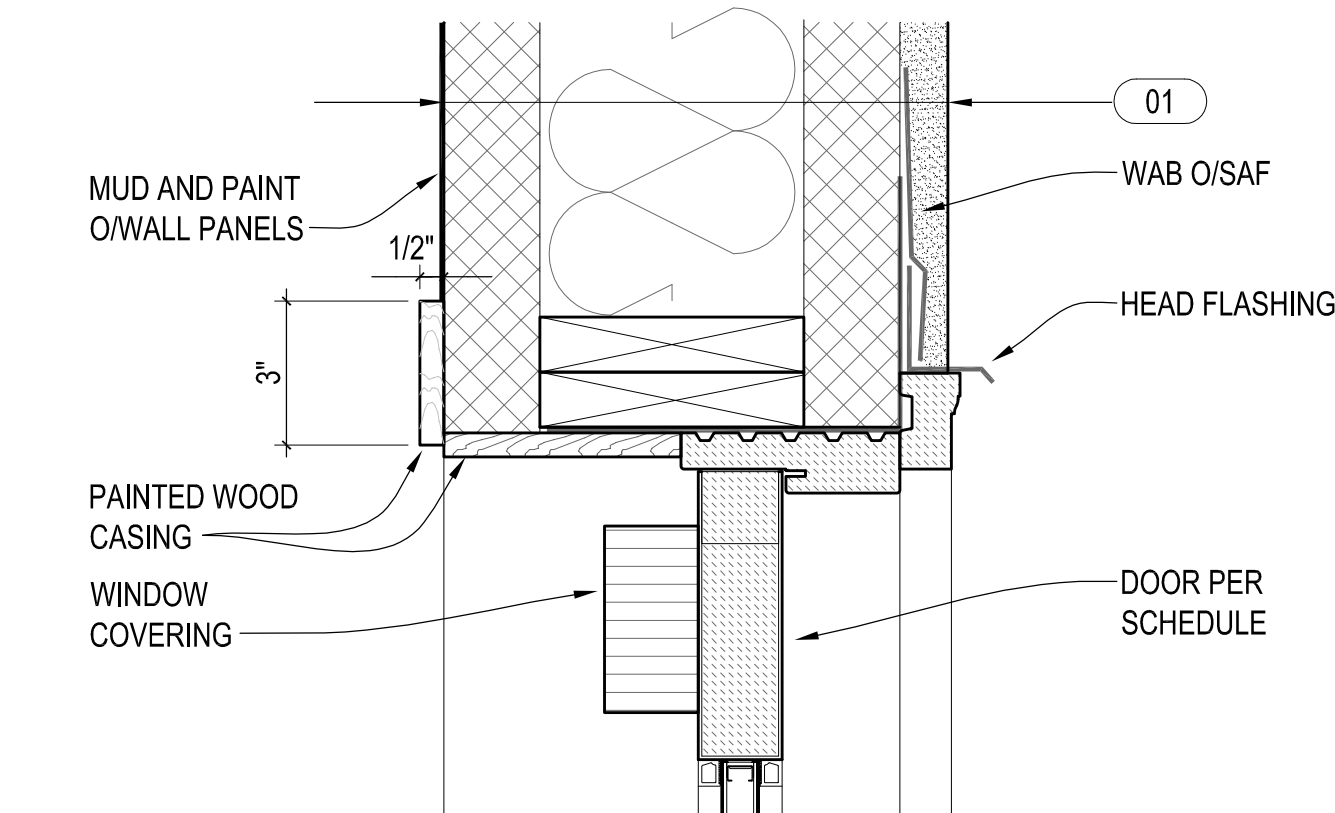


6  
A8.1  
3"=1'-0"

## DOOR HEAD & JAMB

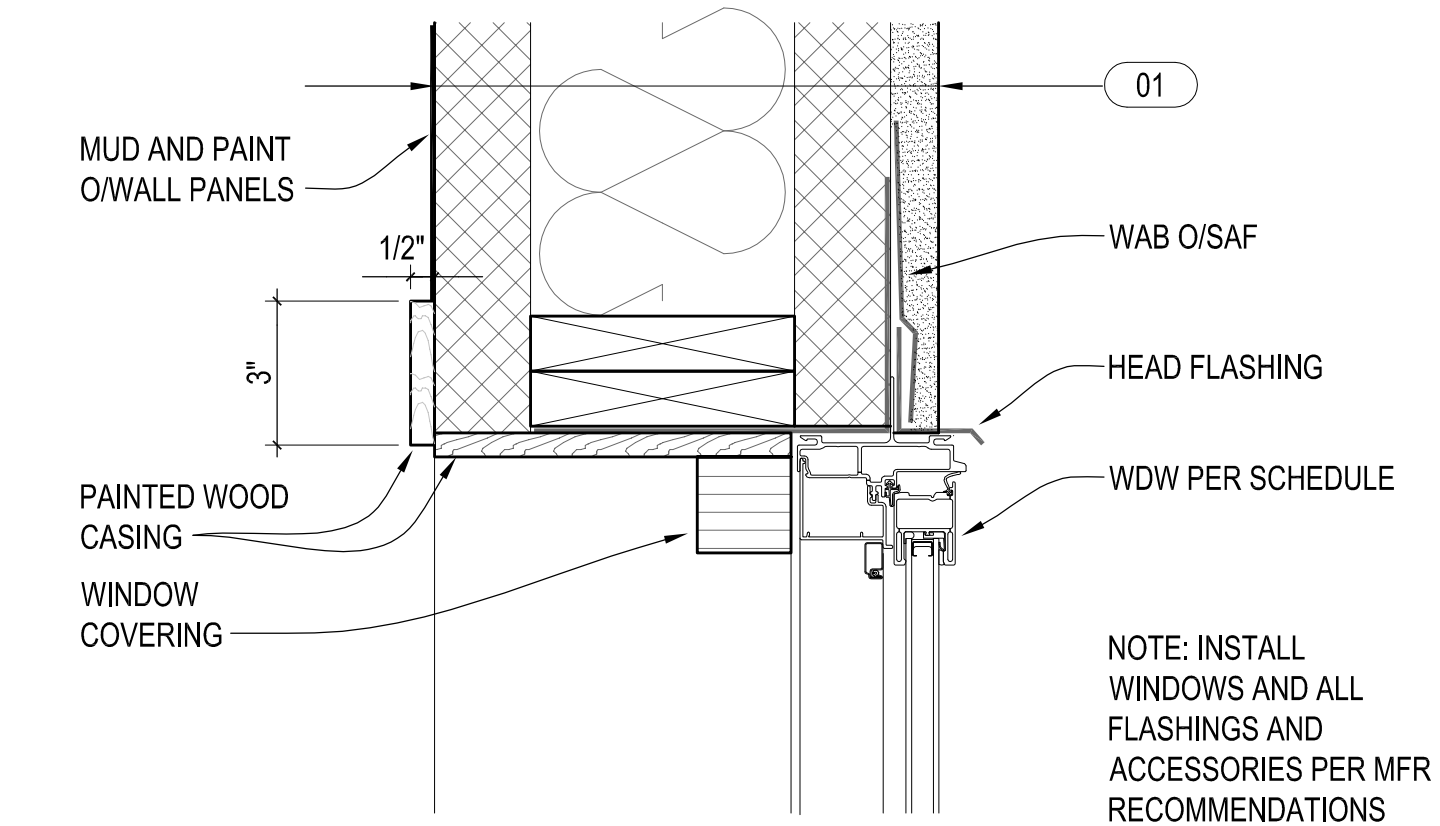


2  
A8.1  
3"=1'-0"

## TYPICAL WINDOW HEAD & JAMB

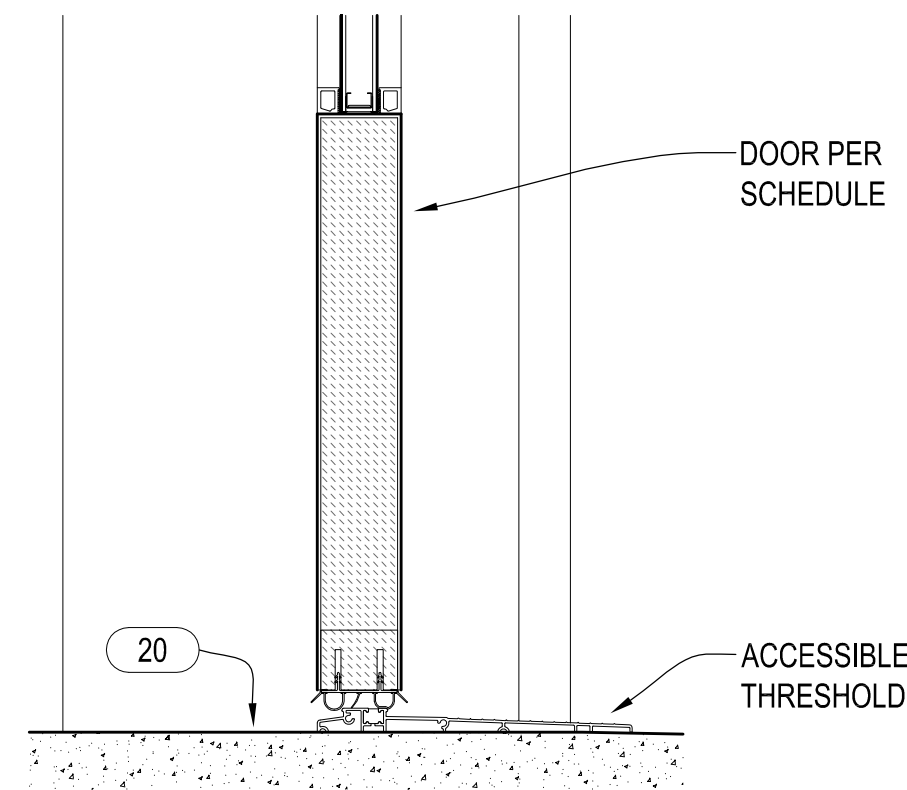

5  
A8.1  
3"=1'-0"

## DOOR THRESHOLD

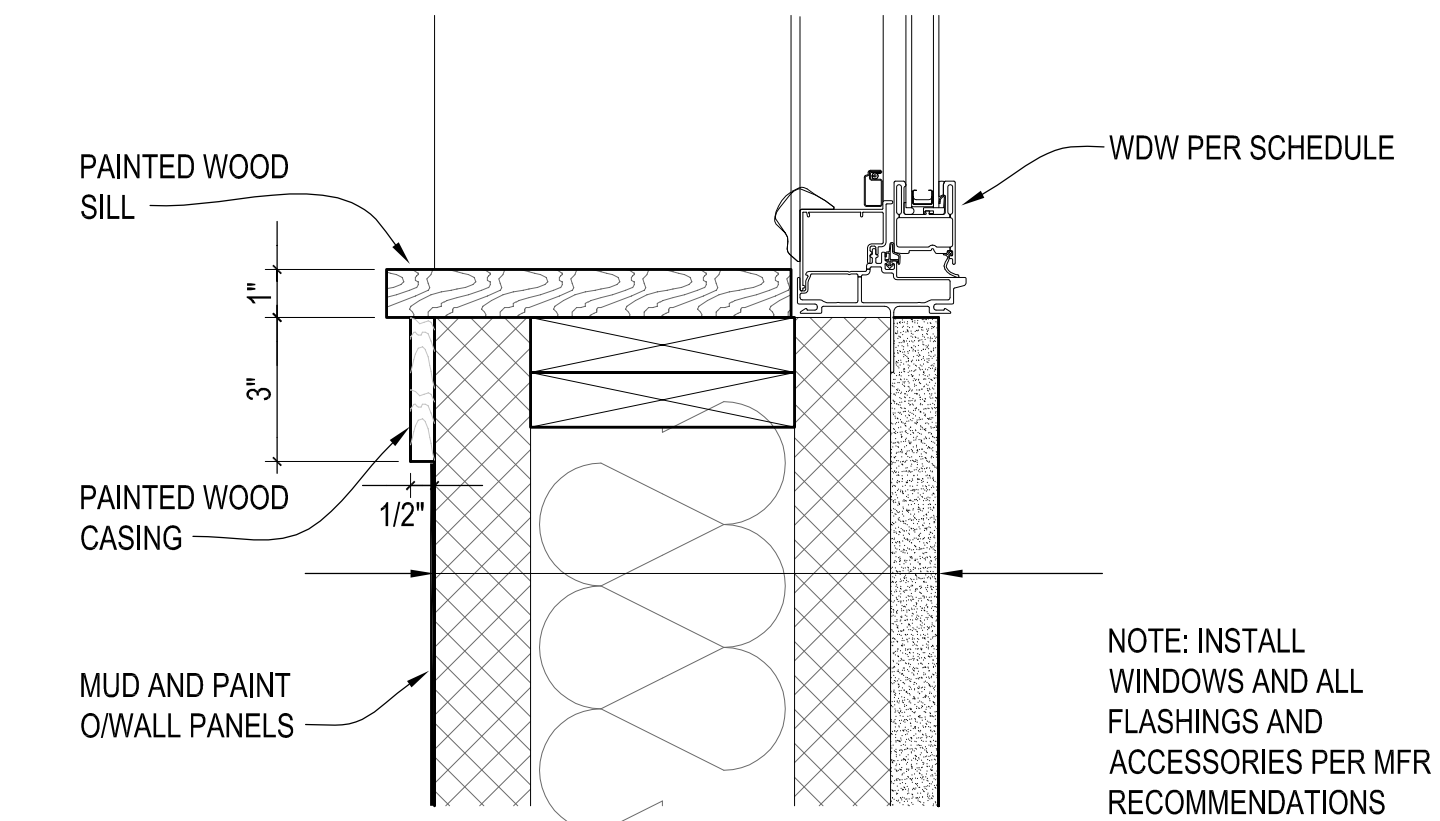


1  
A8.1  
3"=1'-0"

## TYPICAL WINDOW SILL



# Ojai Permanent Supportive Housing

611 South Montgomery Street, Ojai California

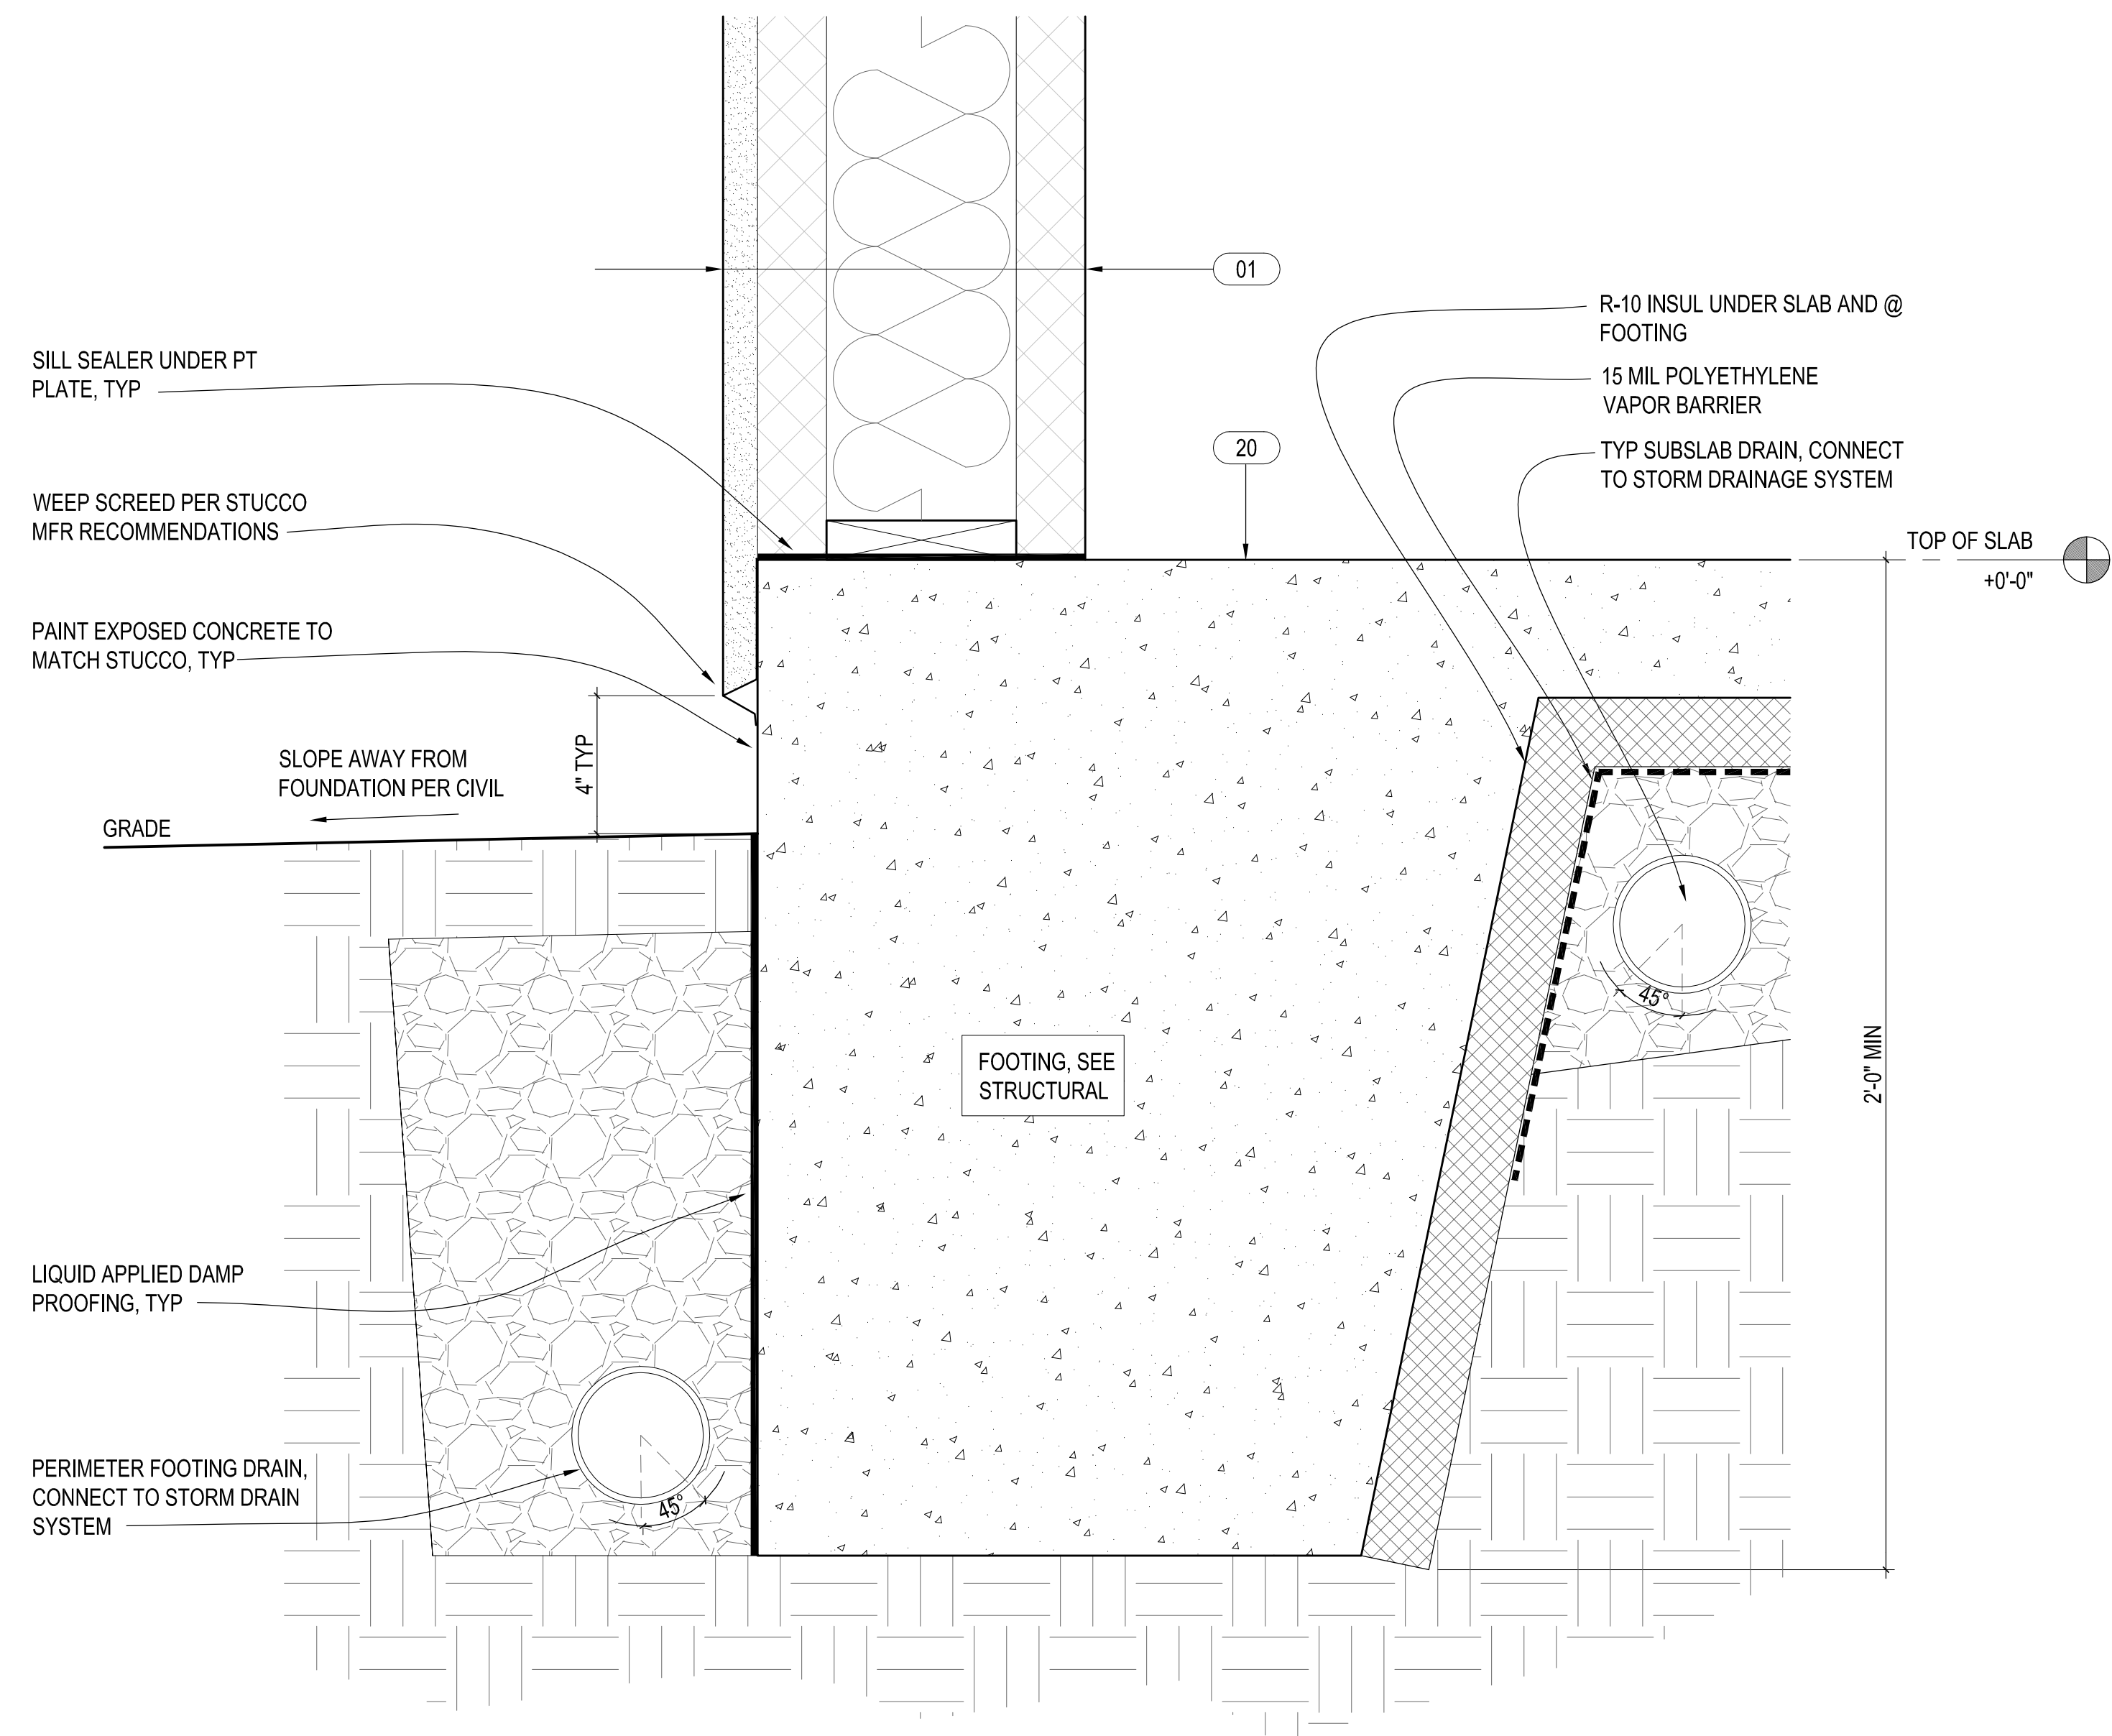

1  
A8.2  
3"=1'-0"

## TYPICAL FOOTING DETAIL

Drawn By:	DJ	
Checked By:		
Job No.	2407	
Revisions:		
No.	Date	E

NOT FOR CONSTRUCTION

25 July 2025

Design  
Development

Exterior  
Details  
**A8.2**



Ojai Permanent Supportive Housing

611 South Montgomery Street, Ojai California

Drawn By: DJ  
Checked By:  
Job No. 2407

Revisions:		
No.	Date	By


NOT FOR CONSTRUCTION

25 July 2025

Design  
Development


Interior  
Details

A9.1

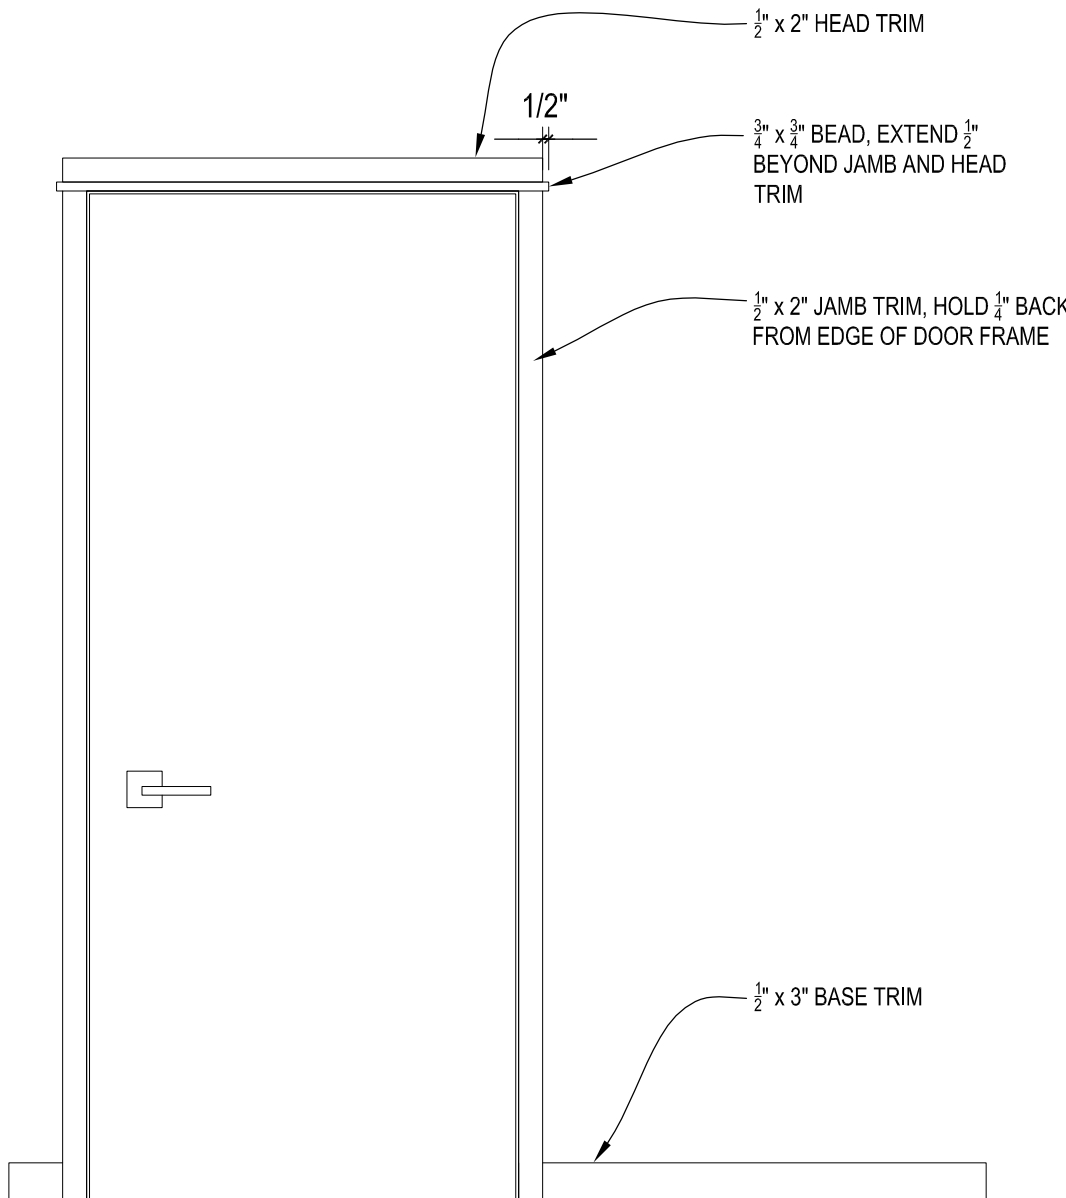


BASE AND DOOR TRIM

2  
A9.1  
1"=1'-0"

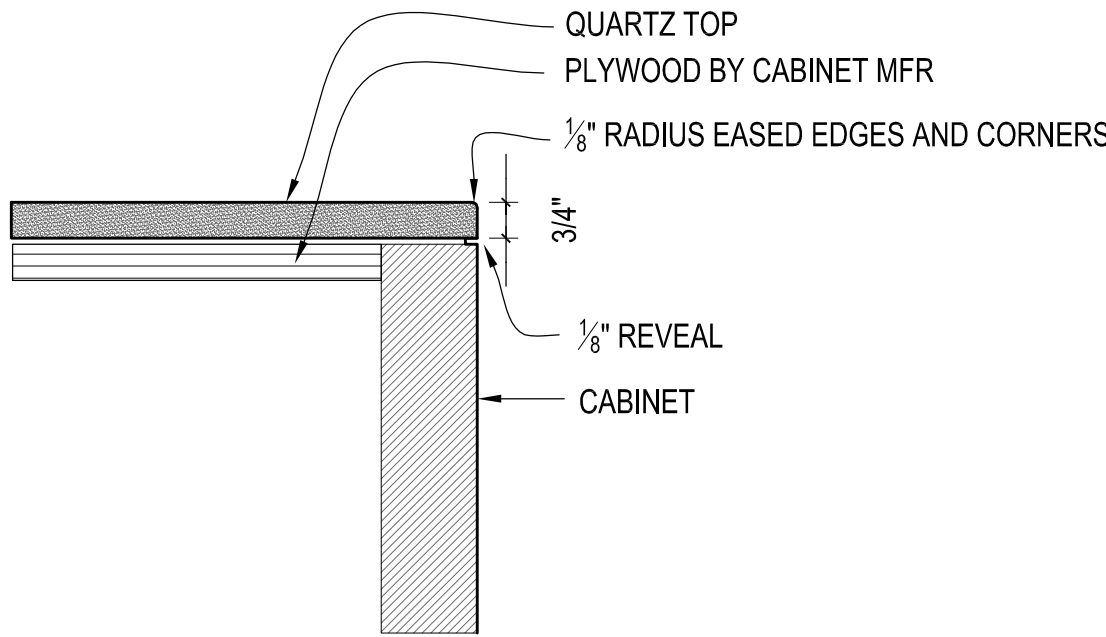

COUNTERTOP SIDE EDGE DETAIL

5  
A9.1  
3"=1'-0"

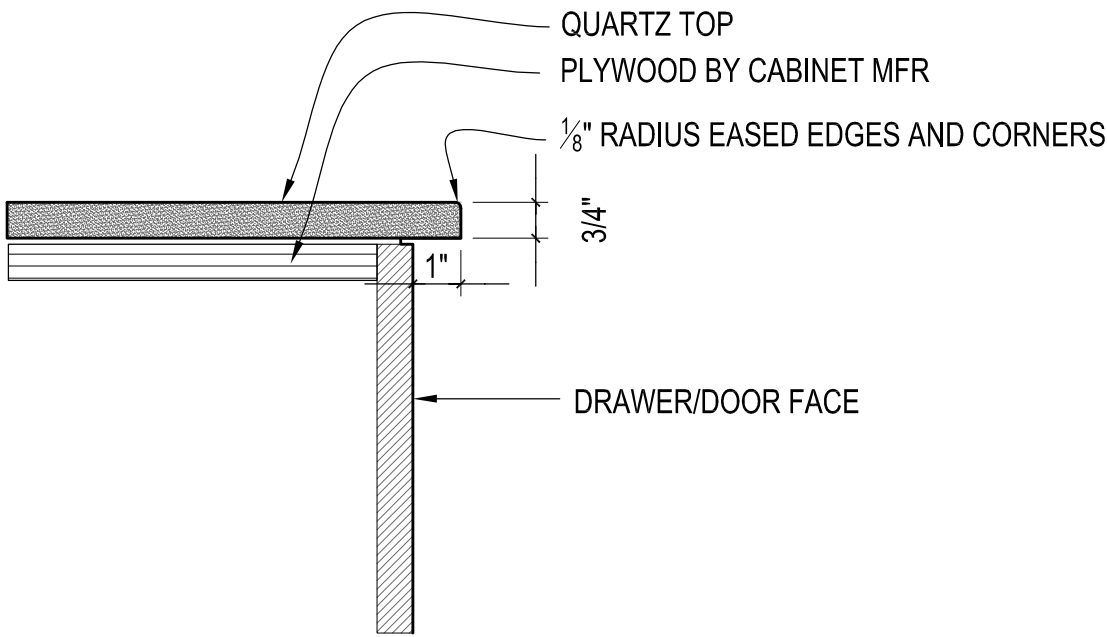

COUNTERTOP FRONT EDGE DETAIL

1  
A9.1  
3"=1'-0"



General Structural Notes

THE FOLLOWING APPLY UNLESS SHOWN OTHERWISE ON THE DRAWINGS

CRITERIA

1. ALL MATERIALS, WORKMANSHIP, DESIGN, AND CONSTRUCTION SHALL CONFORM TO THE DRAWINGS, SPECIFICATIONS, AND THE CALIFORNIA BUILDING CODE (2022 EDITION). THIS CONTRACT SHALL BE BID IN ACCORDANCE WITH THE CALIFORNIA PUBLIC CONTRACT CODE SECTIONS 22030-22045 AND OJAI MUNICIPAL CODE CHAPTER 8-4.

2. DESIGN LOADING CRITERIA:

RESIDENTIAL – HOTELS AND MULTIFAMILY DWELLINGS

FLOOR LIVE LOAD . . . . . 40 PSF

FLOOR LIVE LOAD (PRIVATE ROOMS AND CORRIDORS SERVING THEM) . . . 40 PSF

FLOOR LIVE LOAD (PUBLIC ROOMS AND CORRIDORS SERVING THEM) . . . 100 PSF

ROOF

ROOF LIVE LOAD . . . . . 25 PSF

MISCELLANEOUS LOADS

STAIR AND CORRIDOR LIVE LOAD (UNLESS OTHERWISE INDICATED) . . . 100 PSF

ACCESSORY STORAGE AREAS . . . . . 1.0 x AREA SERVED

MECHANICAL UNITS . . . . . WEIGHTS FURNISHED BY MANUFACTURER

PHOTOVOLTAIC PANEL SYSTEMS . . . . . 5 PSF

DEFLECTION CRITERIA

LIVE LOAD DEFLECTION . . . . . L/360

TOTAL LOAD DEFLECTION . . . . . L/240

ENVIRONMENTAL LOADS

RISK CATEGORY II

WIND . . . . . Gcpi=0.18, 93 MPH, EXPOSURE "B"

EARTHQUAKE:

ANALYSIS PROCEDURE: EQUIVALENT LATERAL FORCE PROCEDURE

LATERAL SYSTEM: LIGHT FRAMED SHEAR WALLS

SITE CLASS=D (DEFAULT), Ss=1.85, Sds=1.48, S1=0.70, Sd1=1.19, Cs=0.227, SDC D, Ie=1.0, R=6.5

SEE PLANS FOR ADDITIONAL LOADING CRITERIA
3. STRUCTURAL DRAWINGS SHALL BE USED IN CONJUNCTION WITH ARCHITECTURAL DRAWINGS FOR BIDDING AND CONSTRUCTION. ARCHITECTURAL DRAWINGS ARE THE PRIME CONTRACT DRAWINGS. ANY DISCREPANCIES FOUND AMONG THE DRAWINGS, THE SPECIFICATION, THESE GENERAL NOTES AND THE SITE CONDITIONS SHALL BE REPORTED TO THE ARCHITECT, WHO SHALL CORRECT SUCH DISCREPANCY IN WRITING. ANY WORK DONE BY THE GENERAL CONTRACTOR AFTER DISCOVERY OF SUCH DISCREPANCY SHALL BE DONE AT THE GENERAL CONTRACTOR'S RISK.

4. PRIMARY STRUCTURAL ELEMENTS NOT DIMENSIONED ON THE STRUCTURAL PLANS AND DETAILS SHALL BE LOCATED BY THE ARCHITECTURAL PLANS AND DETAILS. VERTICAL DIMENSION CONTROL IS DEFINED BY THE ARCHITECTURAL WALL SECTIONS, BUILDING SECTION, AND PLANS. DETAILING AND SHOP DRAWING PRODUCTION FOR STRUCTURAL ELEMENTS WILL REQUIRE DIMENSIONAL INFORMATION CONTAINED IN BOTH ARCHITECTURAL AND STRUCTURAL DRAWINGS.

5. CONTRACTOR SHALL BE RESPONSIBLE FOR ALL SAFETY PRECAUTIONS AND THE METHODS, TECHNIQUES, SEQUENCES OR PROCEDURES REQUIRED TO PERFORM THE CONTRACTORS WORK. THE STRUCTURAL ENGINEER HAS NO OVERALL SUPERVISORY AUTHORITY OR ACTUAL AND/OR DIRECT RESPONSIBILITY FOR THE SPECIFIC WORKING CONDITIONS AT THE SITE AND/OR FOR ANY HAZARDS RESULTING FROM THE ACTIONS OF ANY TRADE CONTRACTOR. THE STRUCTURAL ENGINEER HAS NO DUTY TO INSPECT, SUPERVISE, NOTE, CORRECT, OR REPORT ANY HEALTH OR SAFETY DEFICIENCIES TO THE OWNER, CONTRACTORS, OR OTHER ENTITIES OR PERSONS AT THE PROJECT SITE.

6. CONTRACTOR SHALL PROVIDE TEMPORARY BRACING FOR THE STRUCTURE AND STRUCTURAL COMPONENTS UNTIL ALL FINAL CONNECTIONS HAVE BEEN COMPLETED IN ACCORDANCE WITH THE PLANS. CONFORM TO ASCE 37-14 "DESIGN LOADS ON STRUCTURES DURING CONSTRUCTION".

7. CONTRACTOR-INITIATED CHANGES SHALL BE SUBMITTED IN WRITING TO THE ARCHITECT AND STRUCTURAL ENGINEER FOR APPROVAL PRIOR TO FABRICATION OR CONSTRUCTION. CHANGES SHOWN ON SHOP DRAWINGS ONLY WILL NOT SATISFY THIS REQUIREMENT.

8. DRAWINGS INDICATE GENERAL AND TYPICAL DETAILS OF CONSTRUCTION. WHERE CONDITIONS ARE NOT SPECIFICALLY INDICATED BUT OF SIMILAR CHARACTER TO DETAILS SHOWN, SIMILAR DETAILS OF CONSTRUCTION SHALL BE USED, SUBJECT TO REVIEW AND APPROVAL BY THE ARCHITECT AND THE STRUCTURAL ENGINEER. ALL TYPICAL NOTES AND DETAILS SHOWN ON DRAWINGS SHALL APPLY, UNLESS NOTED OTHERWISE. TYPICAL DETAILS MAY NOT NECESSARILY BE INDICATED ON THE PLANS BUT SHALL STILL APPLY AS SHOWN OR DESCRIBED IN THE DETAILS. WHERE TYPICAL DETAILS ARE NOTED ON THE PLANS, THE SPECIFIED TYPICAL DETAIL SHALL BE USED. WHERE NO TYPICAL DETAIL IS NOTED, IT SHALL BE THE CONTRACTOR'S RESPONSIBILITY TO CHOOSE THE APPROPRIATE TYPICAL DETAIL FROM THOSE PROVIDED OR REQUEST ADDITIONAL INFORMATION. THE CONTRACTOR SHALL SUBMIT ALL PROPOSED ALTERNATE TYPICAL DETAILS TO THOSE PROVIDED WITH RELATED CALCULATIONS TO THE ENGINEER FOR APPROVAL PRIOR TO SHOP DRAWING PRODUCTION AND FIELD USE.

9. ALL STRUCTURAL SYSTEMS, WHICH ARE TO BE COMPOSED OF COMPONENTS TO BE FIELD ERECTED, SHALL BE SUPERVISED BY THE SUPPLIER DURING MANUFACTURING, DELIVERY, HANDLING, STORAGE AND ERECTION IN ACCORDANCE WITH INSTRUCTIONS PREPARED BY THE SUPPLIER.

10. SHOP DRAWINGS FOR THE FOLLOWING ITEMS SHALL BE SUBMITTED TO THE ARCHITECT AND STRUCTURAL ENGINEER FOR REVIEW PRIOR TO FABRICATION OF THESE ITEMS.

CONNECTOR PLATE WOOD ROOF TRUSSES

PRE-FABRICATED ASSEMBLIES (INCLUDING PANELIZED SYSTEMS)

CONTRACTOR SHALL SUBMIT WALL ELEVATION DRAWINGS OF AT LEAST 1/8" = 1'-0" SCALE INDICATING LOCATIONS OF CONNECTION EMBEDMENT'S AND WALL OPENINGS FOR REVIEW PRIOR TO CONSTRUCTION. CONTRACTOR SHALL COORDINATE WALL ELEVATION DRAWINGS WITH REINFORCEMENT SHOP DRAWINGS.

APPROVED SETS OF ALL SHOP DRAWINGS SHALL ALSO BE SUBMITTED TO THE BUILDING DEPARTMENT WHERE REQUIRED.

11. SHOP DRAWING REVIEW: DIMENSIONS AND QUANTITIES ARE NOT REVIEWED BY THE ENGINEER OF RECORD, THEREFORE MUST BE VERIFIED BY THE CONTRACTOR. CONTRACTOR SHALL REVIEW AND STAMP DRAWINGS PRIOR TO REVIEW BY ENGINEER OF RECORD. CONTRACTOR SHALL REVIEW DRAWINGS FOR CONFORMANCE WITH THE MEANS, METHODS, TECHNIQUES, SEQUENCES AND OPERATIONS OF CONSTRUCTION, AND ALL SAFETY PRECAUTIONS AND PROGRAMS INCIDENTAL THERETO. SUBMITTALS SHALL INCLUDE A REPRODUCIBLE AND ONE COPY; REPRODUCIBLE WILL BE MARKED AND RETURNED WITHIN TWO WEEKS OF RECEIPT WITH A NOTATION INDICATING THAT THE SUBMITTAL HAS BEEN FOUND TO BE IN GENERAL CONFORMANCE WITH THE DESIGN OF THE BUILDING. THE SUBMITTED ITEMS SHALL NOT BE INSTALLED UNTIL THEY HAVE BEEN APPROVED BY THE BUILDING OFFICIAL.

SHOP DRAWING SUBMITTALS PROCESSED BY THE ENGINEER ARE NOT CHANGE ORDERS. THE PURPOSE OF SHOP DRAWING SUBMITTALS BY THE CONTRACTOR IS TO DEMONSTRATE TO THE ENGINEER THAT THE CONTRACTOR UNDERSTANDS THE DESIGN CONCEPT, BY INDICATING WHICH MATERIAL IS INTENDED TO BE FURNISHED AND INSTALLED AND BY DETAILING THE INTENDED FABRICATION AND INSTALLATION METHODS. IF DEVIATIONS, DISCREPANCIES, OR CONFLICTS BETWEEN SHOP DRAWING SUBMITTALS AND THE CONTRACT DOCUMENTS ARE DISCOVERED EITHER PRIOR TO OR AFTER SHOP DRAWING SUBMITTALS ARE PROCESSED BY THE ENGINEER, THE DESIGN DRAWINGS AND SPECIFICATIONS SHALL CONTROL AND SHALL BE FOLLOWED.
12. EXTERIOR CLADDING PANELS AND CONNECTIONS SHALL BE DESIGNED BY THE MANUFACTURER FOR LOADING PRESCRIBED BY THE APPLICABLE BUILDING CODE IN ADDITION TO THE LOADS CONDITIONS SHOWN ON THE PLANS. MANUFACTURER SHALL SUBMIT DETAIL DRAWINGS AND CALCULATIONS STAMPED AND SIGNED BY A STRUCTURAL ENGINEER LICENSED IN THE STATE OF WASHINGTON. THE MANUFACTURER'S ENGINEER SHALL BE RESPONSIBLE FOR DESIGN, CODE CONFORMANCE, AND CONNECTION OF EXTERIOR CLADDING PANELS TO BASIC STRUCTURE. ENGINEER OF RECORD TAKES NO RESPONSIBILITY FOR PRODUCT DESIGN, MANUFACTURE, DELIVERY AND HANDLING, OR CONNECTION TO BASIC STRUCTURE. SHOP DRAWINGS SHALL BEAR THE REVIEW STAMP OF THE DESIGNING ENGINEER'S FIRM PRIOR TO REVIEW BY THE ENGINEER OF RECORD. SHOP DRAWINGS SHALL INDICATE MAGNITUDE AND DIRECTION OF ALL LOADS IMPOSED ON BASIC STRUCTURE. ALL NECESSARY BRACING, TIES, ANCHORAGE, DISTRIBUTION MEMBERS, AND SIMILAR ELEMENTS SHALL BE FURNISHED AND INSTALLED IN CONFORMANCE WITH SUBMITTED DRAWINGS AND CALCULATIONS.

13. DEFERRED SUBMITTALS: SHOP DRAWINGS AND CALCULATIONS OF DEFERRED SUBMITTAL COMPONENTS SHALL BE STAMPED AND SIGNED BY A STRUCTURAL ENGINEER LICENSED IN THE STATE OF WASHINGTON AND SHALL BE APPROVED BY THE SPECIALTY STRUCUTRAL ENGINEER (SSE) PRIOR TO REVIEW BY THE ARCHITECT AND ENGINEER FOR GENERAL CONFORMANCE and COMPATIBILITY WITH THE PRIMARY STRUCTURE. ALL NECESSARY CONNECTIONS NOT SPECIFICALLY CALLED OUT ON THE ARCHITECTURAL OR STRUCTURAL DRAWINGS SHALL BE INCLUDED. SHOP DRAWINGS SHALL INCLUDE THE MAGNITUDE AND DIRECTION OF ALL LOADS IMPOSED ON THE BASIC STRUCTURE. DESIGN CALCULATIONS SHALL ACCOMPANY ALL DEFERRED SUBMITTALS. THE ARCHITECT OR CONTRACTOR SHALL FORWARD DEFERRED SUBMITTALS TO THE BUILDING OFFICIAL WHERE REQUIRED.

DEFERRED SUBMITTAL BUILDING COMPONENTS FOR THIS PROJECT SHALL INCLUDE:

EXTERIOR WALL OR CLADDING PANELS

PREFABRICATED CONNECTOR PLATE WOOD TRUSSES – TEMPORARY AND PERMANENT BRACING
- QUALITY ASSURANCE

14. SPECIAL INSPECTION SHALL BE PROVIDED IN ACCORDANCE WITH THE PROJECT SPECIFICATIONS AND SECTIONS 110 AND 1705 OF THE INTERNATIONAL BUILDING CODE BY A QUALIFIED TESTING AGENCY DESIGNATED BY THE ARCHITECT, AND RETAINED BY THE BUILDING OWNER. THE ARCHITECT, STRUCTURAL ENGINEER, AND BUILDING DEPARTMENT SHALL BE FURNISHED WITH COPIES OF ALL INSPECTION AND TEST RESULTS. SPECIAL INSPECTION OF THE FOLLOWING TYPES OF CONSTRUCTION IS REQUIRED UNLESS NOTED OTHERWISE.

CONCRETE CONSTRUCTION . . . . . PER TABLE 1705.3

WOOD TRUSSES GREATER THAN 5' DEEP OR 60' LONG . . . . . PER 1705.5.2

SOIL CONDITIONS, FILL PLACEMENT, AND DENSITY . . . . . PER TABLE 1705.6

EXPANSION BOLTS AND THREADED EXPANSION INSERTS . . . . . PER MANUFACTURER

EPOXY GROUTED INSTALLATIONS . . . . . PER MANUFACTURER

PERIODIC INSPECTION: INSPECTION SHALL BE PERFORMED AT INTERVALS NECESSARY TO CONFIRM THAT WORK REQUIRING SPECIAL INSPECTION IS IN COMPLIANCE WITH REQUIREMENTS.

CONTINUOUS INSPECTION: INSPECTOR SHALL BE ONSITE AND OBSERVE THE WORK REQUIRING INSPECTION AT ALL TIMES THAT WORK IS PERFORMED.

15. UNLESS OTHERWISE NOTED, THE FOLLOWING ELEMENTS COMPRISE THE SEISMIC-FORCE-RESISTING SYSTEM AND ARE SUBJECT TO SPECIAL INSPECTION FOR SEISMIC RESISTANCE IN ACCORDANCE WITH SECTION 1705.13 OF THE INTERNATIONAL BUILDING CODE.

A. STRUCTURAL WOOD SHEAR WALL SYSTEMS REQUIRE PERIODIC INSPECTION FOR FIELD GLUING, NAILING, BOLTING, ANCHORING AND OTHER FASTENING OF COMPONENTS WITHIN THE SEISMIC FORCE, RESISTING SYSTEM INCLUDING SHEAR WALLS, DIAPHRAGMS, DRAG STRUTS, BRACES AND HOLDOWNS.
16. STRUCTURAL OBSERVATION SHALL BE PERFORMED IN ACCORDANCE WITH SECTIONS 1704.6 OF THE INTERNATIONAL BUILDING CODE FOR THE FOLLOWING BUILDING ELEMENTS:

LIGHT FRAMED SHEAR WALLS

HOLDOWNS

THE CONTRACTOR SHALL PROVIDE THE ENGINEER OF RECORD ADEQUATE NOTICE TO SCHEDULE APPROPRIATE SITE VISITS FOR STRUCTURAL OBSERVATION.

STRUCTURAL OBSERVATION MEANS THE VISUAL OBSERVATION OF THE STRUCTURAL SYSTEM, FOR GENERAL CONFORMANCE TO THE APPROVED PLANS AND SPECIFICATIONS, AT SIGNIFICANT CONSTRUCTION STAGES AND AT COMPLETION OF THE STRUCTURAL SYSTEM. STRUCTURAL OBSERVATION DOES NOT INCLUDE OR WAIVE THE RESPONSIBILITY FOR THE INSPECTIONS REQUIRED BY SECTION 110, 1705, OR OTHER SECTIONS OF THE INTERNATIONAL BUILDING CODE.

THE OWNER SHALL EMPLOY THE ENGINEER OR ARCHITECT RESPONSIBLE FOR THE STRUCTURAL DESIGN, TO PERFORM STRUCTURAL OBSERVATION. OBSERVED DEFICIENCIES SHALL BE REPORTED IN WRITING TO THE OWNER'S REPRESENTATIVE, SPECIAL INSPECTOR, CONTRACTOR, AND THE BUILDING OFFICIAL. THE STRUCTURAL OBSERVER SHALL SUBMIT TO THE BUILDING OFFICIAL A WRITTEN STATEMENT THAT THE SITE VISITS HAVE BEEN MADE AND IDENTIFYING ANY REPORTED DEFICIENCIES WHICH, TO THE BEST OF THE STRUCTURAL OBSERVER'S KNOWLEDGE, HAVE NOT BEEN RESOLVED.
17. FOUNDATION NOTES: ALLOWABLE SOIL PRESSURE AND LATERAL EARTH PRESSURE ARE ASSUMED AND THEREFORE MUST BE VERIFIED BY A QUALIFIED SOILS ENGINEER OR APPROVED BY THE BUILDING OFFICIAL. IF SOILS ARE FOUND TO BE OTHER THAN ASSUMED, NOTIFY THE STRUCTURAL ENGINEER FOR POSSIBLE FOUNDATION REDESIGN.

FOOTINGS SHALL BEAR ON FIRM, UNDISTURBED EARTH AT LEAST 18" BELOW ADJACENT FINISHED GRADE, UNLESS OTHERWISE NOTED, FOOTINGS SHALL BE CENTERED BELOW COLUMNS OR WALLS ABOVE.

BACKFILL BEHIND ALL RETAINING WALLS WITH FREE DRAINING, GRANULAR FILL AND PROVIDE FOR SUBSURFACE DRAINAGE.

ALLOWABLE SOIL PRESSURE: . . . . . 1500 PSF
- RENOVATION

18. DEMOLITION: CONTRACTOR SHALL VERIFY ALL EXISTING CONDITIONS BEFORE COMMENCING ANY DEMOLITION. SHORING SHALL BE INSTALLED TO SUPPORT EXISTING CONSTRUCTION AS REQUIRED IN A MANNER SUITABLE TO THE WORK SEQUENCES. DEMOLITION DEBRIS SHALL NOT BE ALLOWED TO DAMAGE OR OVERLOAD THE EXISTING STRUCTURE. LIMIT CONSTRUCTION LOADING (INCLUDING DEMOLITION DEBRIS) ON EXISTING FLOOR SYSTEMS TO 40 PSF.

19. CONTRACTOR SHALL VERIFY ALL EXISTING DIMENSIONS, MEMBER SIZES, AND CONDITIONS PRIOR TO COMMENCING ANY WORK. ALL DIMENSIONS OF EXISTING CONSTRUCTION SHOWN ON THE DRAWINGS ARE INTENDED AS GUIDELINES ONLY AND MUST BE VERIFIED. THE CONTRACTOR SHALL NOTIFY THE ARCHITECT AND STRUCTURAL ENGINEER IF EXISTING CONDITIONS DETERMINED DURING WORK VARY FROM THE EXISTING CONSTRUCTION SHOWN ON THE DRAWINGS.

20. CONTRACTOR SHALL CHECK FOR DRY ROT AT ALL AREAS OF NEW WORK. ALL ROT SHALL BE REMOVED AND DAMAGED MEMBERS SHALL BE REPLACED OR REPAIRED AS DIRECTED BY THE STRUCTURAL ENGINEER OR ARCHITECT.
- CONCRETE

21. CONCRETE SHALL BE MIXED, PROPORTIONED, CONVEYED AND PLACED IN ACCORDANCE WITH ACI 301, INCLUDING TESTING PROCEDURES. CONCRETE SHALL ATTAIN A 28-DAY STRENGTH OF f'c = 3,000 PSI AND MIX SHALL CONTAIN NOT LESS THAN 5-1/2 SACKS OF CEMENT PER CUBIC YARD AND SHALL BE PROPORTIONED TO PRODUCE A SLUMP OF 5" OR LESS. REQUIRED CONCRETE STRENGTH IS BASED ON THE DURABILITY REQUIREMENTS OF SECTION 1904 OF THE IBC. DESIGN STRENGTH IS f'c = 2,500 PSI.

22. ALL CONCRETE WITH SURFACES EXPOSED TO WEATHER OR STANDING WATER SHALL BE AIR-ENTRAINED WITH AN AIR-ENTRAINING AGENT CONFORMING TO ASTM C260, C494, AND C618. TOTAL AIR CONTENT FOR FROST-RESISTANT CONCRETE SHALL BE IN ACCORDANCE WITH ACI 318-19, TABLE 19.3.2.1 MODERATE EXPOSURE, F1.

23. REINFORCING STEEL SHALL CONFORM TO ASTM A615 (INCLUDING SUPPLEMENT S1), GRADE 60, FY = 60,000 PSI.

24. DETAILING OF REINFORCING STEEL (INCLUDING HOOKS AND BENDS) SHALL BE IN ACCORDANCE WITH ACI 318R-18 AND 318-19. LAP ALL REINFORCEMENTS IN ACCORDANCE WITH "THE REINFORCING SPLICE AND DEVELOPMENT LENGTH SCHEDULE." PROVIDE CORNER BARS AT ALL WALL AND FOOTING INTERSECTIONS. LAP ADJACENT MATS OF WELDED WIRE FABRIC A MINIMUM OF 8" AT SIDES AND ENDS.

NO BARS PARTIALLY EMBEDDED IN HARDENED CONCRETE SHALL BE FIELD BENT UNLESS SPECIFICALLY SO DETAILED OR APPROVED BY THE STRUCTURAL ENGINEER.

25. CONCRETE PROTECTION (COVER) FOR REINFORCING STEEL SHALL BE AS FOLLOWS:

FOOTINGS AND OTHER UNFORMED SURFACES CAST AGAINST AND PERMANENTLY EXPOSED TO EARTH . . . . . 3"

FORMED SURFACES EXPOSED TO EARTH OR WEATHER (#6 BARS OR LARGER) . . . . 2"

FORMED SURFACES EXPOSED TO EARTH OR WEATHER (#5 BARS OR SMALLER) . . 1-1/2"

COLUMN TIES OR SPIRALS AND BEAM STIRRUPS. . . . . 1-1/2"

SLABS AND WALLS (INT. FACE). . . GREATER OF BAR DIAMETER PLUS 1/8" OR 3/4"

26. CONCRETE WALL REINFORCING—PROVIDE THE FOLLOWING UNLESS DETAILED OTHERWISE:

6" WALLS #4 @ 16 HORIZ. #4 @ 18 VERTICAL 1 CURTAIN

8" WALLS #4 @ 12 HORIZ. #4 @ 18 VERTICAL 1 CURTAIN

10" WALLS #4 @ 18 HORIZ. #4 @ 18 VERTICAL 2 CURTAINS

12" WALLS #4 @ 16 HORIZ. #4 @ 18 VERTICAL 2 CURTAINS
27. CAST-IN-PLACE CONCRETE: SEE ARCHITECTURAL DRAWINGS FOR EXACT LOCATIONS AND DIMENSIONS OF DOOR AND WINDOW OPENINGS IN ALL CONCRETE WALLS. SEE MECHANICAL DRAWINGS FOR SIZE AND LOCATION OF MISCELLANEOUS MECHANICAL OPENINGS THROUGH CONCRETE WALLS. SEE ARCHITECTURAL DRAWINGS FOR ALL GROOVES, NOTCHES, CHAMFERS, FEATURE STRIPS, COLOR, TEXTURE, AND OTHER FINISH DETAILS AT ALL EXPOSED CONCRETE SURFACES, BOTH CAST-IN-PLACE AND PRECAST.

ANCHORAGE

28. EXPANSION BOLTS INTO CONCRETE SHALL BE "STRONG-BOLT 2" WEDGE ANCHORS AS MANUFACTURED BY THE SIMPSON STRONG TIE COMPANY AND INSTALLED IN STRICT CONFORMANCE TO ICC-ES REPORT NUMBER ESR-3037 FOR CONCRETE AND IAPMO ER-240 FO MASONRY, INCLUDING MINIMUM EMBEDMENT REQUIREMENTS. BOLTS INTO CONCRETE MASONRY OR BRICK MASONRY UNITS SHALL BE INTO FULLY GROUTED CELLS. PERIODIC SPECIAL INSPECTION IS REQUIRED TO VERIFY ANCHOR TYPE, ANCHOR DIMENSIONS, ANCHOR LOCATION, TIGHTENING TORQUE, HOLE DIMENSIONS, ANCHOR EMBEDMENT, AND ADHERENCE TO THE INSTALLATION INSTRUCTIONS.

29. EPOXY-GROUTED ITEMS (THREADED RODS OR REINFORCING BAR) INTO CONCRETE SPECIFIED ON THE DRAWINGS SHALL BE INSTALLED USING "SET-3G" HIGH STRENGTH EPOXY AS MANUFACTURED BY THE SIMPSON STRONG, TIE COMPANY. INSTALL IN STRICT ACCORDANCE WITH ICC-ES REPORT NO. ESR-4057. MINIMUM BASE MATERIAL TEMPERATURE IS 40 DEGREES, F. RODS SHALL BE ASTM A-36 UNLESS OTHERWISE NOTED. PERIODIC SPECIAL INSPECTION OF INSTALLATION IS REQUIRED TO VERIFY ANCHOR OR EMBEDDED BAR TYPE AND DIMENSIONS, LOCATION, ADHESIVE IDENTIFICATION AND EXPIRATION, HOLE DIMENSIONS, HOLE CLEANING PROCEDURE, ANCHOR EMBEDMENT, AND ADHERENCE TO THE INSTALLATION INSTRUCTIONS. CONTINUOUS SPECIAL INSPECTION IS REQUIRED FOR HORIZONTAL AND OVERHEAD INSTALLATIONS.

30. CONCRETE SCREW ANCHORS INTO CONCRETE AND CONCRETE MASONRY UNITS SHALL BE "TITEN HD" SCREW ANCHOR AS MANUFACTURED BY THE SIMPSON STRONG-TIE COMPANY, INSTALLED IN STRICT ACCORDANCE WITH ICC-ES REPORT NO. ESR-2713 (CONCRETE), NO. ESR-1056 (CMU), INCLUDING MINIMUM EMBEDMENT REQUIREMENTS. SCREW ANCHORS INTO CONCRETE MASONRY UNITS SHALL BE INTO FULLY GROUTED CELLS. SPECIAL INSPECTION IS REQUIRED.

31. FRAMING LUMBER SHALL BE S-DRY, KD, OR MC-19, AND GRADED AND MARKED IN CONFORMANCE WITH NCLIB STANDARD No. 17, GRADING RULES FOR WEST COAST LUMBER, 2018, OR WMA STANDARD, WESTERN LUMBER GRADING RULES 2021. FURNISH TO THE FOLLOWING MINIMUM STANDARDS:

JOISTS (2X & 3X MEMBERS) HEM-FIR NO. 2

AND BEAMS MINIMUM BASE VALUE, Fb = 850 PSI

(4X MEMBERS) DOUGLAS FIR-LARCH NO. 1

MINIMUM BASE VALUE, Fb = 1000 PSI

BEAMS (INCL. 6X AND LARGER) DOUGLAS FIR-LARCH NO. 1

MINIMUM BASE VALUE, Fb = 1350 PSI

POSTS (4X MEMBERS) DOUGLAS FIR-LARCH NO. 2

MINIMUM BASE VALUE, Fc = 1350 PSI

(6X AND LARGER) DOUGLAS FIR-LARCH NO. 1

MINIMUM BASE VALUE, Fc = 1000 PSI

STUDS, PLATES & MISC. FRAMING: DOUGLAS FIR-LARCH NO. 2

OR HEM-FIR NO. 2

32. GLUED LAMINATED MEMBERS SHALL BE FABRICATED IN CONFORMANCE WITH ASTM AND ANSI/AITC STANDARDS. EACH MEMBER SHALL BEAR AN AITC OR APA IDENTIFICATION MARK AND SHALL BE ACCOMPANIED BY AN AITC OR APA CERTIFICATE OF CONFORMANCE. ALL SIMPLE SPAN BEAMS SHALL BE DOUGLAS FIR COMBINATION 24F-V4, Fb = 2,400 PSI, Fv = 265 PSI. ALL CANTILEVERED BEAMS SHALL BE DOUGLAS FIR COMBINATION 24F-V8, Fb = 2400 PSI, Fv = 265 PSI. CAMBER ALL SIMPLE SPAN GLULAM BEAMS, WITH SPANS OVER 30', TO 3,500' RADIUS, UNLESS SHOWN OTHERWISE ON THE PLANS.

33. PREFABRICATED CONNECTOR PLATE WOOD TRUSSES SHALL BE DESIGNED BY THE MANUFACTURER IN ACCORDANCE WITH THE "NATIONAL DESIGN STANDARD FOR METAL PLATE-CONNECTED WOOD TRUSS CONSTRUCTION, ANSI/TPI-1" BY THE TRUSS PLATE INSTITUTE FOR THE SPANS AND CONDITIONS SHOWN ON THE PLANS. LOADING SHALL BE AS FOLLOWS:

ROOF

TOP CHORD LIVE LOAD 25 PSF

TOP CHORD DEAD LOAD 40 PSF

BOTTOM CHORD DEAD LOAD 10 PSF

TOTAL LOAD 50 PSF

WIND UPLIFT (TOP CHORD) 5 PSF

BOTTOM CHORD LIVE LOAD 10 PSF

(BOTTOM CHORD LIVE LOAD DOES NOT ACT CONCURRENTLY WITH THE ROOF OR FLOOR LIVE LOAD)

WOOD TRUSSES SHALL UTILIZE APPROVED CONNECTOR PLATES (MITEK OR EQUAL). SUBMIT SHOP DRAWINGS INCLUDING TRUSS PLACEMENT DIAGRAM AND DESIGN CALCULATIONS TO THE ARCHITECT AND STRUCTURAL ENGINEER FOR REVIEW PRIOR TO FABRICATION. SUBMITTED DOCUMENTS SHALL BE SIGNED AND STAMPED BY A STRUCTURAL ENGINEER REGISTERED IN THE STATE OF WASHINGTON. PROVIDE FOR SHAPES, BEARING POINTS, INTERSECTIONS, HIPS, VALLEYS, ETC., SHOWN ON THE DRAWINGS. EXACT COMPOSITION OF SPECIAL HIP, VALLEY, AND INTERSECTION AREAS (USE OF GIRDER TRUSSES, JACK TRUSSES, STEP-DOWN TRUSSES, ETC.) SHALL BE DETERMINED BY THE MANUFACTURER UNLESS SPECIFICALLY INDICATED ON THE PLANS. PROVIDE ALL TRUSS TO TRUSS AND TRUSS TO GIRDER TRUSS CONNECTION DETAILS AND REQUIRED CONNECTION MATERIALS.

TEMPORARY AND PERMANENT RESTRAINT/BRACING SHALL BE IN ACCORDANCE WITH BCSI-B3 AND BCSI-B7.

TEMPORARY AND PERMANENT RESTRAINT/BRACING SHALL BE A PROJECT SPECIFIC DESIGN PER 2.3.3.1.3 OF ANSI/TPI-1 AND SHALL BE PREPARED BY AN INDEPENDENT REGISTERED DESIGN PROFESIONAL LICENCED IN THE STATE OF WASHINGTON. RESTRAINT/BRACING DESIGN SHALL BE A DEFERRED SUBMITTAL.

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DJA Architects

ISSUE:

Design Development

SHEET TITLE:

General  
Structural  
Notes

SCALE:

DATE:

25 July, 2025

PROJECT NO:

02061-2025-01

SHEET NO:

S1.1



General Structural Notes

THE FOLLOWING APPLY UNLESS SHOWN OTHERWISE ON THE DRAWINGS

34. PLYWOOD SHEATHING SHALL BE EXPOSURE 1, PANEL GRADE C-D, AND EITHER SHEATHING, SINGLE-FLOOR, OR STRUCTURAL I GRADE IN CONFORMANCE WITH DOC PS 1 AND PS 2. ORIENTED STRAND BOARD OF EQUIVALENT THICKNESS, EXPOSURE RATING AND PANEL INDEX MAY BE USED IN LIEU OF PLYWOOD.

ROOF SHEATHING SHALL BE 1/2" (NOMINAL) WITH SPAN RATING 32/16.

FLOOR SHEATHING SHALL BE 3/4" (NOMINAL) WITH SPAN RATING 48/24.

WALL SHEATHING SHALL BE 1/2" (NOMINAL) WITH SPAN RATING 24/0.

PROVIDE APPROVED PLYWOOD EDGE CLIPS CENTERED BETWEEN JOISTS/TRUSSES AT UNBLOCKED ROOF SHEATHING EDGES. ALL FLOOR SHEATHING EDGES SHALL HAVE APPROVED T&G JOINTS OR SHALL BE SUPPORTED WITH SOLID BLOCKING. ALLOW 1/8" SPACING AT ALL PANEL EDGES AND ENDS OF FLOOR AND ROOF SHEATHING.

REFER TO WOOD FRAMING NOTES BELOW FOR TYPICAL NAILING REQUIREMENTS.

35. ALL WOOD IN DIRECT CONTACT WITH CONCRETE OR MASONRY SHALL BE PRESSURE-TREATED WITH AN APPROVED PRESERVATIVE OR (2) LAYERS OF ASPHALT IMPREGNATED BUILDING PAPER SHALL BE PROVIDED BETWEEN UNTREATED WOOD AND CONCRETE OR MASONRY.

36. PRESERVATIVE TREATED WOOD SHALL BE TREATED PER AWWA STANDARD U1-20 TO THE USE CATEGORY EQUAL TO OR HIGHER THAN THE INTENDED APPLICATION. TREATED WOOD FOR ABOVE GROUND USE SHALL BE TREATED TO AWWA UC3B. WOOD IN CONTINUOUS CONTACT WITH FRESH WATER OR SOIL SHALL BE TREATED TO AWWA UC4A. WOOD FOR USE IN PERMANENT FOUNDATIONS SHALL BE TREATED TO AWWA UC4B.

37. WOOD TREATED FOR FIRE RESISTANCE SHALL MEET THE REQUIREMENTS OF ASTM E84 OR UL 723 AND HAVE A LISTED FLAME SPREAD INDEX OF 25 OR LESS. FIRE RETARDANT TREATED LUMBER AND WOOD STRUCTURAL PANELS SHALL BE LABELED IN ACCORDANCE WITH IBC 2303.2.4. WOOD TREATED FOR FIRE PROTECTION FOR USE IN INTERIOR ABOVE GROUND CONSTRUCTION AND CONTINUOUSLY PROTECTED FROM WEATHER AND OTHER SOURCES OF MOISTURE SHALL BE TREATED TO AWWA U1-20, UCFA. WOOD TREATED FOR FIRE PROTECTION FOR USE IN EXTERIOR ABOVE GROUND CONSTRUCTION AND SUBJECT TO WETTING OR OTHER SOURCES OF MOISTURE SHALL BE TREATED TO AWWA U1-20, UCFB.

38. FASTENERS AND TIMBER CONNECTORS USED WITH TREATED WOOD SHALL HAVE CORROSION RESISTANCE AS INDICATED IN THE FOLLOWING TABLE, UNLESS OTHERWISE NOTED.

WOOD TREATMENT	CONDITION	PROTECTION
HAS NO AMMONIA CARRIER	INTERIOR DRY	G90 GALVANIZED
CONTAINS AMMONIA CARRIER	INTERIOR DRY	G185 OR A185 HOT DIPPED OR CONTINUOUS HOT-GALVANIZED PER ASTM A653
CONTAINS AMMONIA CARRIER	INTERIOR WET	TYPE 304 OR 316 STAINLESS
CONTAINS AMMONIA CARRIER	EXTERIOR	TYPE 304 OR 316 STAINLESS
AZCA	ANY	TYPE 304 OR 316 STAINLESS

INTERIOR DRY CONDITIONS SHALL HAVE WOOD MOISTURE CONTENT LESS THAN 19%. WOOD MOISTURE CONTENT IN OTHER CONDITIONS (INTERIOR WET, EXTERIOR WET, AND EXTERIOR DRY) IS EXPECTED TO EXCEED 19%. CONNECTORS AND THEIR FASTENERS SHALL BE THE SAME MATERIAL. COMPLY WITH THE TREATMENT MANUFACTURERS RECOMMENDATIONS FOR PROTECTION OF METAL.

39. TIMBER CONNECTORS CALLED OUT BY LETTERS AND NUMBERS SHALL BE "STRONG-TIE" BY SIMPSON COMPANY, AS SPECIFIED IN THEIR CATALOG NUMBER C-C-2021. EQUIVALENT DEVICES BY OTHER MANUFACTURERS MAY BE SUBSTITUTED, PROVIDED THEY HAVE ICC-ES APPROVAL FOR EQUAL OR GREATER LOAD CAPACITIES. PROVIDE NUMBER AND SIZE OF FASTENERS AS SPECIFIED BY MANUFACTURER FOR MAXIMUM LOAD CARRYING CAPACITY. CONNECTORS SHALL BE INSTALLED IN ACCORDANCE WITH THE MANUFACTURER'S RECOMMENDATIONS.

ALL 2X JOISTS SHALL BE CONNECTED TO FLUSH BEAMS WITH "LUS" SERIES JOIST HANGERS. ALL TJI JOISTS SHALL BE CONNECTED TO FLUSH BEAMS WITH "ITS" SERIES JOIST HANGERS. ALL DOUBLE-JOIST BEAMS SHALL BE CONNECTED TO FLUSH BEAMS WITH "MIT" SERIES JOIST HANGERS.

WHERE CONNECTOR STRAPS CONNECT TWO MEMBERS, PLACE ONE-HALF OF THE NAILS OR BOLTS IN EACH MEMBER.

ALL SHIMS SHALL BE SEASONED AND DRIED AND THE SAME GRADE (MINIMUM)AS MEMBERS CONNECTED.

40. WOOD FASTENERS

A. NAIL SIZES SPECIFIED ON DRAWINGS ARE BASED ON THE FOLLOWING SPECIFICATIONS:

SIZE	LENGTH	DIAMETER
6d	2"	0.113"
8d	2-1/2"	0.131"
10d	3"	0.148"
12d	3-1/4"	0.148"
16d BOX	3-1/2"	0.135"

IF CONTRACTOR PROPOSES THE USE OF ALTERNATE NAILS, THEY SHALL SUBMIT NAIL SPECIFICATIONS TO THE STRUCTURAL ENGINEER (PRIOR TO CONSTRUCTION) FOR REVIEW AND APPROVAL.

NAILS - PLYWOOD (APA RATED SHEATHING) FASTENERS TO FRAMING SHALL BE DRIVEN FLUSH TO FACE OF SHEATHING WITH NO COUNTERSINKING PERMITTED. TOE-NAILS SHALL BE DRIVEN AT AN ANGLE OF 30 DEGREES WITH THE MEMBER AND STARTED 1/3 THE LENGTH OF THE NAIL FROM THE MEMBER END.

B. ALL BOLTS IN WOOD MEMBERS SHALL CONFORM TO ASTM A307. PROVIDE WASHERS UNDER THE HEADS AND NUTS OF ALL BOLTS AND LAG BOLTS BEARING ON WOOD. INSTALLATION OF LAG BOLTS SHALL CONFORM TO THE NATIONAL DESIGN SPECIFICATION FOR WOOD CONSTRUCTION WITH A LEAD BORE HOLE OF 60 TO 70 PERCENT OF THE SHANK DIAMETER. LEAD HOLES ARE NOT REQUIRED FOR 3/8" AND SMALLER LAG SCREWS.

41. NOTCHES AND HOLES IN WOOD FRAMING:

A. NOTCHES ON THE ENDS OF SOLID SAWN JOISTS AND RAFTERS SHALL NOT EXCEED ONE-FOURTH THE JOIST DEPTH. NOTCHES IN THE TOP OR BOTTOM OF SOLID SAWN JOISTS SHALL NOT EXCEED ONE-SIXTH THE DEPTH AND SHALL NOT BE LOCATED IN THE MIDDLE THIRD OF THE SPAN. HOLES BORED IN SOLID SAWN JOISTS AND RAFTERS SHALL NOT BE WITHIN 2 INCHES OF THE TOP OR BOTTOM OF THE JOIST, AND THE DIAMETER OF ANY SUCH HOLE SHALL NOT EXCEED ONE-THIRD THE DEPTH OF THE JOIST.

B. IN EXTERIOR WALLS AND BEARING PARTITIONS, ANY WOOD STUD IS PERMITTED TO BE CUT OR NOTCHED TO A DEPTH NOT EXCEEDING 25 PERCENT OF ITS WIDTH. A HOLE NOT GREATER IN DIAMETER THAN 40 PERCENT OF THE STUD WIDTH IS PERMITTED TO BE BORED IN ANY WOOD STUD. IN NO CASE SHALL THE EDGE OF THE BORED HOLE BE NEARER THAN 5/8 INCH TO THE EDGE OF THE STUD. BORED HOLES SHALL NOT BE LOCATED AT THE SAME SECTION OF STUD AS A CUT OR NOTCH.

C. NOTCHES AND HOLES IN MANUFACTURED LUMBER AND PREFABRICATED PLYWOOD WEB JOISTS SHALL BE PER THE MANUFACTURERS RECOMMENDATIONS UNLESS OTHERWISE NOTED.

42. WOOD FRAMING NOTES--THE FOLLOWING APPLY UNLESS OTHERWISE SHOWN ON THE PLANS:

A. ALL WOOD FRAMING DETAILS NOT SHOWN OTHERWISE SHALL BE CONSTRUCTED TO THE MINIMUM STANDARDS OF THE INTERNATIONAL BUILDING CODE, THE AITC "TIMBER CONSTRUCTION MANUAL" AND THE AWC "NATIONAL DESIGN SPECIFICATION FOR WOOD CONSTRUCTION". MINIMUM NAILING, UNLESS OTHERWISE NOTED, SHALL CONFORM TO IBC TABLE 2304.10.2. COORDINATE THE SIZE AND LOCATION OF ALL OPENINGS WITH MECHANICAL AND ARCHITECTURAL DRAWINGS.

B. WALL FRAMING: REFER ARCHITECTURAL DRAWINGS FOR THE SIZE OF ALL WALLS. ALL STUDS SHALL BE SPACED AT 16" O.C. UNO. TWO STUDS MINIMUM SHALL BE PROVIDED AT THE END OF ALL WALLS AND AT EACH SIDE OF ALL OPENINGS, AND AT BEAM OR HEADER BEARING LOCATIONS. TWO 2x8 HEADERS SHALL BE PROVIDED OVER ALL OPENINGS NOT OTHERWISE NOTED. SOLID BLOCKING FOR WOOD COLUMNS SHALL BE PROVIDED THROUGH FLOORS TO SUPPORTS BELOW. PROVIDE CONTINUOUS SOLID BLOCKING AT MID-HEIGHT OF ALL STUD WALLS OVER 10'-0" IN HEIGHT.

ALL WALLS SHALL HAVE A SINGLE BOTTOM PLATE AND A DOUBLE TOP PLATE. END NAIL TOP PLATE TO EACH STUD WITH TWO 16d NAILS, AND TOENAIL OR END NAIL EACH STUD TO BOTTOM PLATE WITH TWO 16d NAILS. FACE NAIL DOUBLE TOP PLATE WITH 16d @ 12" O.C.. LAP TOP PLATES AT JOINTS A MINIMUM 4'-0" AND NAIL WITH TWELVE 16d NAILS @ 4" O.C. EACH SIDE JOINT.

ALL STUD WALLS SHALL HAVE THEIR LOWER WOOD PLATES ATTACHED TO WOOD FRAMING BELOW WITH TWO ROWS OF 16d NAILS @ 12" ON-CENTER, OR ATTACHED TO CONCRETE BELOW WITH 5/8" DIAMETER ANCHOR BOLTS @ 4'-0" ON-CENTER EMBEDDED 7" MINIMUM, UNLESS INDICATED OTHERWISE. INDIVIDUAL MEMBERS OF BUILT-UP POSTS SHALL BE NAILED TO EACH OTHER WITH TWO ROWS OF 16d @12" ON-CENTER. UNLESS OTHERWISE NOTED, GYPSUM WALLBOARD SHALL BE FASTENED TO THE INTERIOR SURFACE OF ALL STUDS AND PLATES WITH NO. 6 X 1-1/4" TYPE S OR W SCREWS @ 8" ON-CENTER. UNLESS INDICATED OTHERWISE, 1/2" (NOMINAL)APA RATED SHEATHING (SPAN RATING 24/0) SHALL BE NAILED TO ALL EXTERIOR SURFACES WITH 8d NAILS @ 6" ON-CENTER AT PANEL EDGES AND TOP AND BOTTOM PLATES (BLOCK UN-SUPPORTED EDGES)AND TO ALL INTERMEDIATE STUDS AND BLOCKING WITH 8d NAILS @ 12" ON-CENTER ALLOW 1/8" SPACING AT ALL PANEL EDGES AND PANEL ENDS.

C. FLOOR AND ROOF FRAMING: PROVIDE DOUBLE JOISTS UNDER ALL PARALLEL PARTITIONS THAT EXTEND OVER MORE THAN HALF THE JOIST LENGTH AND AROUND ALL OPENINGS IN FLOORS OR ROOFS UNLESS OTHERWISE NOTED. PROVIDE SOLID BLOCKING BETWEEN RAFTERS AND JOISTS AT ALL BEARING POINTS WITH A MINIMUM OF (3) 16d TOE NAILS EACH END. TOE-NAIL JOISTS TO SUPPORTS WITH TWO 16d NAILS. ATTACH TIMBER JOISTS TO FLUSH HEADERS OR BEAMS WITH SIMPSON METAL JOIST HANGERS IN ACCORDANCE WITH NOTES ABOVE. NAIL ALL MULTI JOIST BEAMS TOGETHER WITH TWO ROWS 16d @ 12" ON-CENTER.

UNLESS OTHERWISE NOTED ON THE PLANS, PLYWOOD ROOF AND FLOOR SHEATHING SHALL BE LAID UP WITH GRAIN PERPENDICULAR TO SUPPORTS AND NAILED AT 6" ON-CENTER WITH 8d NAILS TO FRAMED PANEL EDGES, STRUTS AND OVER STUD WALLS AS SHOWN ON PLANS AND @ 12" ON-CENTER TO INTERMEDIATE SUPPORTS. PROVIDE APPROVED PLYWOOD EDGE CLIPS CENTERED BETWEEN JOISTS/TRUSSES AT UNBLOCKED ROOF SHEATHING EDGES. ALL FLOOR SHEATHING EDGES SHALL HAVE APPROVED T&G JOINTS OR SHALL BE SUPPORTED WITH SOLID BLOCKING. ALLOW 1/8" SPACING AT ALL PANEL EDGES AND ENDS OF FLOOR AND ROOF SHEATHING. TOENAIL BLOCKING TO SUPPORTS WITH 16d @ 12" ON-CENTER, MINIMUM TWO NAILS PER BLOCK, UNLESS OTHERWISE NOTED.

D. WOOD SHRINKAGE: MECHANICAL, ELECTRICAL, PLUMBING FIRE PROTECTION, CLADDING, AND OTHER SYSTEMS INSTALLED WITHIN THE BUILDING SHALL BE DESIGNED AND CONSTRUCTED TO ACCOMMODATE 3/8" OF VERTICAL MOVEMENT PER FLOOR LEVEL



**STRUCTURAL  
ENGINEERING**

**SEATTLE**  
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DESIGN:	AGL
CHECKED:	AGL
APPROVED:	-

REVISIONS:		

JURISDICTIONAL APPROVAL STAMP:

PROJECT TITLE:  
**Ojai Permanent Supportive Housing**  
611 S Montgomery St  
Ojai, CA

ARCHITECT:  
**DJA Architects**

ISSUE:

Design Development

SHEET TITLE: <b>General Structural Notes</b>	
SCALE:	
DATE:	25 July, 2025
PROJECT NO:	02061-2025-01
SHEET NO:	

S1.2



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611 S Montgomery St  
Ojai, CA

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SHEET TITLE:

**Foundation  
Plan**


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DATE: 25 July, 2025

PROJECT NO: 02061-2025-01

SHEET NO:

**S2.1**

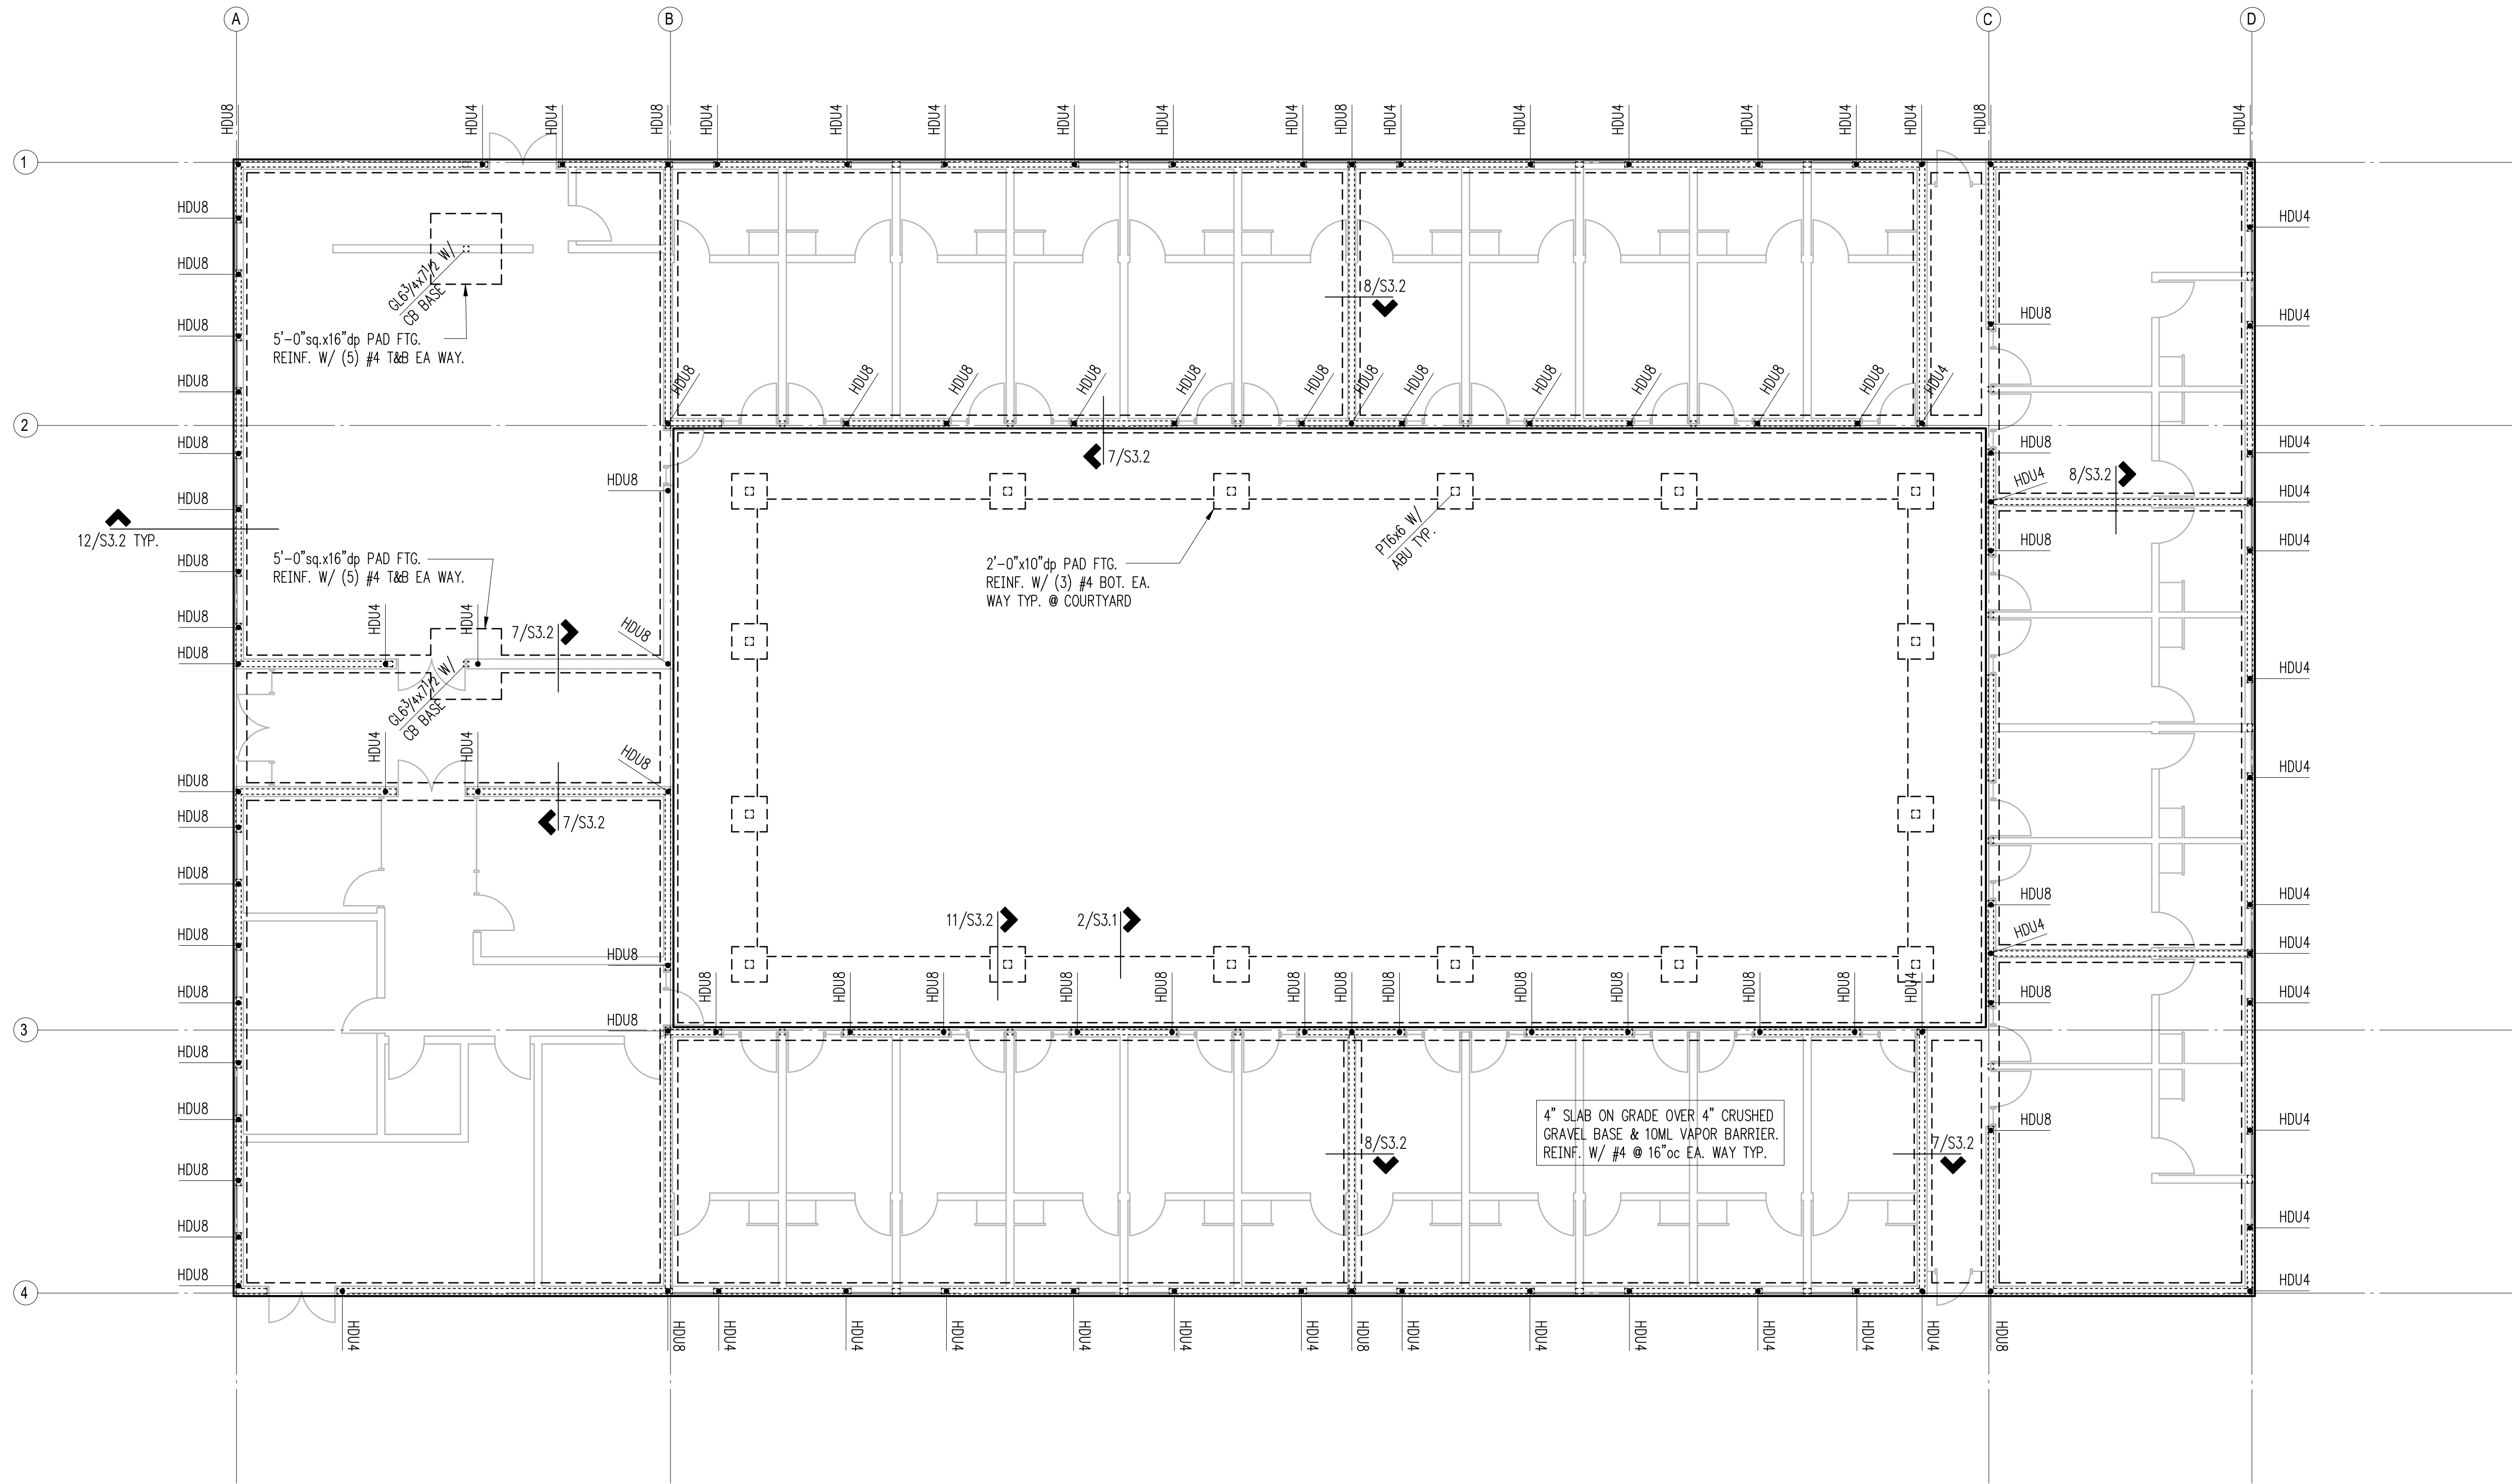

Plan Notes

- DO NOT SCALE DRAWINGS. REFER TO ARCHITECTURAL DRAWINGS FOR ALL DIMENSIONS.
- THE BOTTOM OF ALL EXTERIOR FOOTINGS SHALL BE 18" MINIMUM BELOW GRADE.
- 4" SLAB ON GRADE OVER 4" CRUSHED AGGREGATE BASE AND 10MIL VAPOR BARRIER. REINFORCE WITH #3 @ 12"OC EACH DIRECTION. PROVIDE CONTROL JOINTS PER DETAIL 12/S3.1
- PROVIDE CORNER BARS PER DETAIL 8/S3.1 AT ALL WALL AND FOOTING INTERSECTIONS.
- ALL POSTS ABOVE SHALL BEAR FULLY ON BEAMS OR POSTS BELOW AND SHALL HAVE CONTINUOUS FULL BEARING THROUGH FLOORS TO THE FOUNDATION.
- REFER TO GENERAL STRUCTURAL NOTES FOR ADDITIONAL REQUIREMENTS.


Legend

Foundation Plan

Scale: 1/8" = 1'-0"






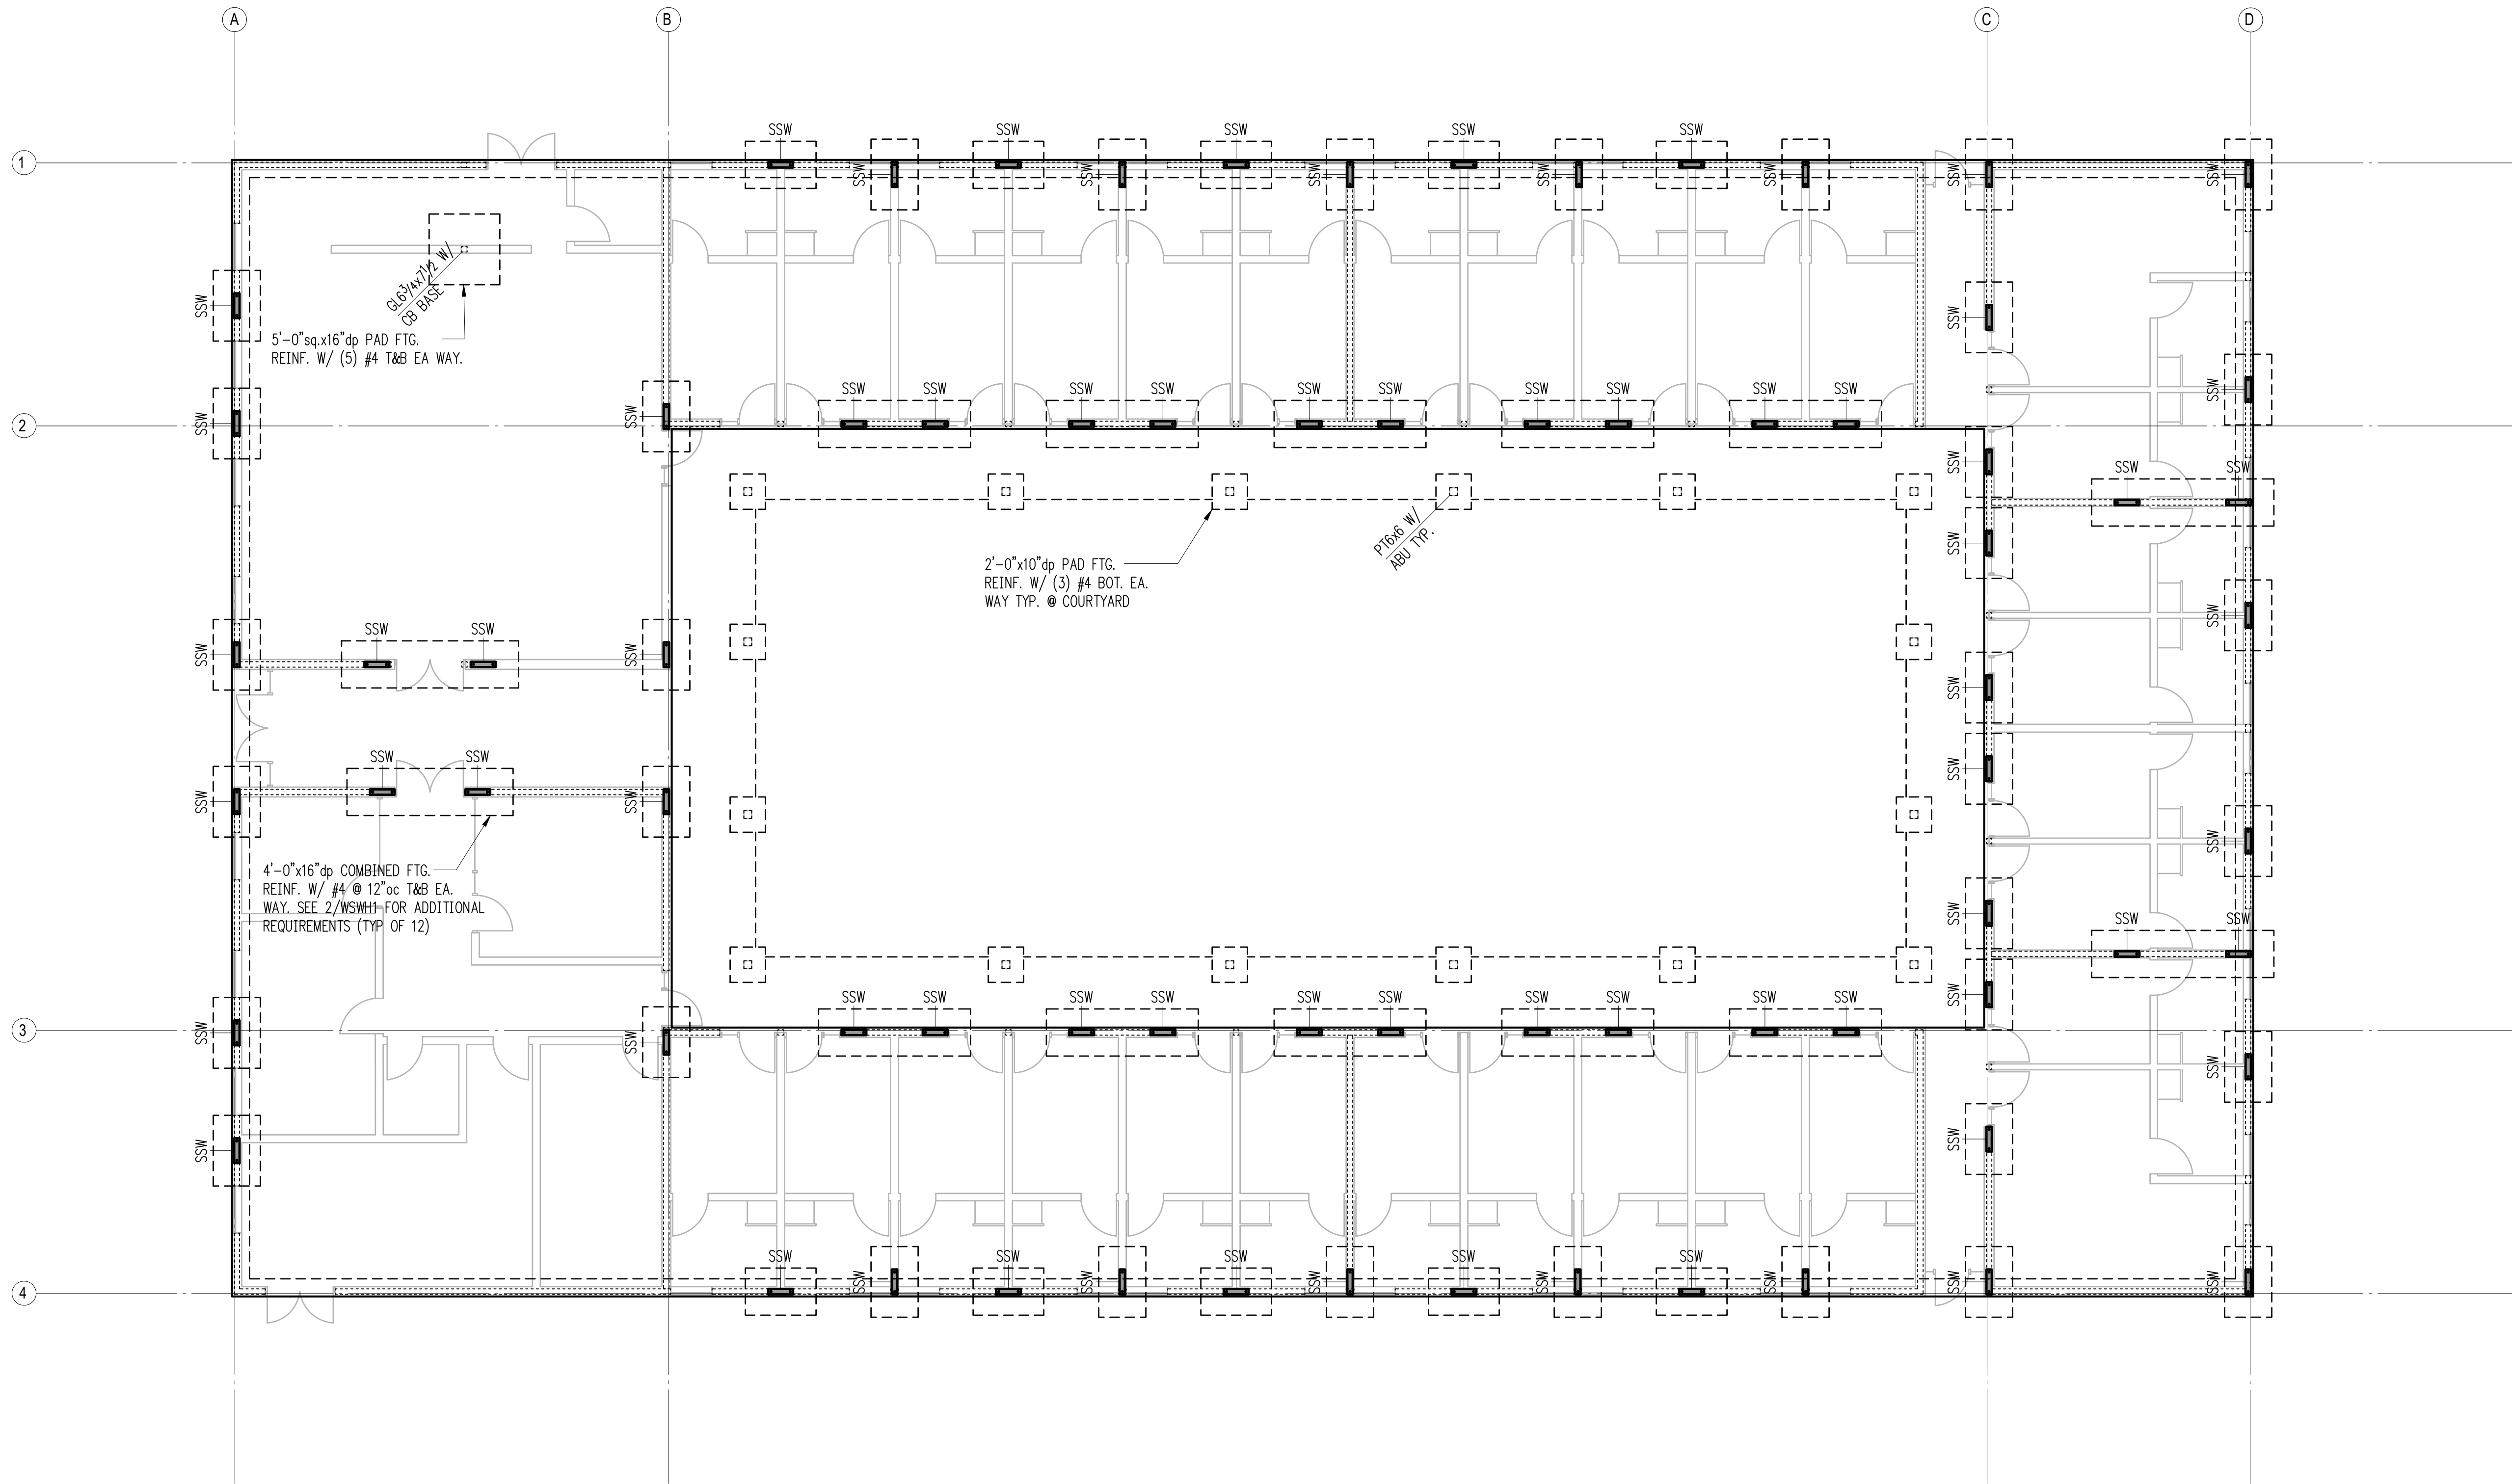

### Plan Notes

- DO NOT SCALE DRAWINGS. REFER TO ARCHITECTURAL DRAWINGS FOR ALL DIMENSIONS.
- THE BOTTOM OF ALL EXTERIOR FOOTINGS SHALL BE 18" MINIMUM BELOW GRADE.
- 4" SLAB ON GRADE OVER 4" CRUSHED AGGREGATE BASE AND 10MIL VAPOR BARRIER. REINFORCE WITH #3 @ 12"OC EACH DIRECTION. PROVIDE CONTROL JOINTS PER DETAIL 12/S3.1
- PROVIDE CORNER BARS PER DETAIL 8/S3.1 AT ALL WALL AND FOOTING INTERSECTIONS.
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- REFER TO GENERAL STRUCTURAL NOTES FOR ADDITIONAL REQUIREMENTS.

### Legend

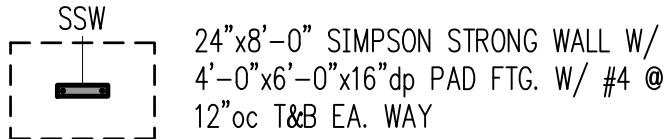

### Foundation Plan

Scale: 1/8" = 1'-0"



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611 S Montgomery St  
Ojai, CA

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DJA Architects

ISSUE:

Design Development

SHEET TITLE:

**Foundation Plan  
(Strongwall)**

SCALE: 1/8" = 1'-0"

DATE: 25 July, 2025

PROJECT NO: 02061-2025-01

SHEET NO:

**S2.1a**



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SHEET TITLE:

**Roof  
Framing  
Plan**


SCALE:  
1/8" = 1'-0"

DATE:  
25 July, 2025

PROJECT NO:  
02061-2025-01

SHEET NO:

**S2.2**

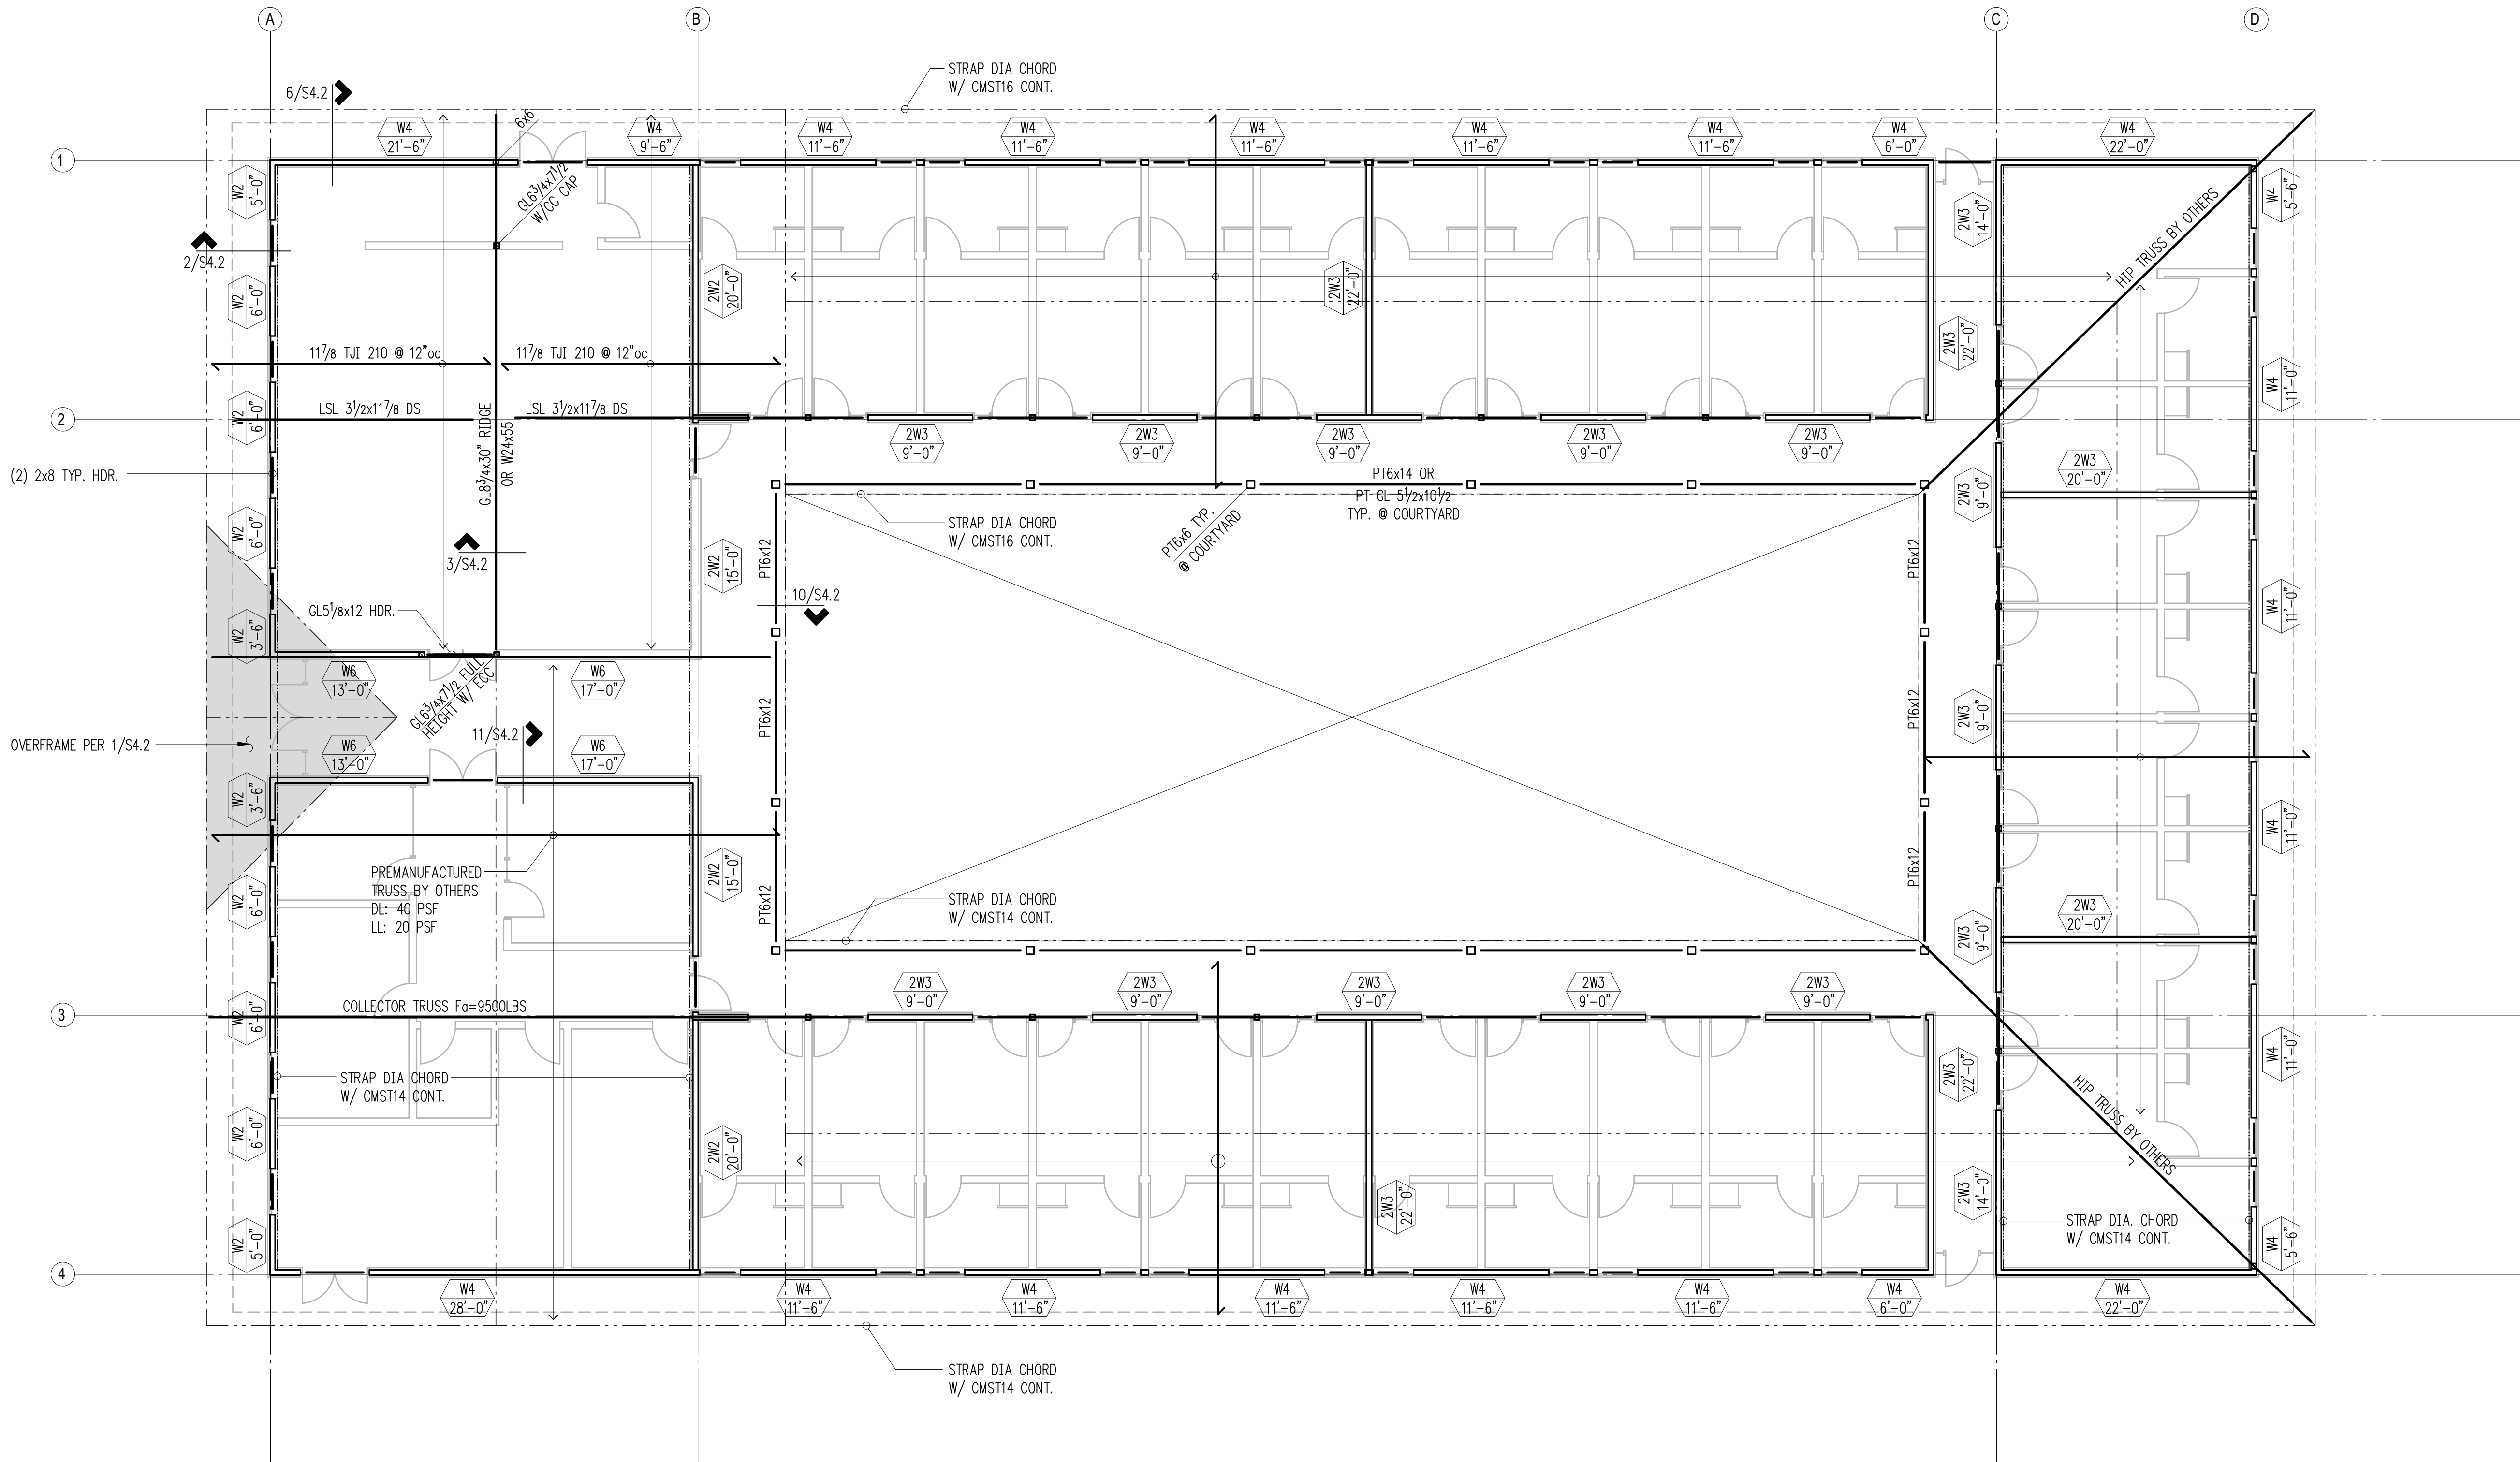

#### Plan Notes

- DO NOT SCALE DRAWINGS. REFER TO ARCHITECTURAL DRAWINGS FOR ALL DIMENSIONS.
- ROOF SHEATHING SHALL BE 1/2" A.P.A. RATED PANELS (EXPOSURE 1, SPAN RATING 32/16), FACE GRAIN PERPENDICULAR TO SUPPORTS OVER ROOF FRAMING PER PLAN. NAIL SHEATHING AT ALL FRAMED PANEL EDGES WITH 8D AT 6" O.C. AND TO ALL INTERMEDIATE FRAMING AT 12" O.C.
- HEADERS OVER DOOR AND WINDOW OPENINGS SHALL BE (2) 2X8 MINIMUM. PROVIDE (2) TRIMMER STUDS (MINIMUM) AT EACH END OF ALL HEADERS UNLESS NOTED OTHERWISE ON PLANS. SEE DETAIL 6/S4.1 FOR TYPICAL INSTALLATION.
- PROVIDE (2) STUDS (MINIMUM) AT EACH END OF ALL BEAMS UNLESS NOTED OTHERWISE ON PLANS. BEAR BEAM FULLY ON BUILT UP COLUMN AND PROVIDE AC, PC, OR LPC CAP.
- W # INDICATES SHEAR WALL. SEE SHEARWALL SCHEDULE FOR CONSTRUCTION REQUIREMENTS.
- ALL EXTERIOR WALLS SHALL BE W6, UNLESS NOTED OTHERWISE ON PLANS.
- PROVIDE H1 HURRICANE TIE AT EACH TRUSS/RAFTER WHERE IT BEARS ON EXTERIOR WALL.
- MANUFACTURED LUMBER PRODUCTS (LSL, LVL, PSL, GL) SHALL BE INSTALLED WITH A MOISTURE CONTENT OF 12% OR LESS. THE CONTRACTOR SHALL MAKE PROVISIONS DURING CONSTRUCTION TO PREVENT THE MOISTURE CONTENT OF INSTALLED BEAMS FROM EXCEEDING 12%.
- SPLICE ALL TOP PLATE SPLICES PER DETAIL 10/S4.1.
- REFER TO GENERAL STRUCTURAL NOTES FOR ADDITIONAL REQUIREMENTS.


#### Legend

#### Roof Framing Plan

Scale: 1/8" = 1'-0"





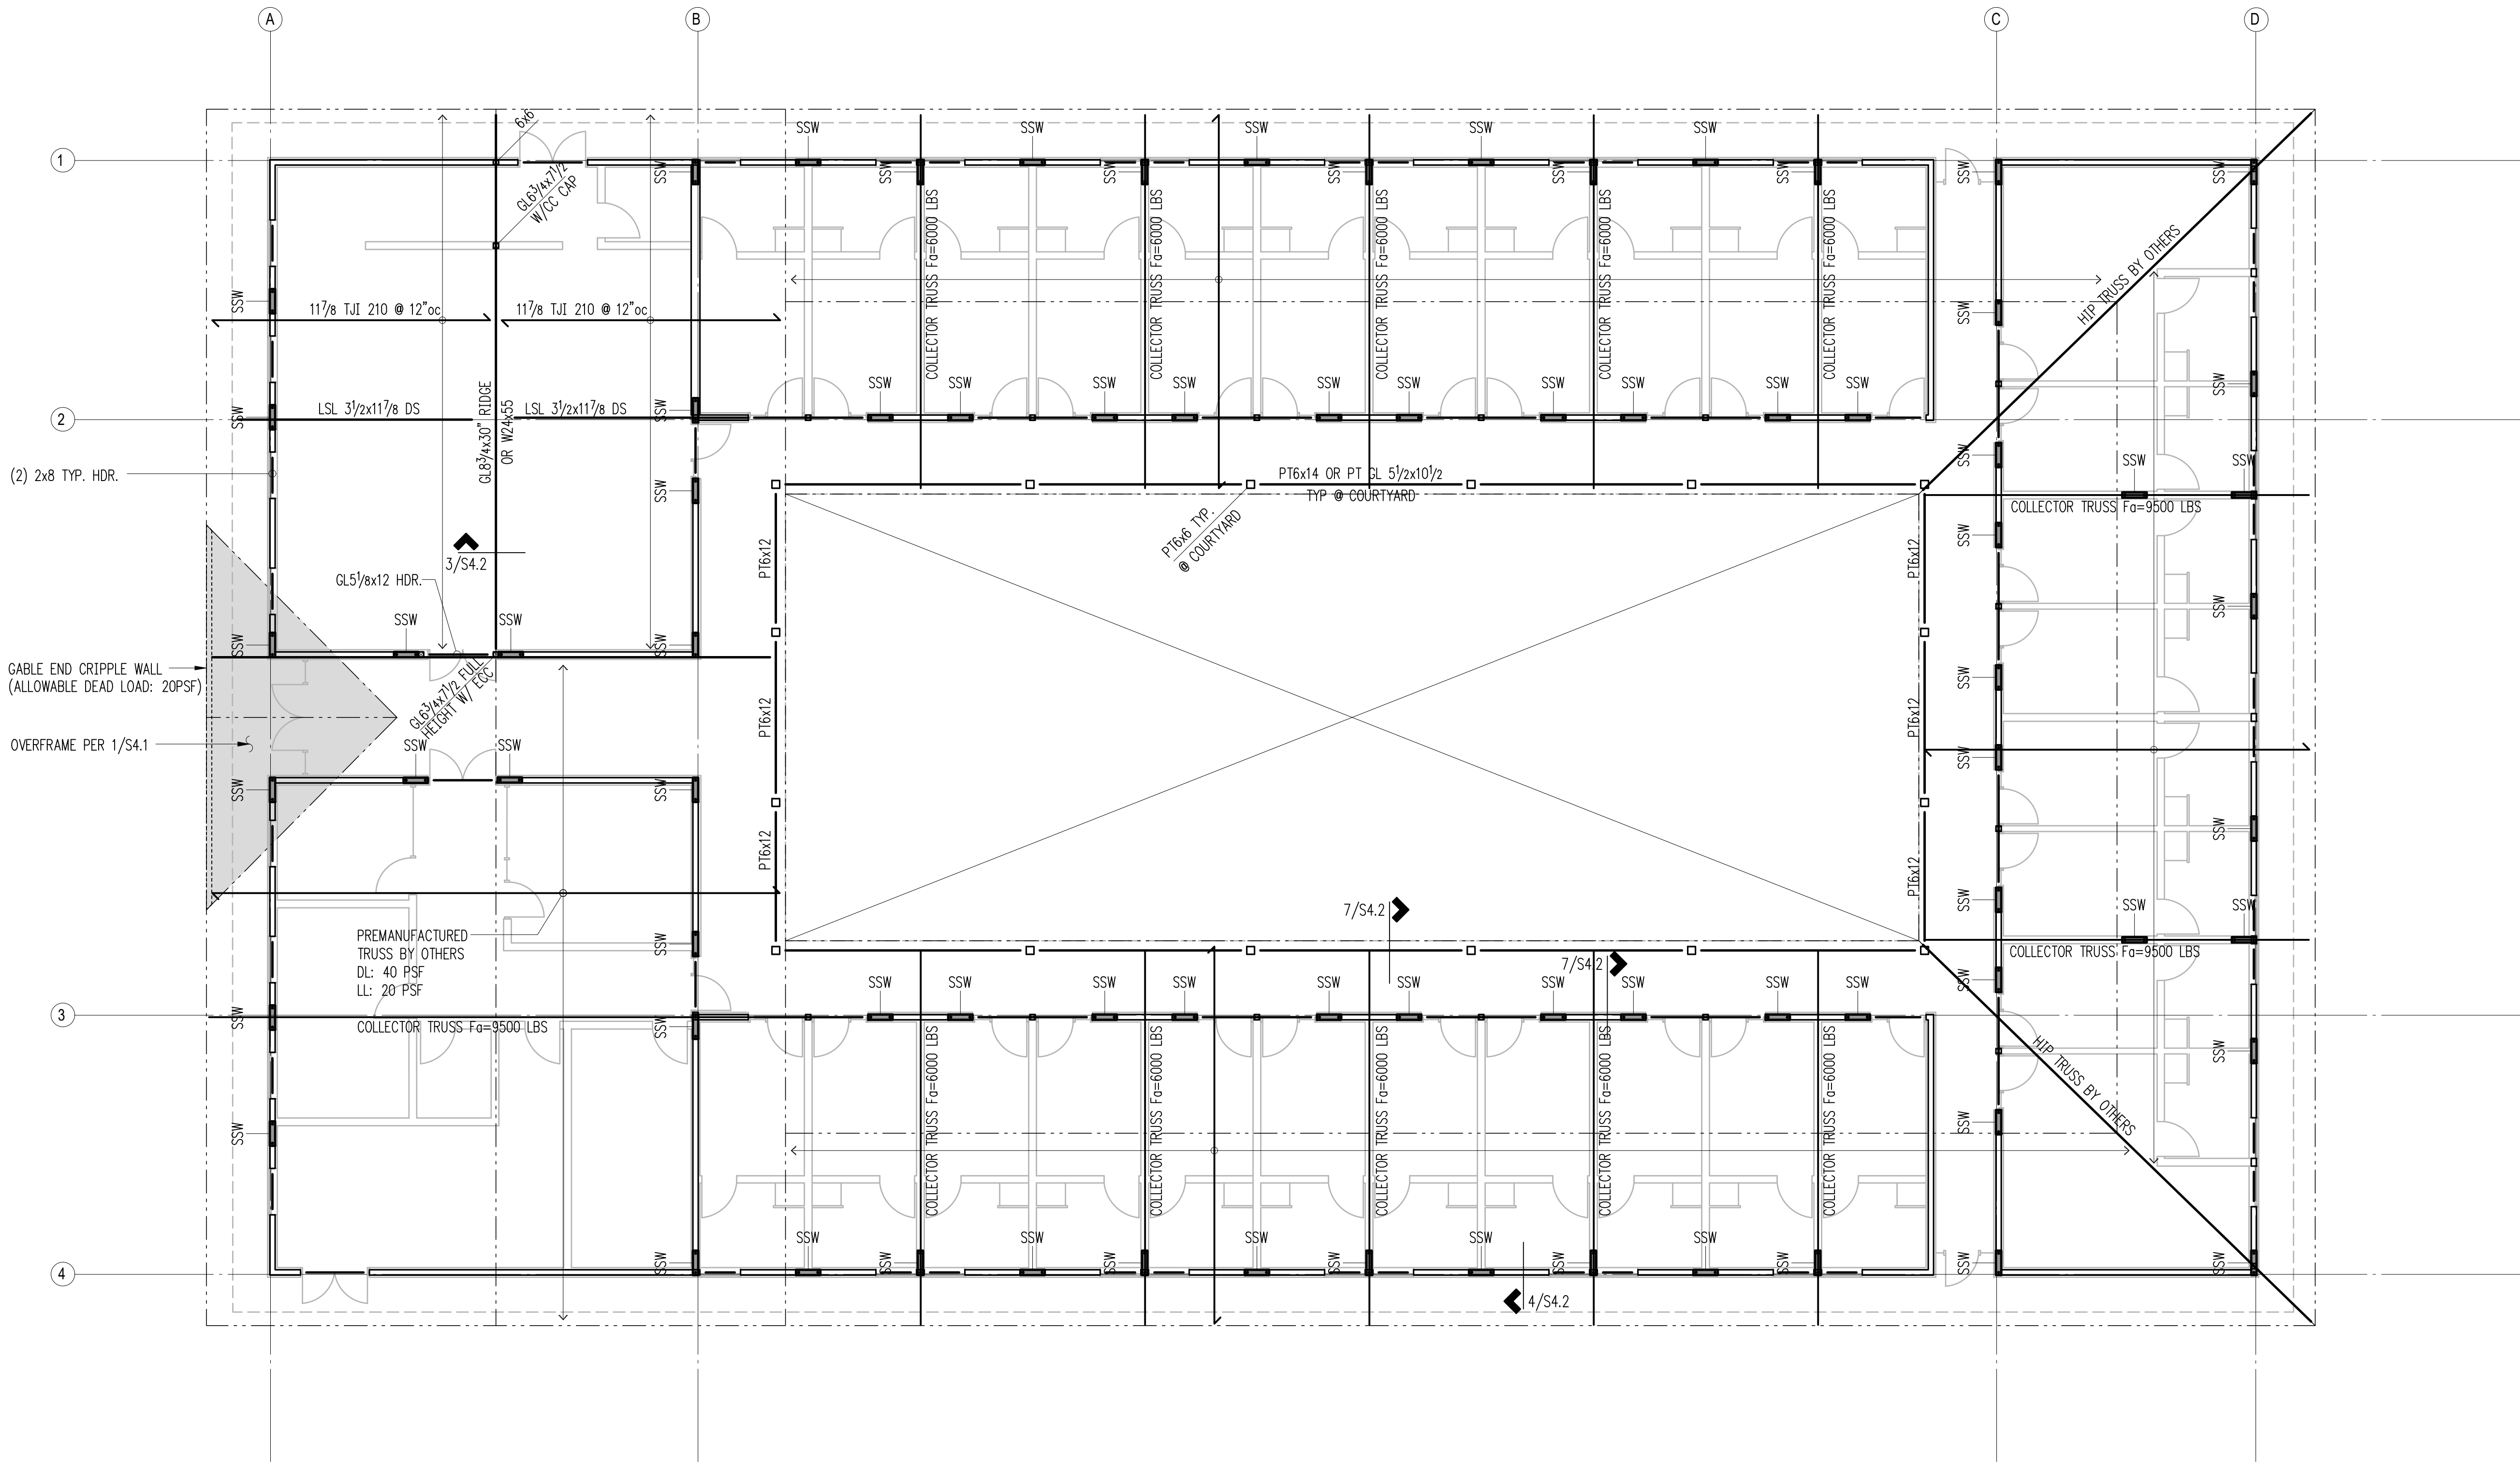

### Plan Notes

- DO NOT SCALE DRAWINGS. REFER TO ARCHITECTURAL DRAWINGS FOR ALL DIMENSIONS.
- ROOF SHEATHING SHALL BE 1/2" A.P.A. RATED PANELS (EXPOSURE 1, SPAN RATING 32/16), FACE GRAIN PERPENDICULAR TO SUPPORTS OVER ROOF FRAMING PER PLAN. NAIL SHEATHING AT ALL FRAMED PANEL EDGES WITH 8D AT 6" O.C. AND TO ALL INTERMEDIATE FRAMING AT 12" O.C.
- HEADERS OVER DOOR AND WINDOW OPENINGS SHALL BE (2) 2X8 MINIMUM. PROVIDE (2) TRIMMER STUDS (MINIMUM) AT EACH END OF ALL HEADERS UNLESS NOTED OTHERWISE ON PLANS. SEE DETAIL 6/S4.1 FOR TYPICAL INSTALLATION.
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- SPLICE ALL TOP PLATE SPLICES PER DETAIL 10/S4.1.
- REFER TO GENERAL STRUCTURAL NOTES FOR ADDITIONAL REQUIREMENTS.

### Legend

- SSW  
24"x8'-0" SIMPSON STRONG WALL  
REF SHEETS WSWH1&2

### Roof Framing Plan

Scale: 1/8" = 1'-0"



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611 S Montgomery St  
Ojai, CA

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SHEET TITLE:

### Roof Framing Plan (Strongwall)

SCALE: 1/8" = 1'-0"


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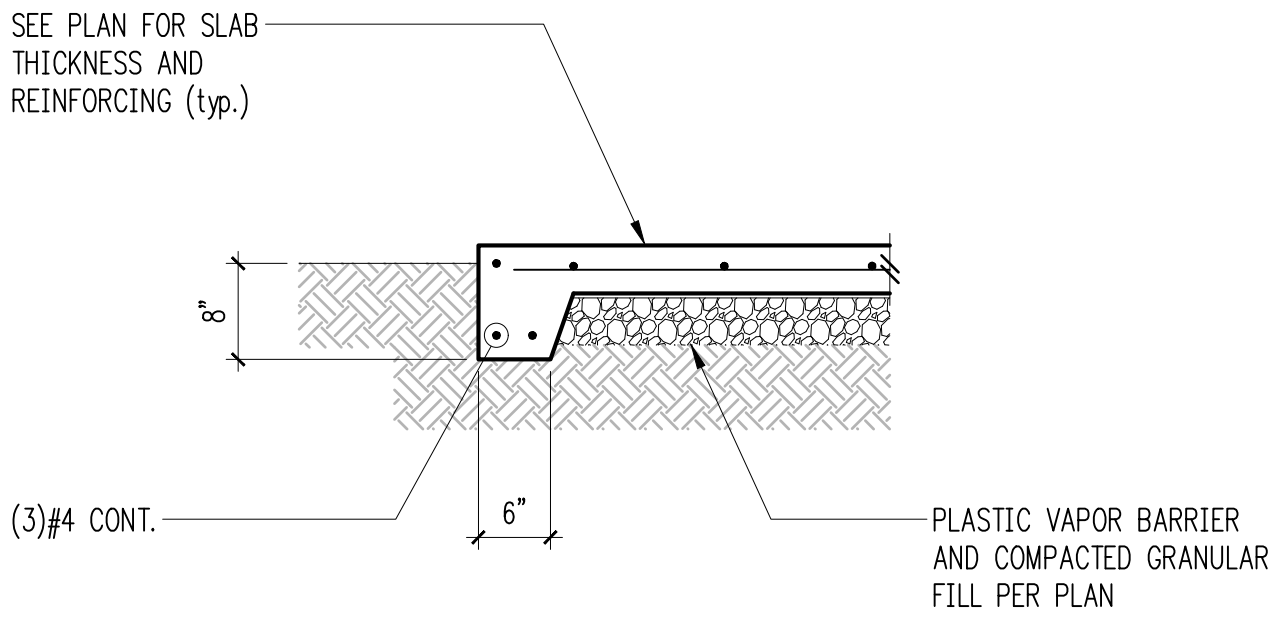
SHEET NO:

# S2.2a






Typical Turned-Down Slab Edge 1

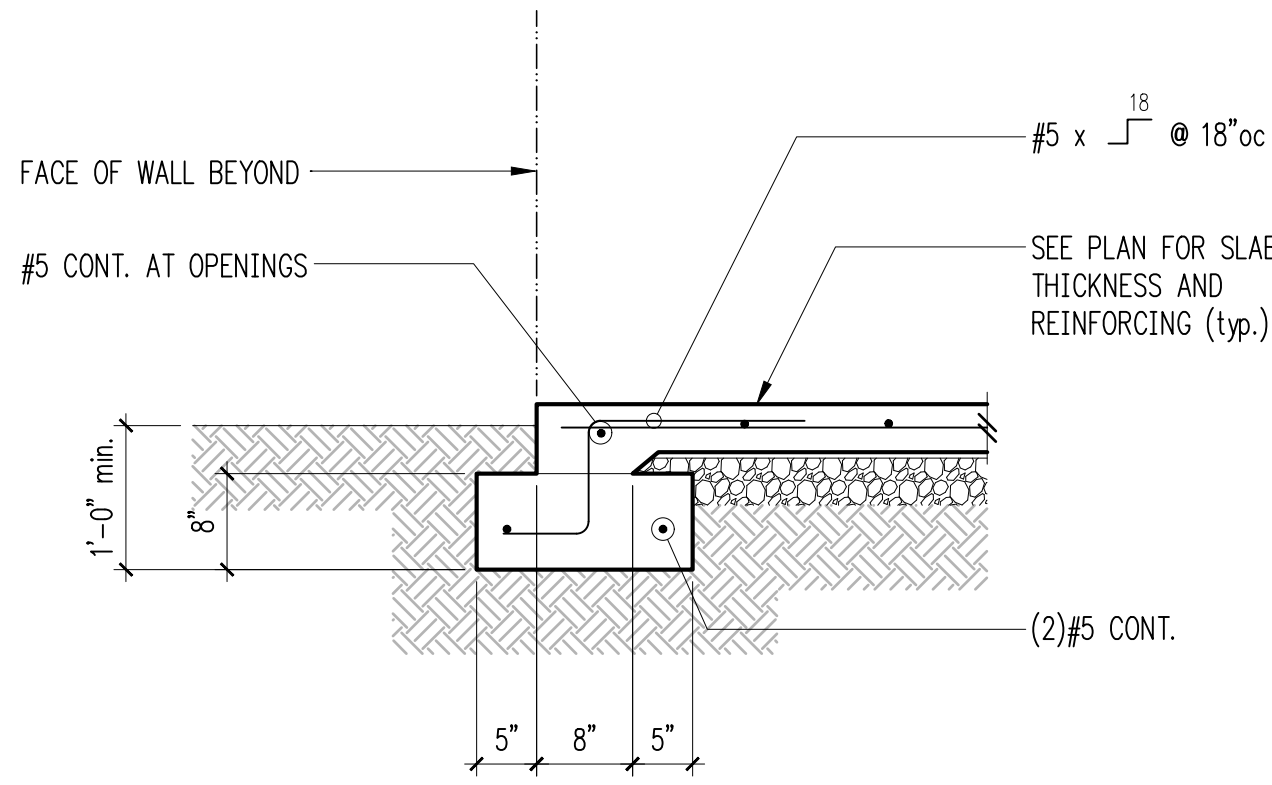

Typical Slab Edge 2

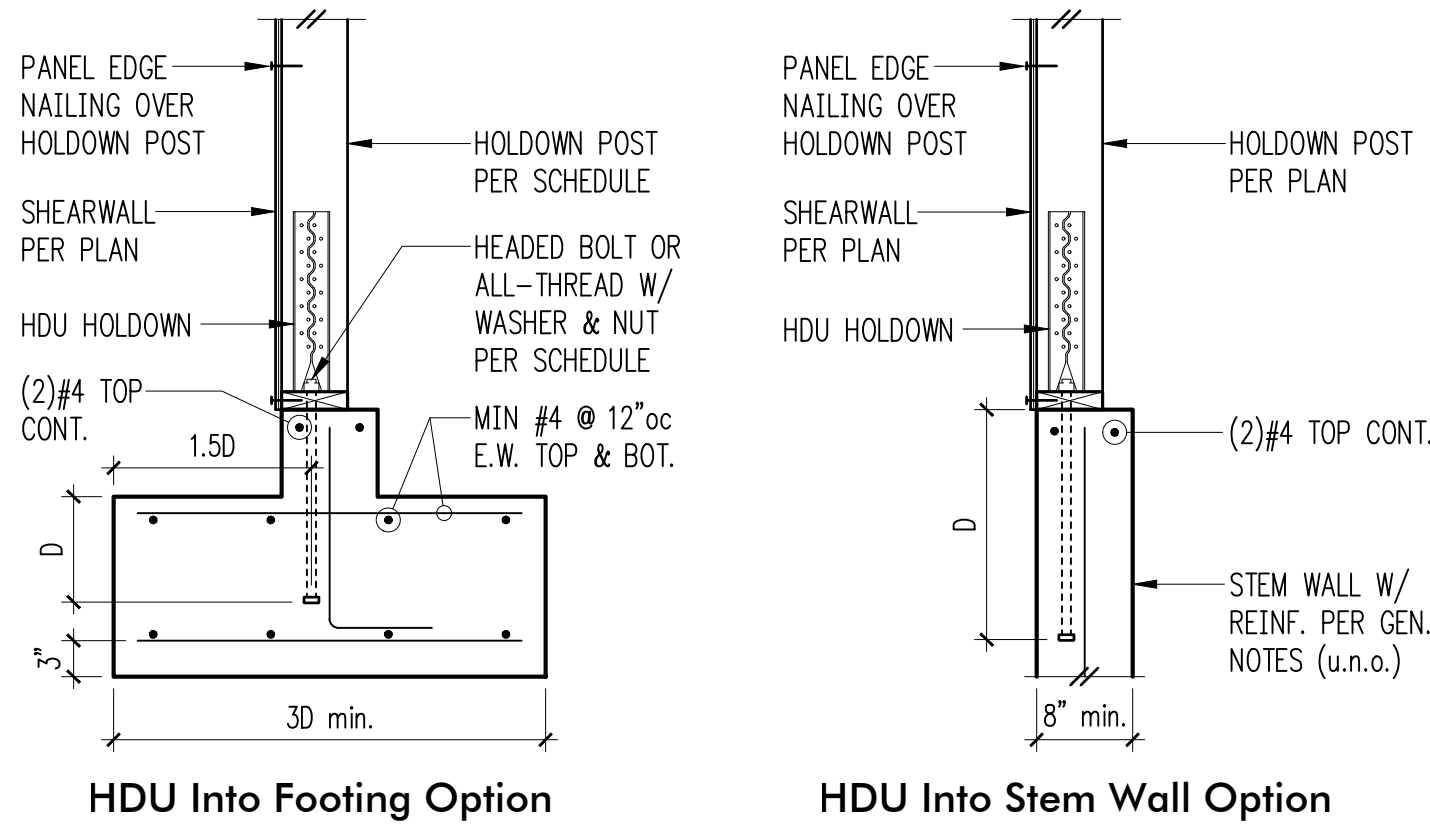


Holdown Schedule

Plan Mark	Screws	Anchor Bolt	Min. A.B. Stem Wall	Embed (D) Footing	Holdown Post ①	
					if 2x4	if 2x6
HDU2-SDS2.5	(6)SDS 1/4"x2 1/2"	5/8"Ø	12"	4"	(2) 2x4	(2) 2x6
HDU4-SDS2.5	(10)SDS 1/4"x2 1/2"	5/8"Ø	18"	6"	4x4	4x6
HDU5-SDS2.5	(14)SDS 1/4"x2 1/2"	5/8"Ø	SB5/8x24	7"	4x4	4x6
HDU8-SDS2.5	(20)SDS 1/4"x2 1/2"	7/8"Ø	SSTB28	8"	4x6	6x6
HDU11-SDS2.5	(30)SDS 1/4"x2 1/2"	1"Ø	SB1x30	10"	4x8	6x6
HDU14-SDS2.5	(36)SDS 1/4"x2 1/2"	1"Ø	N/A	12"	4x8	6x6

① MINIMUM SIZE OF POST AT END OF WALL UNLESS OTHERWISE NOTED ON FRAMING PLANS.

Typical HDU Holdown 4

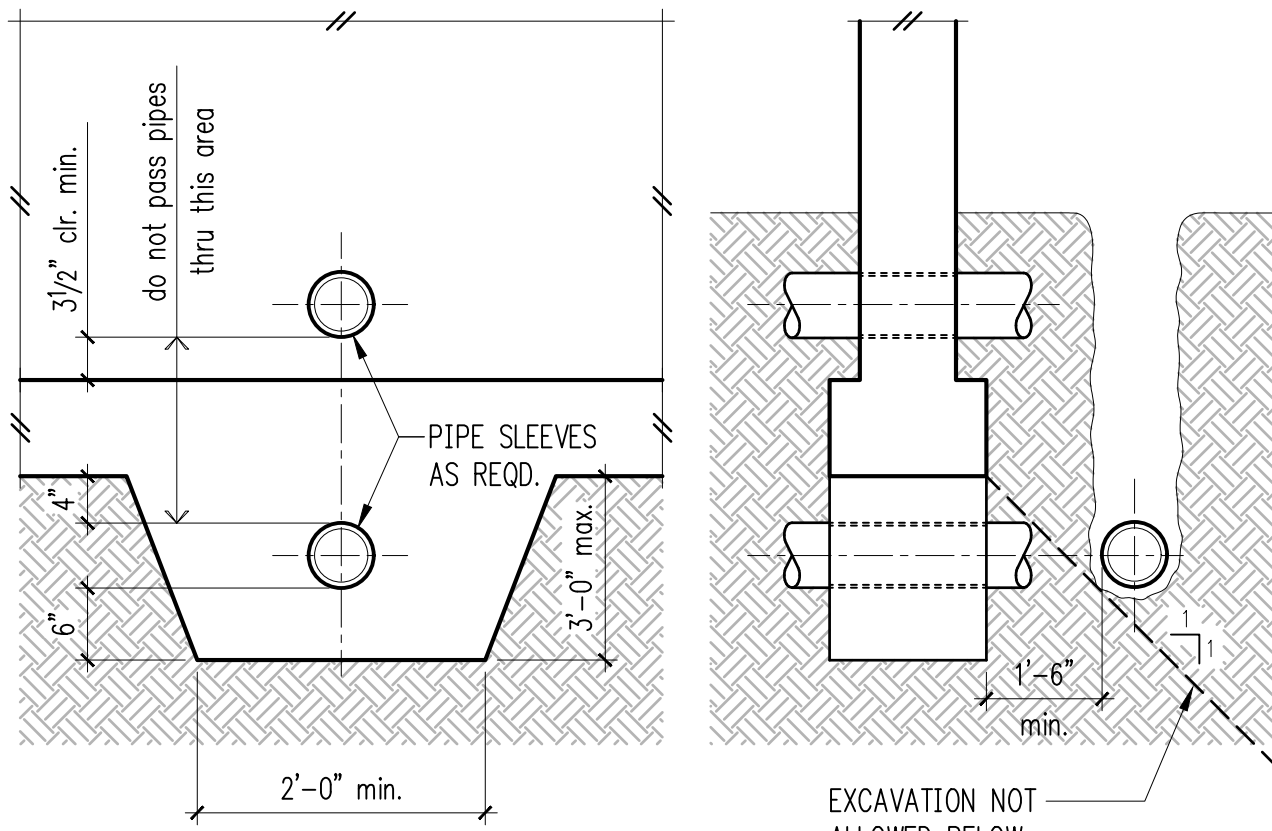

Pipe and Trench Locations 5

Reinforcing Splice and Development Length Schedule

For f<sub>c</sub> = 3000 psi, Grade 60 Reinforcing

Minimum Straight Development Length (ℓ <sub>d</sub> )		
Bar Size	Top Bars	Other Bars
#3	22"	17"
#4	29"	22"
#5	36"	28"
#6	43"	33"
#7	63"	48"
#8	72"	55"
#9	81"	62"
#10	91"	70"
#11	101"	78"

Minimum Lap Splice Lengths (ℓ <sub>s</sub> )		
Bar Size	Top Bars	Other Bars
#3	28"	22"
#4	37"	29"
#5	47"	36"
#6	56"	43"
#7	81"	63"
#8	93"	72"
#9	105"	81"
#10	118"	91"
#11	131"	101"


TOP BARS ARE HORIZONTAL BARS WITH MORE THAN 12" DEPTH OF CONCRETE CAST BELOW THEM.

IF CLEAR CONCRETE COVER IS NOT GREATER THAN THE DIAMETER OF THE BAR, OR THE CENTER TO CENTER SPACING IS NOT GREATER THAN 3 BAR DIAMETERS, THEN LENGTHS SHALL BE INCREASED BY 50%


Minimum Embedment Lengths (ℓ <sub>dh</sub> ) For Standard End Hooks	
Bar Size	Length
#3	6"
#4	8"
#5	10"
#6	12"
#7	14"
#8	16"
#9	18"
#10	20"
#11	22"

- SIDE COVER MUST BE EQUAL TO OR GREATER THAN 2 1/2"
- END COVER FOR 90° HOOKS MUST BE EQUAL TO OR GREATER THAN 2"

Reinforcing Splice Length & Development Length (3000psi) 10

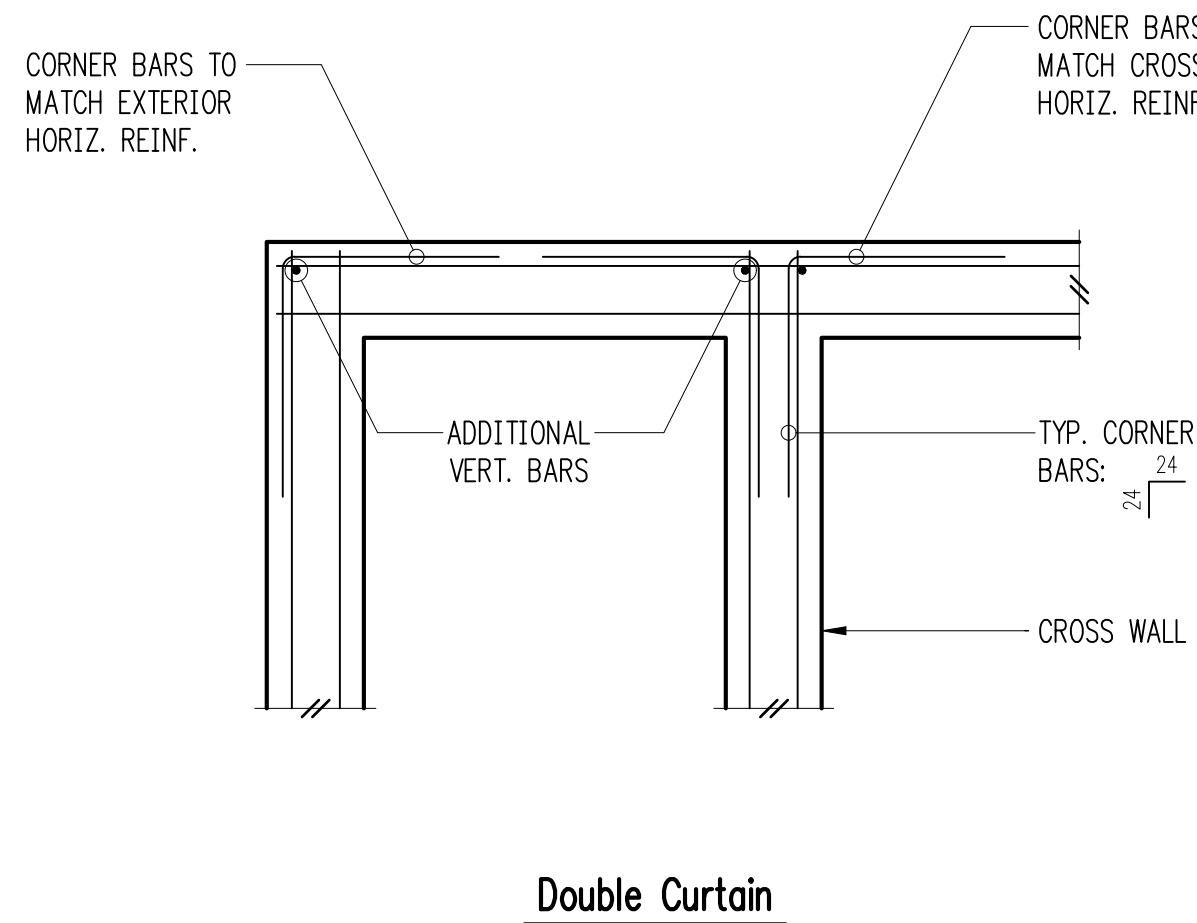


Double Curtain

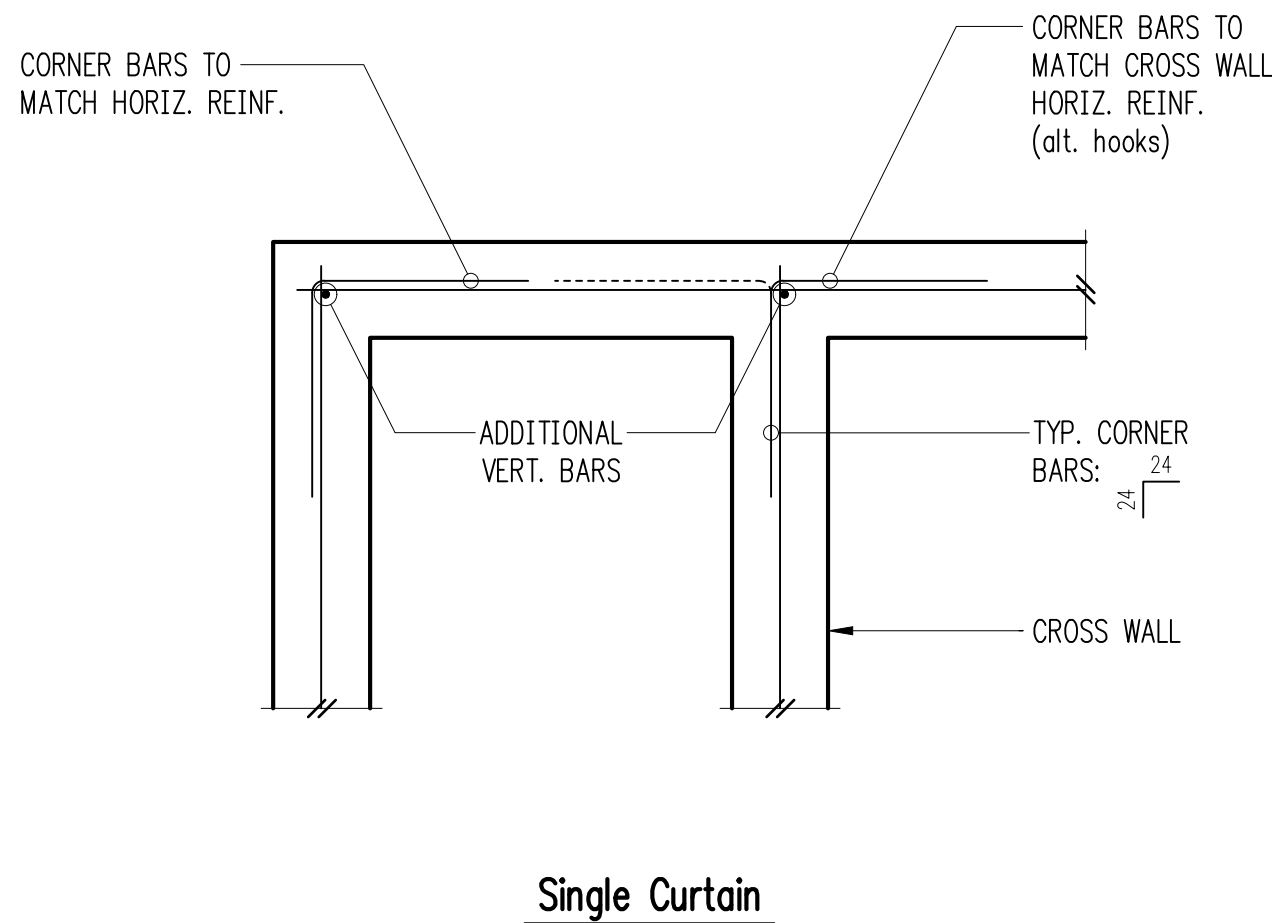


Single Curtain

Typical Corner Bars at Concrete Walls and Footings 8

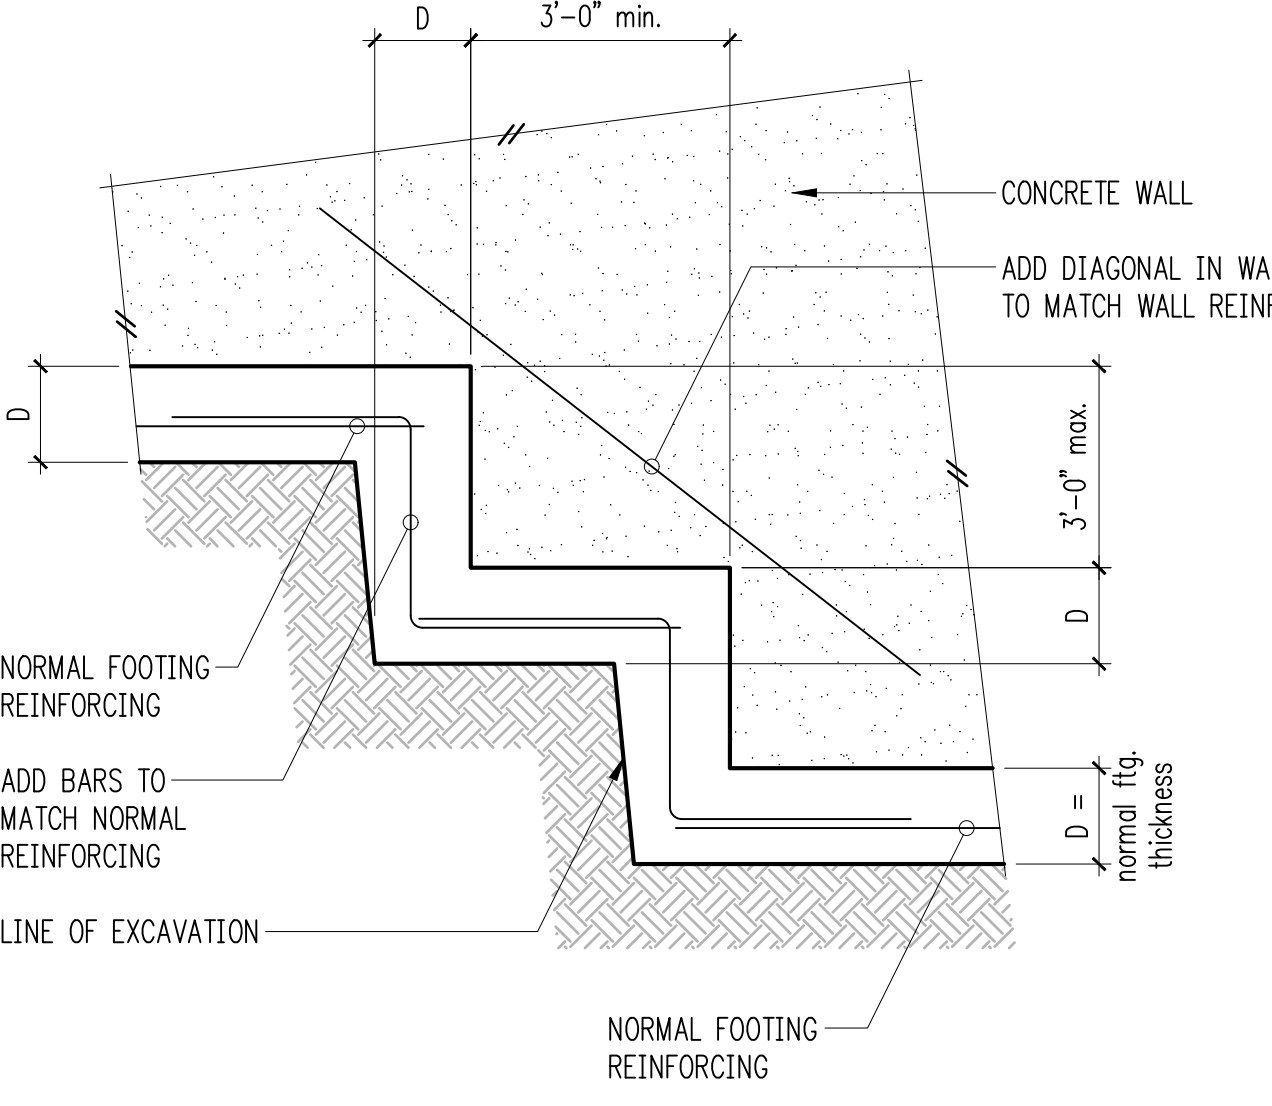

Typical Stepped Footing 9

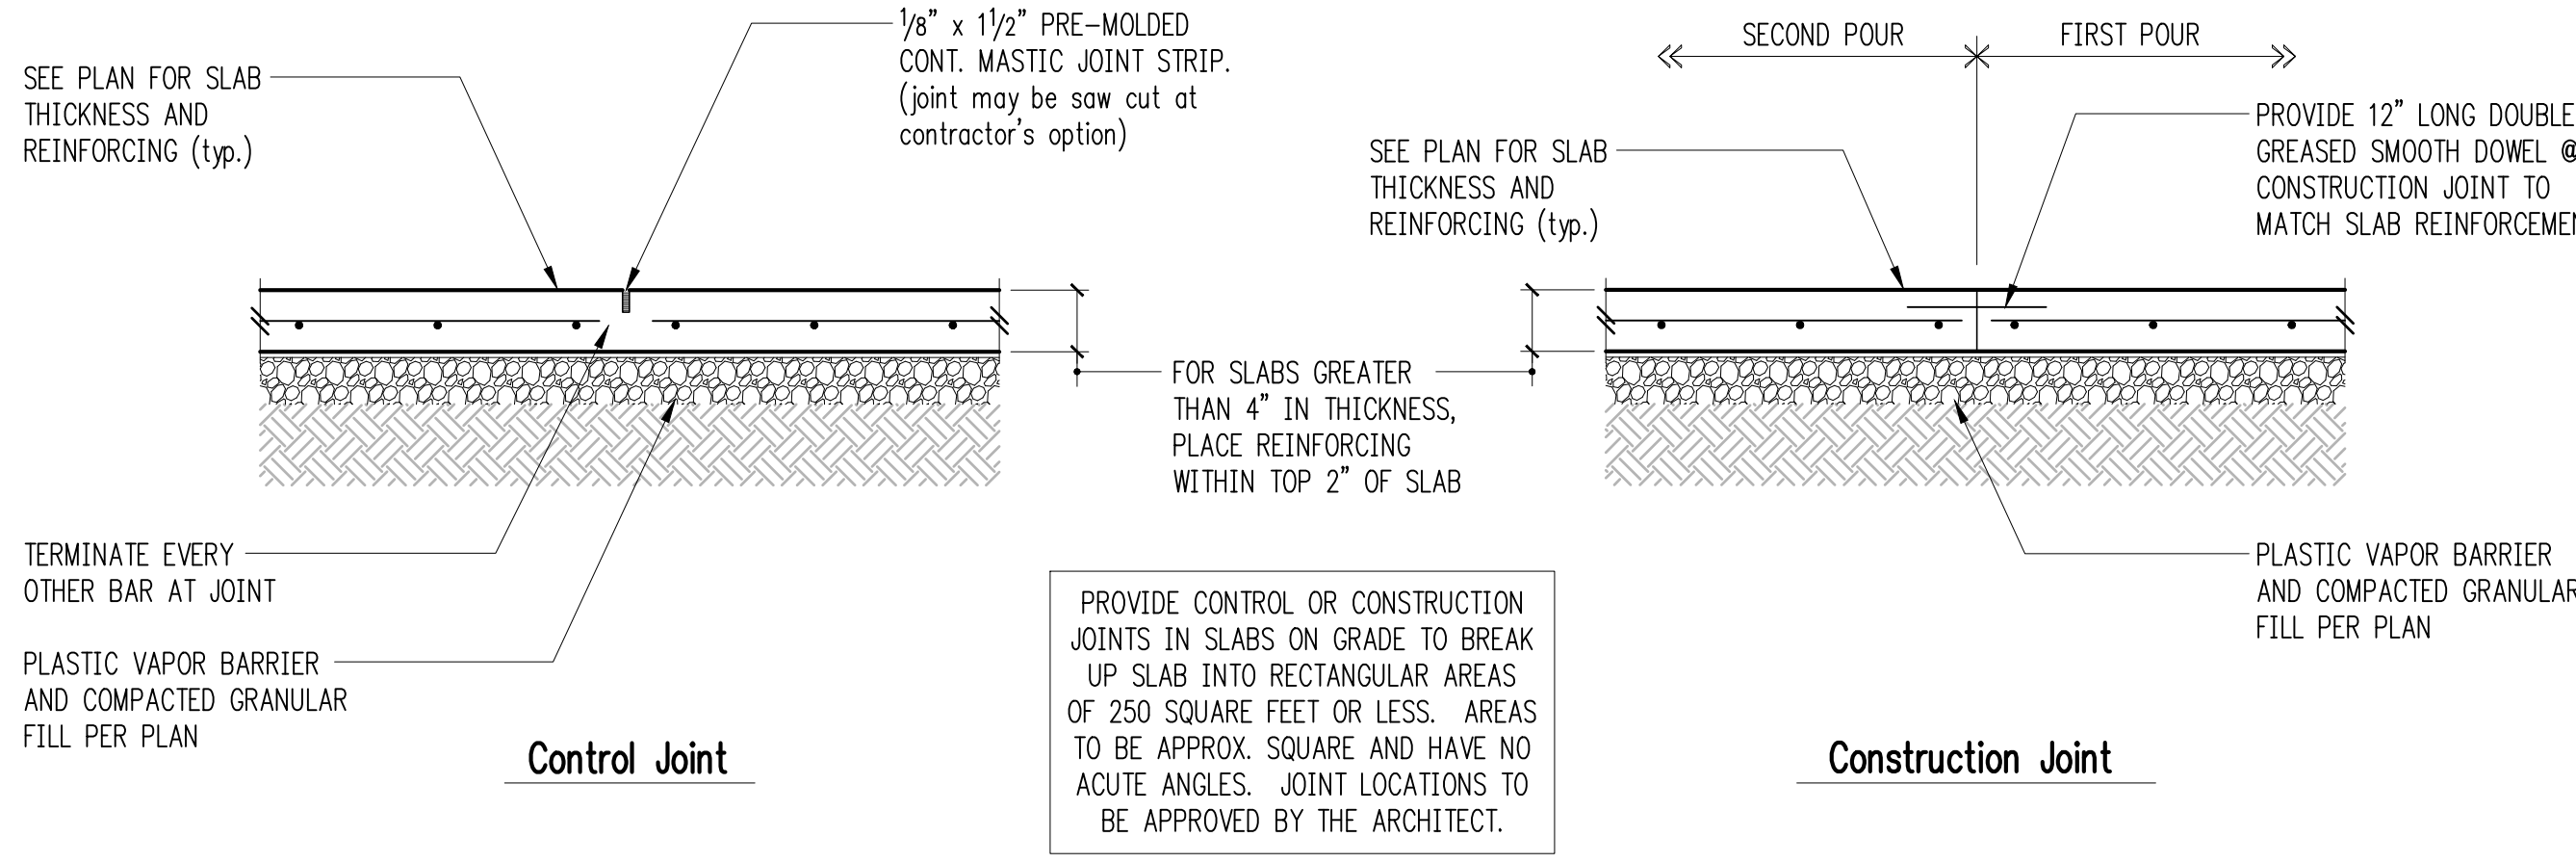

Control Joint

Construction Joint

Typical Slab Joints 12

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REVISIONS:	

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611 S Montgomery St  
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**DJA Architects**

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**Design Development**

SHEET TITLE:

**Foundation Details**

SCALE: 3/4" = 1'-0" U.N.O.

DATE: 25 July, 2025

PROJECT NO: 02061-2025-01

SHEET NO:

**S3.1**



1	2	3	4
5	6	7	8
		Interior Wall w/ Thickened Slab	Interior Wall with Thickened Slab and Step
9	10	11	12
		Post Footing w/ Slab on Grade - ABU	Exterior Wall w/ Slab on Grade

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611 S Montgomery St  
Ojai, CA


ARCHITECT:  
DJA Architects

ISSUE:  
Design Development


Foundation Details	
SCALE:	3/4" = 1'-0" U.N.O.
DATE:	25 July, 2025
PROJECT NO:	02061-2025-01
SHEET NO:	

S3.2



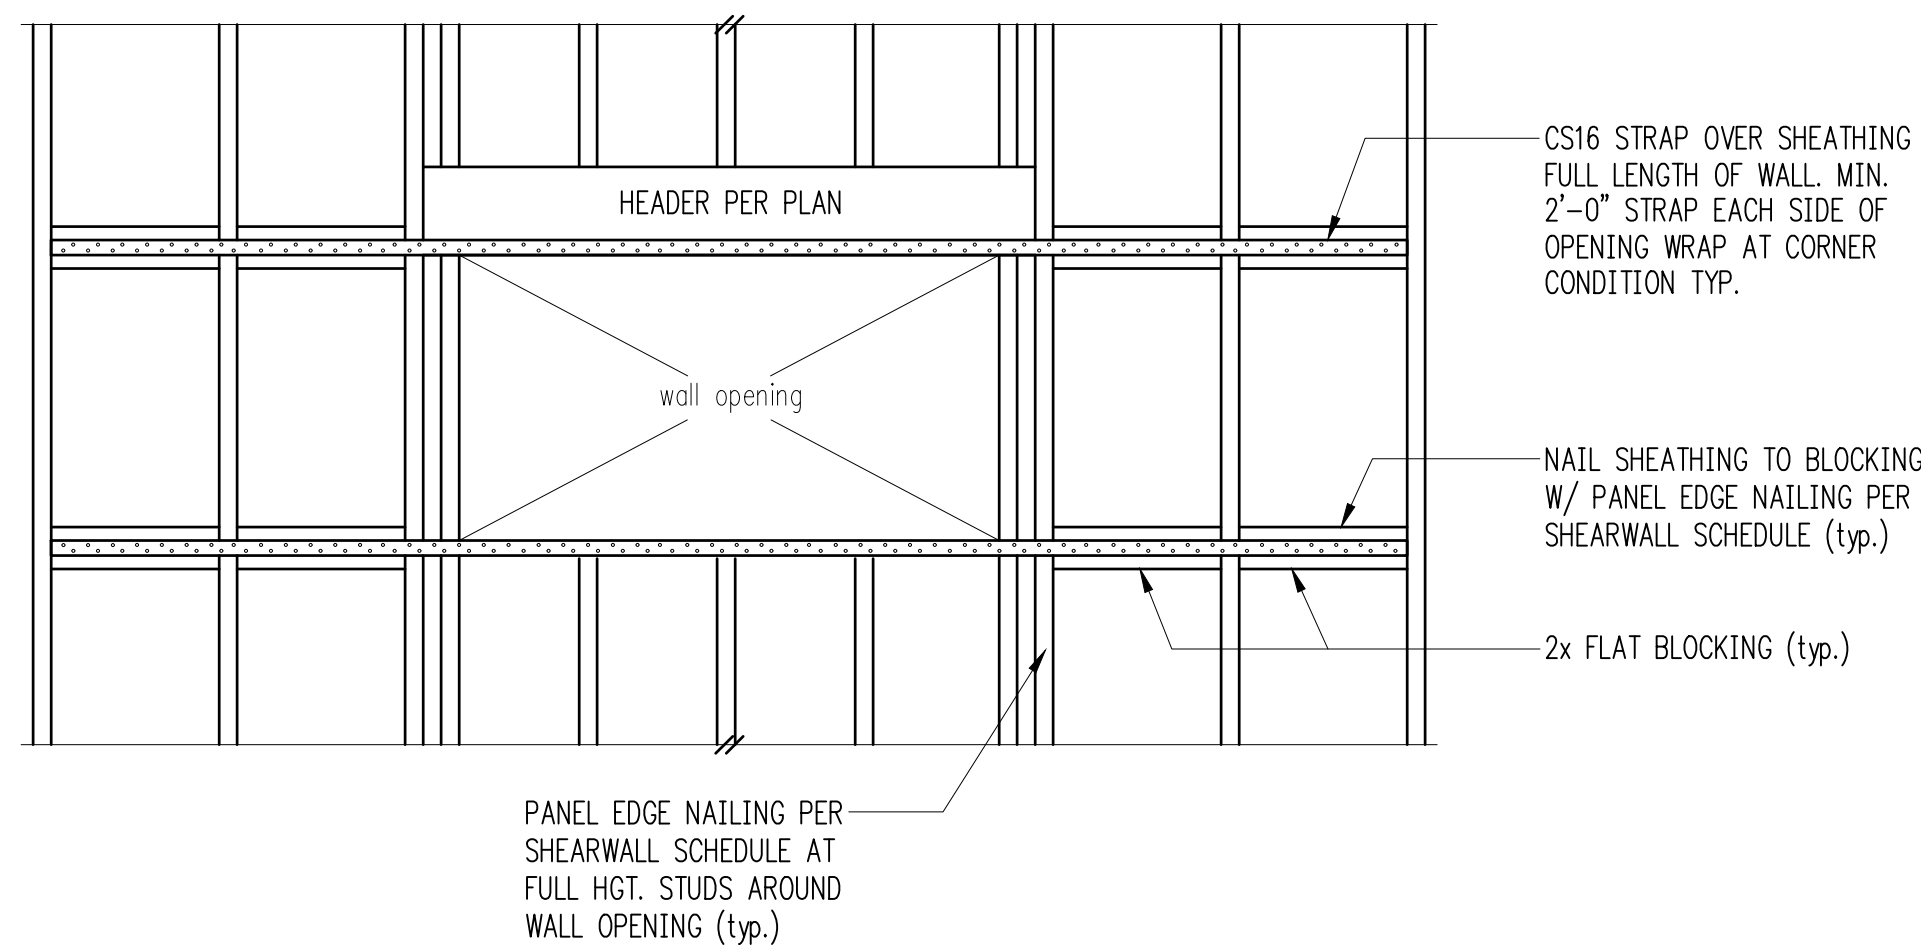

## Continuous Straps at Wall Opening (above and below) 2

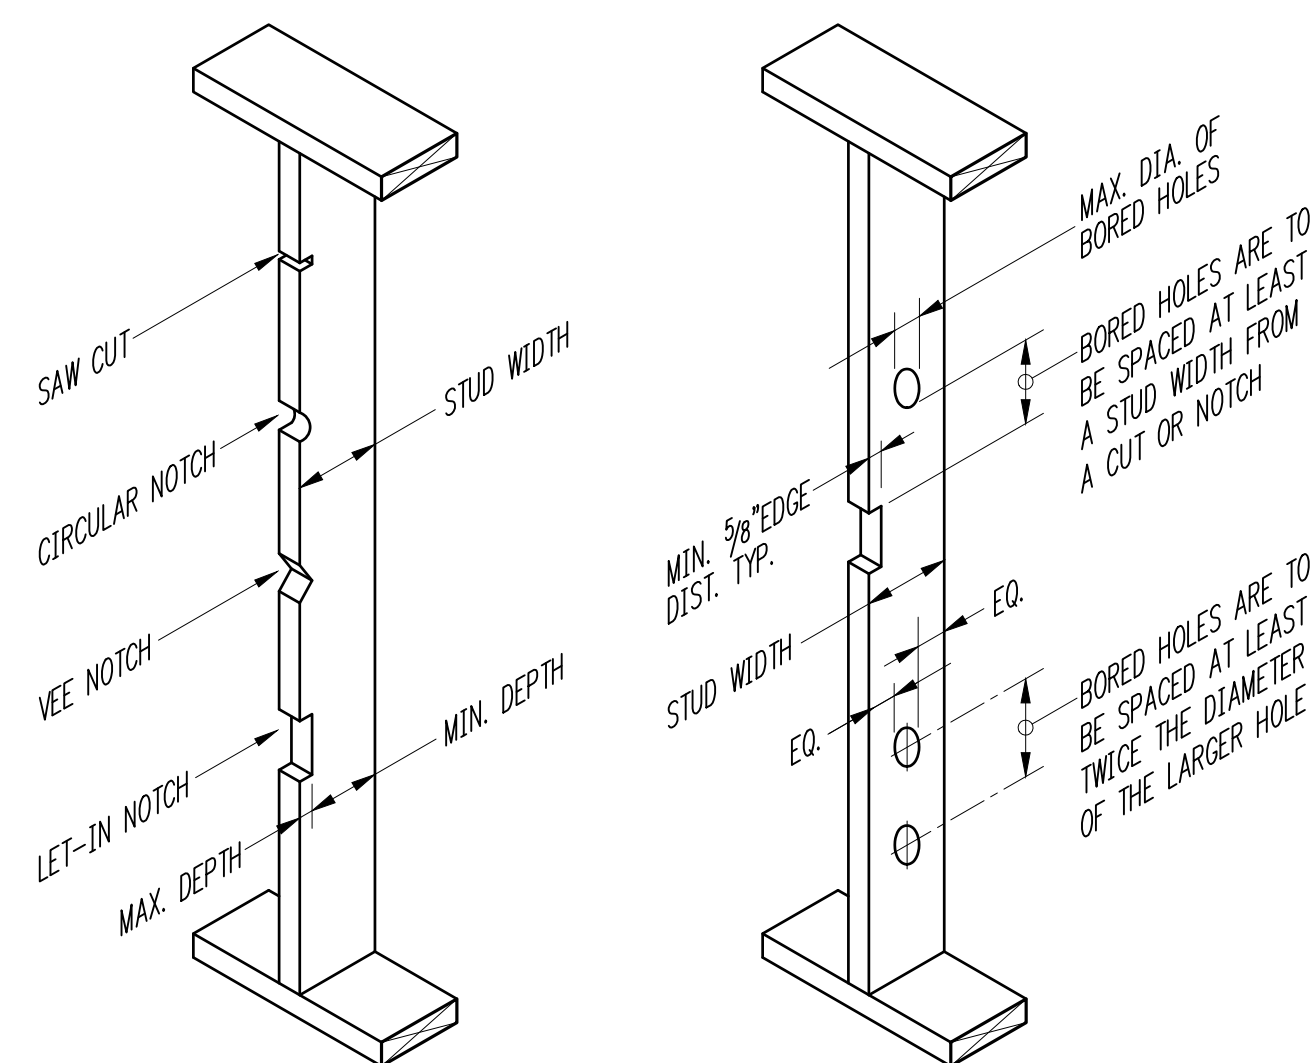

STUD SIZE	MAX DEPTH OF EDGE CUT OR NOTCH	MIN DEPTH REMAINING AFTER CUT OR NOTCH
2x4	7/8"	25/8"
2x6	13/8"	4/8"
2x8	13/4"	51/2"

BEARING WALL STUDS		
STUD SIZE	MAX DIAMETER OF BORED HOLE	MIN DEPTH REMAINING AFTER BORED HOLE
2x4	1 <sup>3</sup> / <sub>8</sub> "	5 <sup>7</sup> / <sub>8</sub> " EA SIDE OF HOLE
2x6	2 <sup>1</sup> / <sub>16</sub> "	5 <sup>7</sup> / <sub>8</sub> " EA SIDE OF HOLE
2x8	2 <sup>1</sup> / <sub>8</sub> "	5 <sup>7</sup> / <sub>8</sub> " EA SIDE OF HOLE

**NOTE:**  
STUDS MAY NOT BE BORED IN EXCESS OF 40% OF THE STUD. IF STUDS ARE DOUBLED, BORINGS MAY BE INCREASED TO 60% OF STUD WIDTH PROVIDED NOT MORE THAN (2) SUCCESSIVE STUDS ARE BORED. BORINGS SHALL NOT BE MADE AT THE SAME SECTION WHERE CUT OR NOTCH HAS BEEN MADE.

NON-BEARING WALL STUDS		
STUD SIZE	MAX DEPTH OF EDGE CUT OR NOTCH	MIN DEPTH REMAINING AFTER CUT OR NOTCH
2x4	1 3/8"	2 1/8"
2x6	2 3/16"	3 3/8"
2x8	2 7/8"	4 3/8"

NON-BEARING WALL STUDS		
STUD SIZE	MAX DIAMETER OF BORED HOLE	MIN DEPTH REMAINING AFTER BORED HOLE
2x4	2 1/16"	5/8" EA SIDE OF HOLE
2x6	3 1/4"	5/8" EA SIDE OF HOLE
2x8	4 1/4"	5/8" EA SIDE OF HOLE

NOTE:  
STUDS MAY NOT BE BORED IN EXCESS OF 60% OF THE STUD. BORINGS SHALL NOT BE MADE AT THE SAME SECTION WHERE CUT OR NOTCH HAS BEEN MADE.


## CUTTING AND NOTCHING WOOD STUDS

NOTE:  
DO NOT NOTCH MORE THAN THREE ADJACENT  
STUDS WITHOUT REVIEW BY ENGINEER.


## BORED HOLES IN WOOD STUDS

NOTE:  
BORED HOLE NOT PERMITTED IN MORE THAN THREE  
ADJACENT STUDS WITHOUT REVIEW BY ENGINEER.


## Typical Holes and Notches in Wood Studs 6

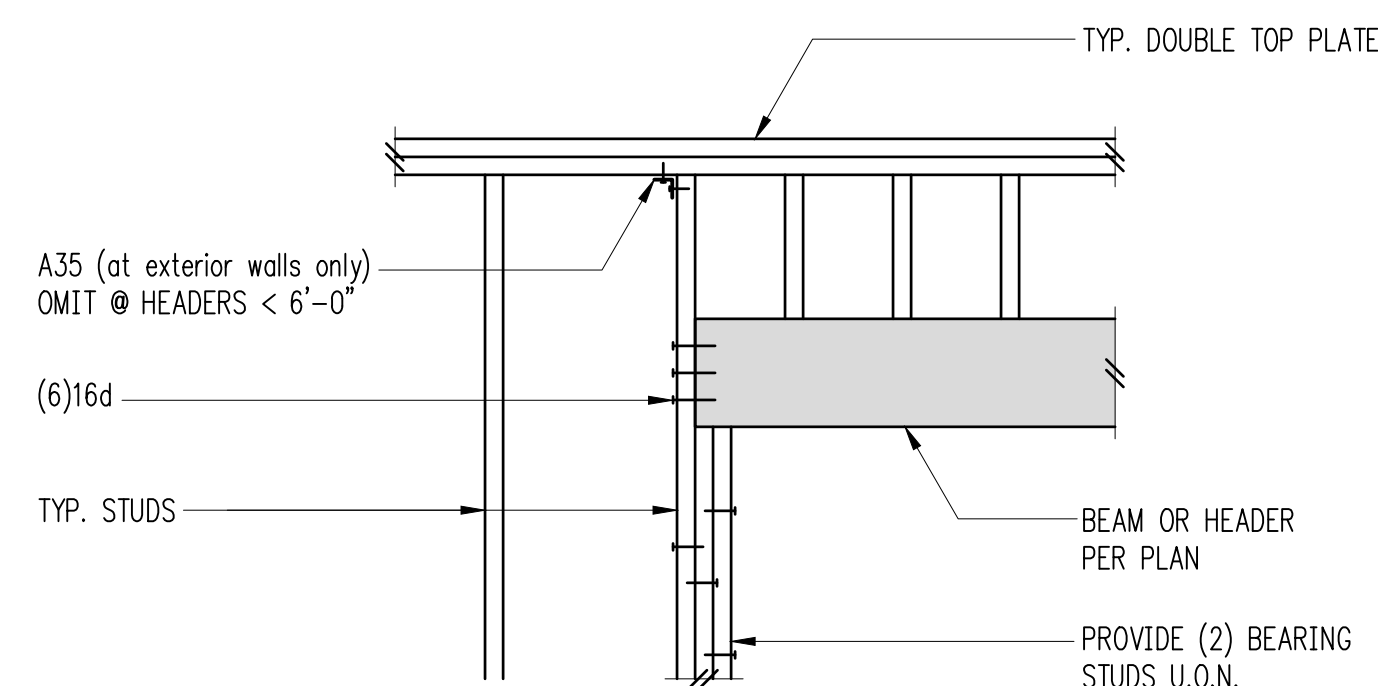

## Typical Header Support w/2 Bearing Studs

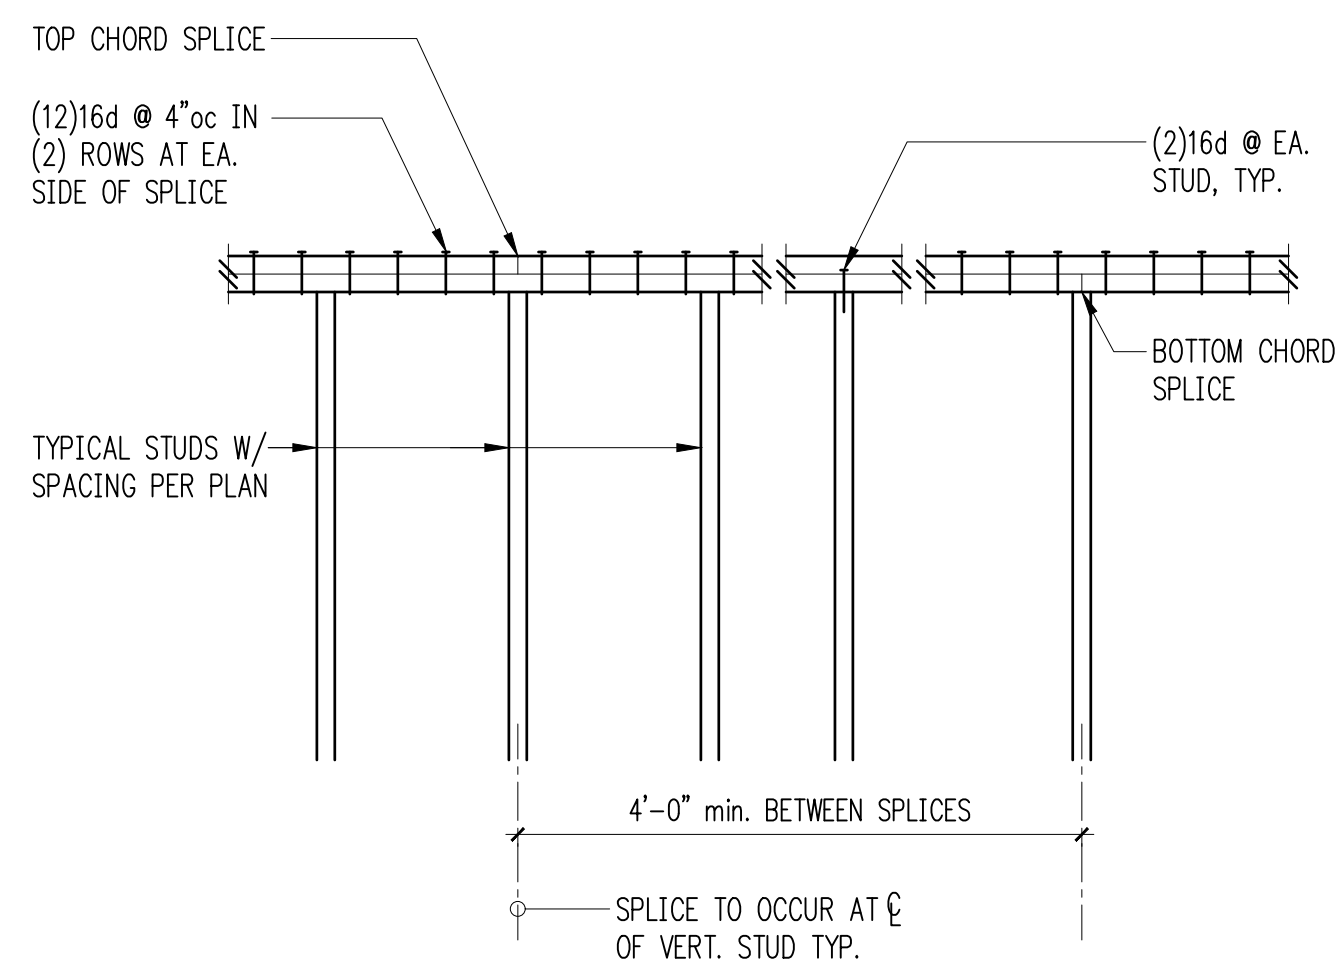


## Typical Top Plate Splice 10

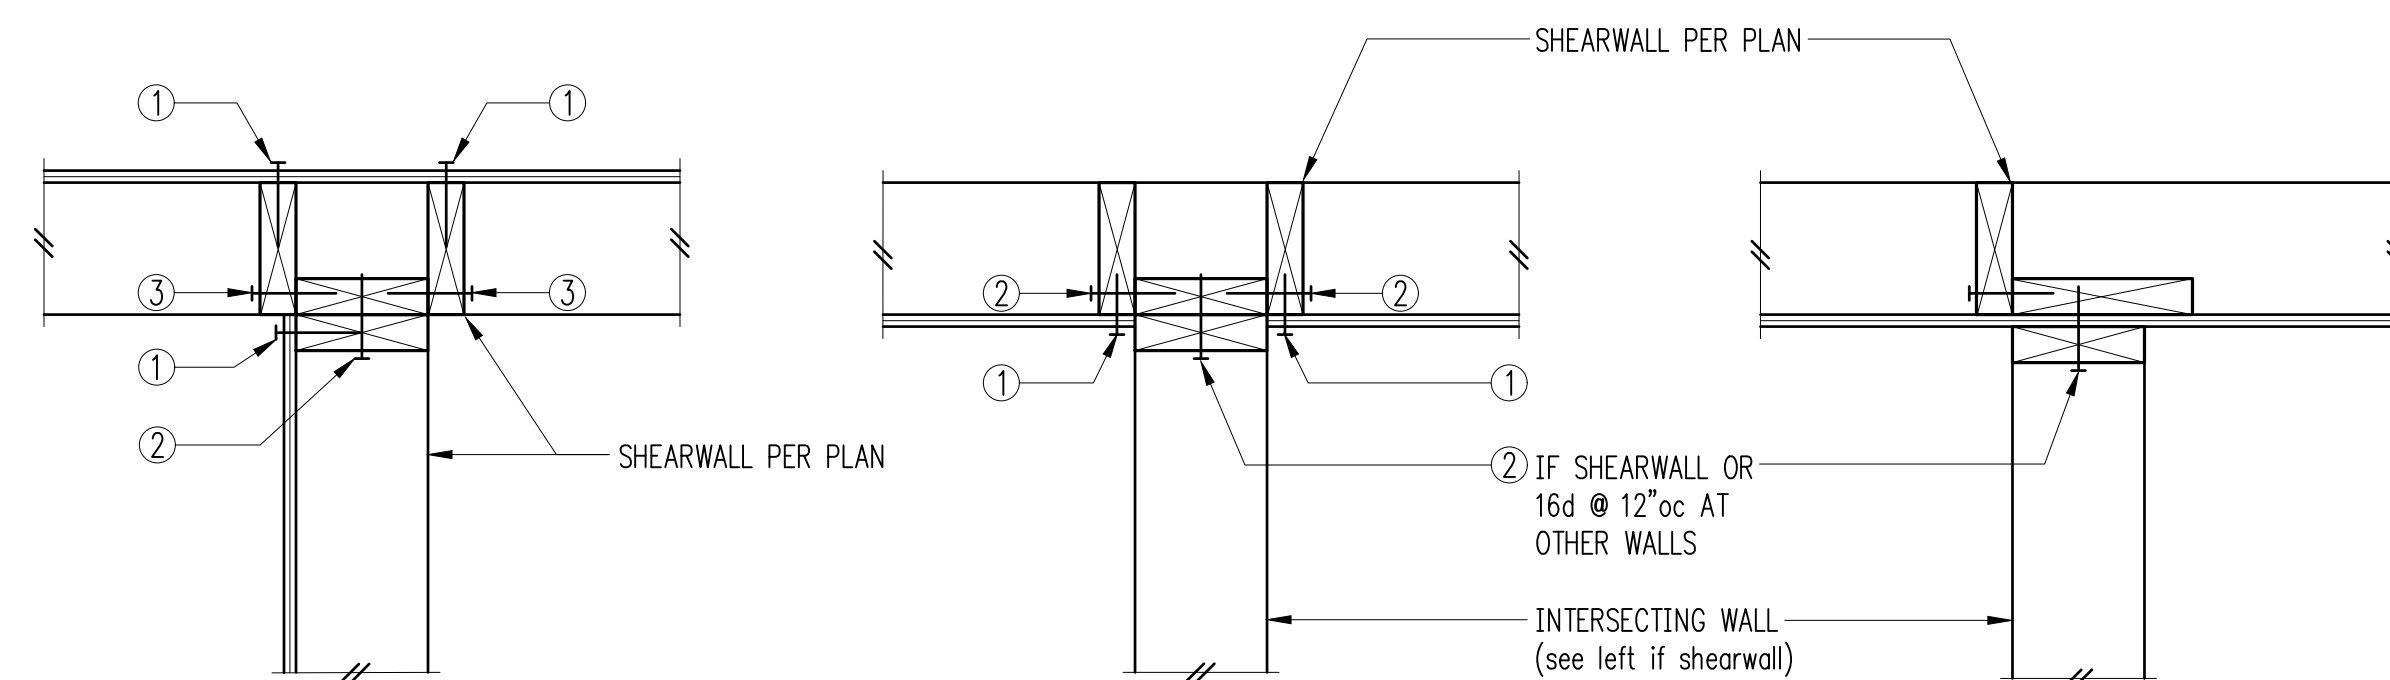

- ① PLYWOOD PANEL EDGE NAILING PER SHEARWALL SCHEDULE
- ② BASE PLATE NAILING PER SHEARWALL SCHEDULE
- ③ 16d @ 8"oc

## Typical Shearwall Intersections 4

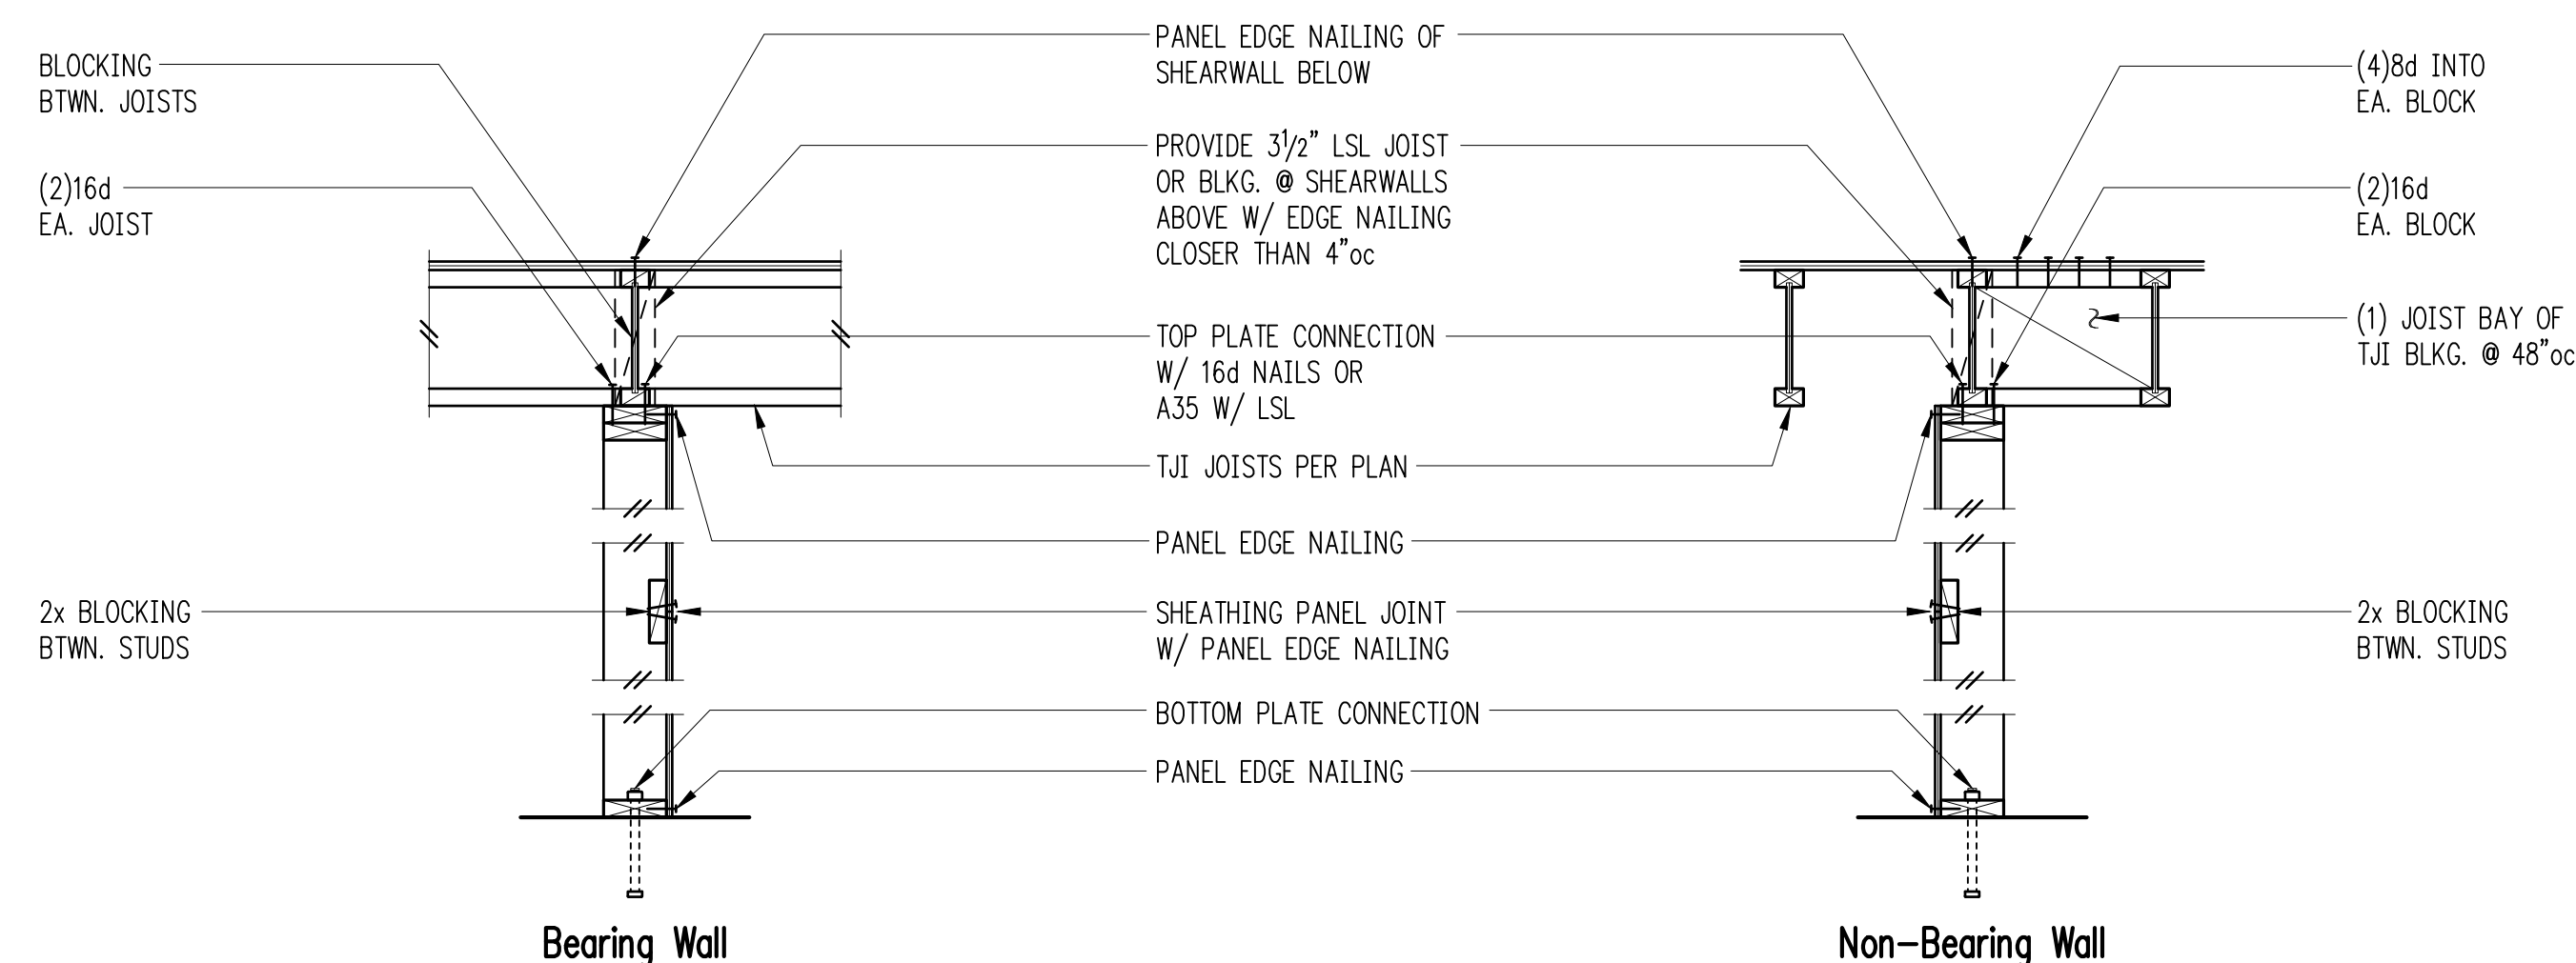

NOTE:  
SEE SHEARWALL SCHEDULE FOR ALL NAILING AND  
CONNECTIONS, NOT OTHERWISE NOTED

## Typical Shearwall Construction

## Shearwall Schedule ①②③⑥⑦⑧

Mark	Sheathing	Panel Edge Nailing	Top Plate Connection		Base Plate Connection	
			if TJI	if Wood <sup>③</sup>	at Wood <sup>⑪⑫</sup>	at Concrete
W6	15/32" CDX PLYWOOD	8d @ 6"oc	16d @ 6"oc	A35 @ 24"oc <sup>⑩</sup>	16d @ 6"oc	5/8"ø A.B. @ 48"oc
W4	15/32" CDX PLYWOOD	8d @ 4"oc	16d @ 4"oc	A35 @ 16"oc <sup>⑩</sup>	(2)rows 16d @ 6"oc	5/8"ø A.B. @ 32"oc
W3 <sup>④</sup>	15/32" CDX PLYWOOD	8d @ 3"oc	(2)rows 16d @ 4"oc	A35 @ 12"oc <sup>⑩</sup>	(2)rows 16d @ 6"oc	5/8"ø A.B. @ 24"oc
W2 <sup>④</sup>	15/32" CDX PLYWOOD	8d @ 2"oc	(2)rows 16d @ 4"oc	A35 @ 9"oc <sup>⑩</sup>	(2)rows 16d @ 4"oc <sup>⑬</sup>	5/8"ø A.B. @ 16"oc
2W3 <sup>⑤</sup>	15/32" CDX PLYWD. EA. SIDE	8d @ 3"oc EA. SIDE	n/a	A35 @ 6"oc	(3)rows 16d @ 4"oc <sup>⑬</sup>	5/8"ø A.B. @ 16"oc
2W2 <sup>⑤</sup>	15/32" CDX PLYWD. EA. SIDE	8d @ 2"oc EA. SIDE	n/a	HGA10KT @ 8"oc	(3)rows 16d @ 4"oc <sup>⑬</sup>	5/8"ø A.B. @ 12"oc
2W2-10 <sup>⑤</sup>	15/32" CDX PLYWD. EA. SIDE	10d @ 2"oc EA. SIDE	n/a	HGA10KT @ 6"oc	(4)rows 16d @ 4"oc <sup>⑬</sup>	5/8"ø A.B. @ 12"oc

- ① BLOCK PANEL EDGES WITH 2x MIN. LAID FLAT AND PANEL PANELS TO INTERMEDIATE SUPPORTS WITH 8d @ 12" o.c.
- ② 8d NAILS SHALL BE 0.131" x 2 1/2" (common) - 16d NAILS SHALL BE 0.135" x 3 1/2" (box) - 10d NAILS SHALL BE 0.148" x 3" (common).
- ③ EMBED ANCHOR BOLTS AT LEAST 7". DRILLED AND EPOXYED THREADED ROD MAY BE SUBSTITUTED FOR ANCHOR BOLTS WITH 6" EMBEDMENT.
- ④ TITEN HD SCREW ANCHORS MAY BE SUBSTITUTED FOR ANCHOR BOLTS W/ 4" EMBEDMENT. ALL BOLTS SHALL HAVE 3" x 3" x 1/4" MIN. PLATE WASHERS. PLATE WASHERS SHALL EXTEND TO WITHIN 1/2" OF THE EDGE OF THE BOTTOM PLATE ON THE SIDE WITH SHEATHING. SEE DETAIL C.
- ⑤ 3x STUDS OR DOUBLE STUDS NAILED TOGETHER W/ BASE PLATE NAILING ARE REQUIRED AT ABUTTING PANEL EDGES OF W3 AND W2. SEE DETAIL B. WHERE 3x STUDS ARE USED FOR W2, STAGGER NAILS AT ADJOINING PANEL EDGES.
- ⑥ 3x FOUNDATION SILL PLATES ARE REQUIRED FOR 2W3 AND 2W2. 3x STUDS ARE REQUIRED AT ABUTTING PANEL EDGES AND PANEL JOINTS SHALL BE OFFSET EACH SIDE OF WALL. STAGGER NAILS AT ADJOINING PANEL EDGES. 3x STUD, MIN., REQUIRED AT END OF SHEARWALL.
- ⑦ TWO STUDS MINIMUM ARE REQUIRED AT EACH END OF ALL SINGLE-SIDED SHEARWALLS. ALL END STUDS SHALL RECEIVE PANEL EDGE NAILING. SEE PLANS AND HOLDOWN SCHEDULE FOR ALTERNATE REQUIREMENTS.
- ⑧ ALL EXTERIOR WALLS SHALL BE W6, UNLESS NOTED OTHERWISE.
- ⑨ 7/16" O.S.B. MAY BE SUBSTITUTED FOR 15/32" CDX, EXCEPT AT 10d PANEL EDGE NAILING.
- ⑩ LTP4's (HORIZONTAL ORIENTATION) W/ 8d COMMON MAY BE SUBSTITUTED FOR A35's AT CONTRACTORS OPTION.
- ⑪ A 2x NAILER ATTACHED W/ BASE PLATE NAILING PER DETAIL A MAY BE SUBSTITUTED FOR A35's AT CONTRACTORS OPTION.
- ⑫ AT MULTI-ROW NAILING, MINIMUM OFFSET BETWEEN ROWS AND ROW SPACING 1/2", SEE DETAIL D.
- ⑬ LVL RIMS PERMITTED AT SINGLE SIDED SHEAR WALLS ONLY.
- ⑭ PROVIDE (3) ROWS 16d @ 6" o.c AT LVL RIMS.
- ⑮ MINIMUM RIM OR JOIST 3/2" WIDE BELOW SHEARWALL.

ALL. Shearwall Schedule - (Sheathed One & Two Sides) 12

**PRELIMINARY  
NOT FOR  
CONSTRUCTION**

DRAWN:	RJ
DESIGN:	AGL
CHECKED:	AGL
APPROVED:	

REVISIONS:

JURISDICTIONAL APPROVAL STAMP:

PROJECT TITLE: \_\_\_\_\_

Ojai Permanent  
Supportive Housing  
611 S Montgomery St  
Ojai, CA

ARCHITECT:  
DJA Architects

ISSUE:

## Design Development

**SHEET TITLE:**

## Wood Framing Details

SCALE: 


DATE: 25 July 2025

PROJECT NO: 02061-2025-01


SHEET NO: \_\_\_\_\_

## S4.1




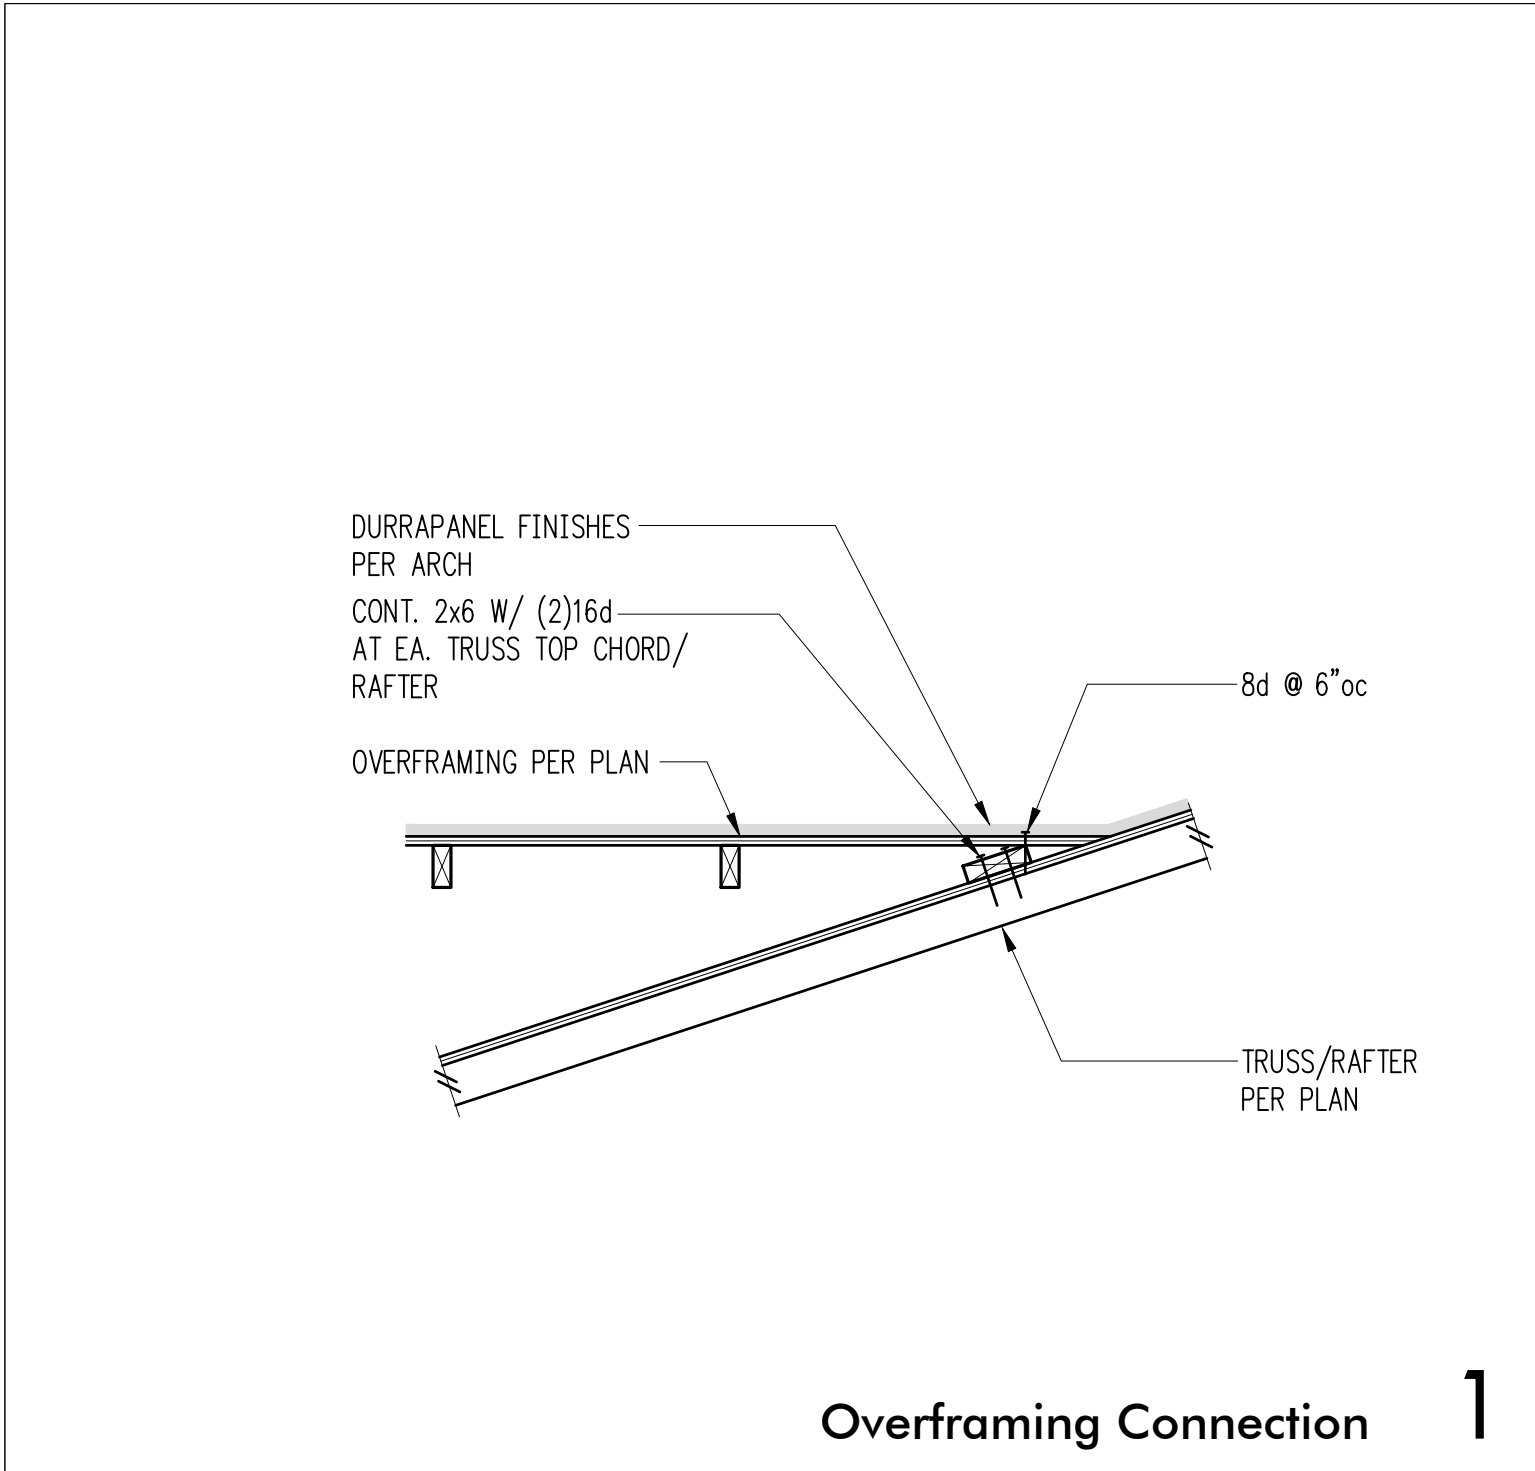


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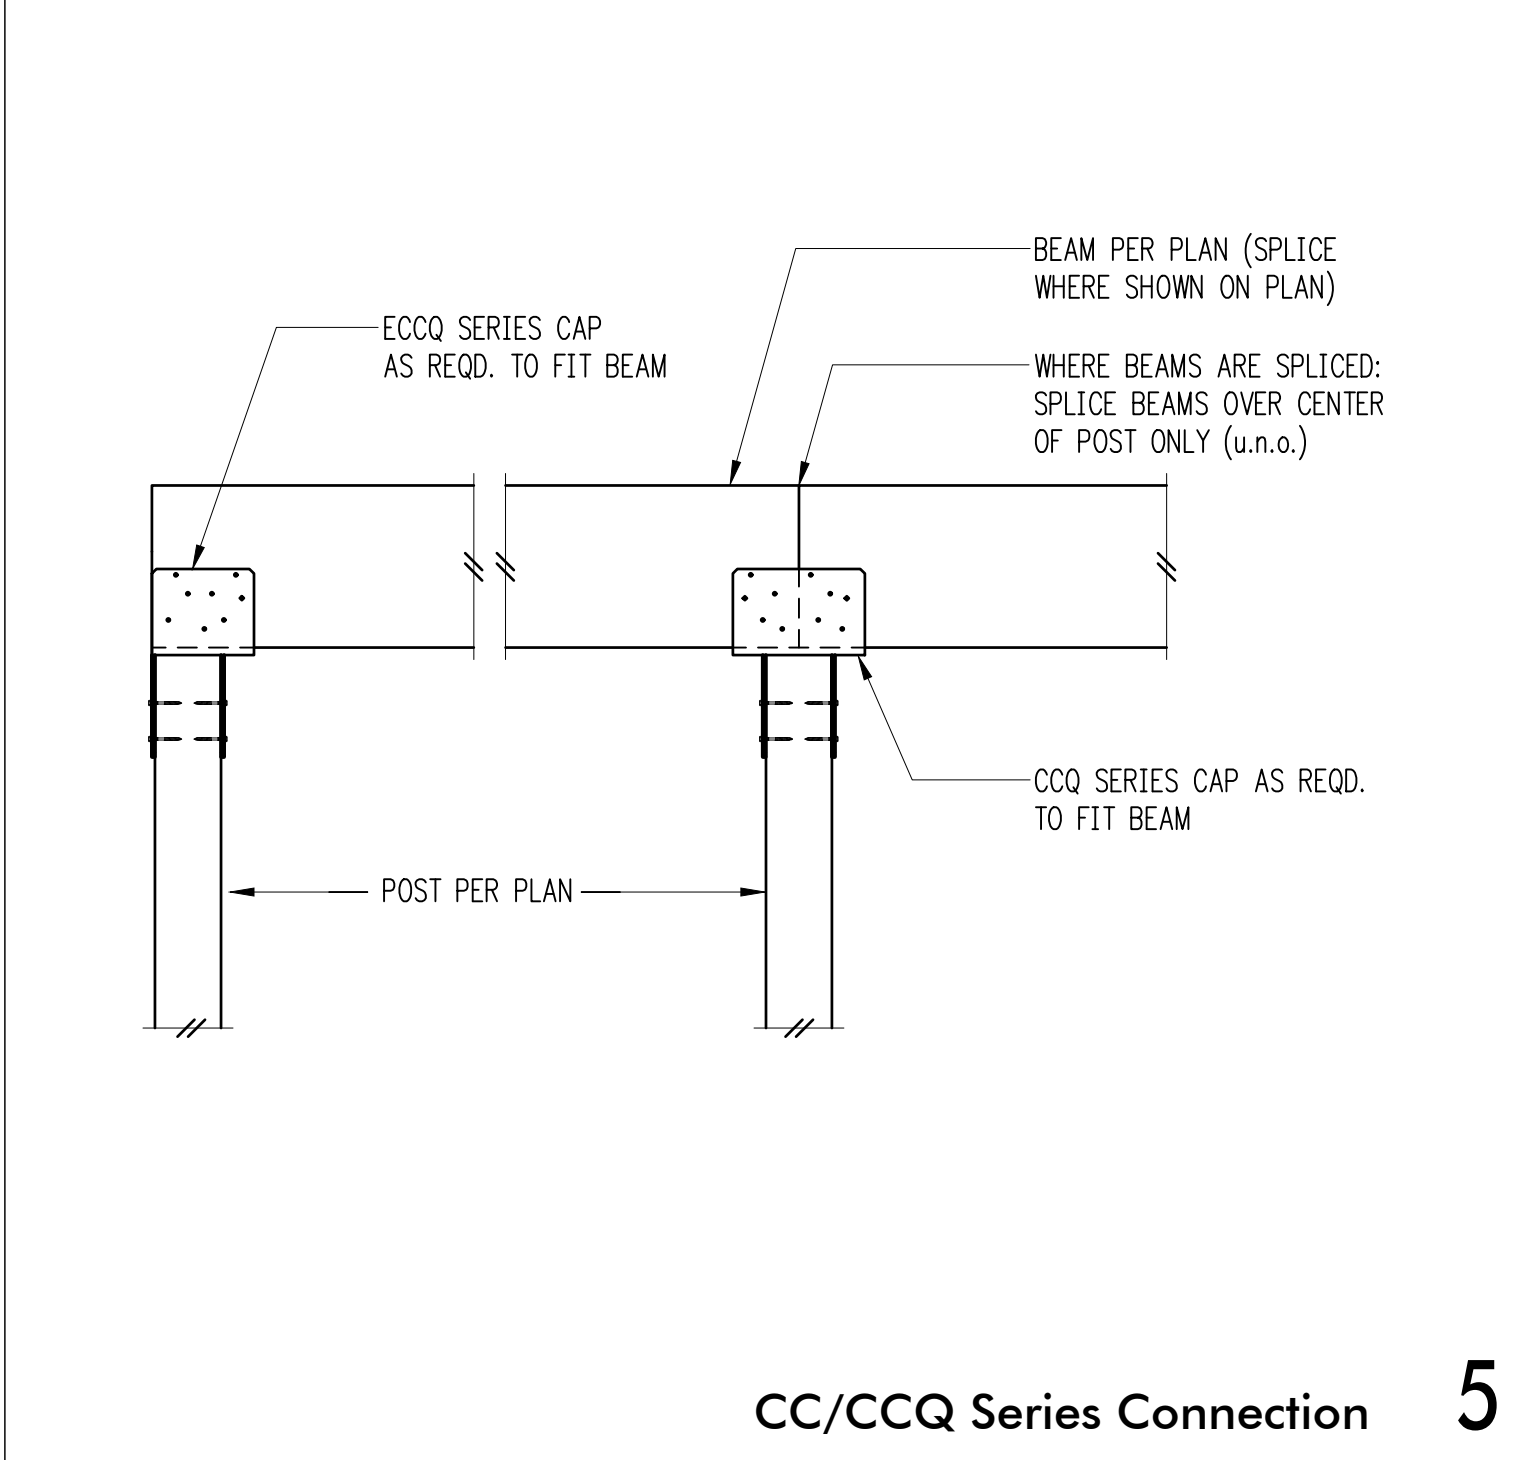
Exterior Bearing Wall 2

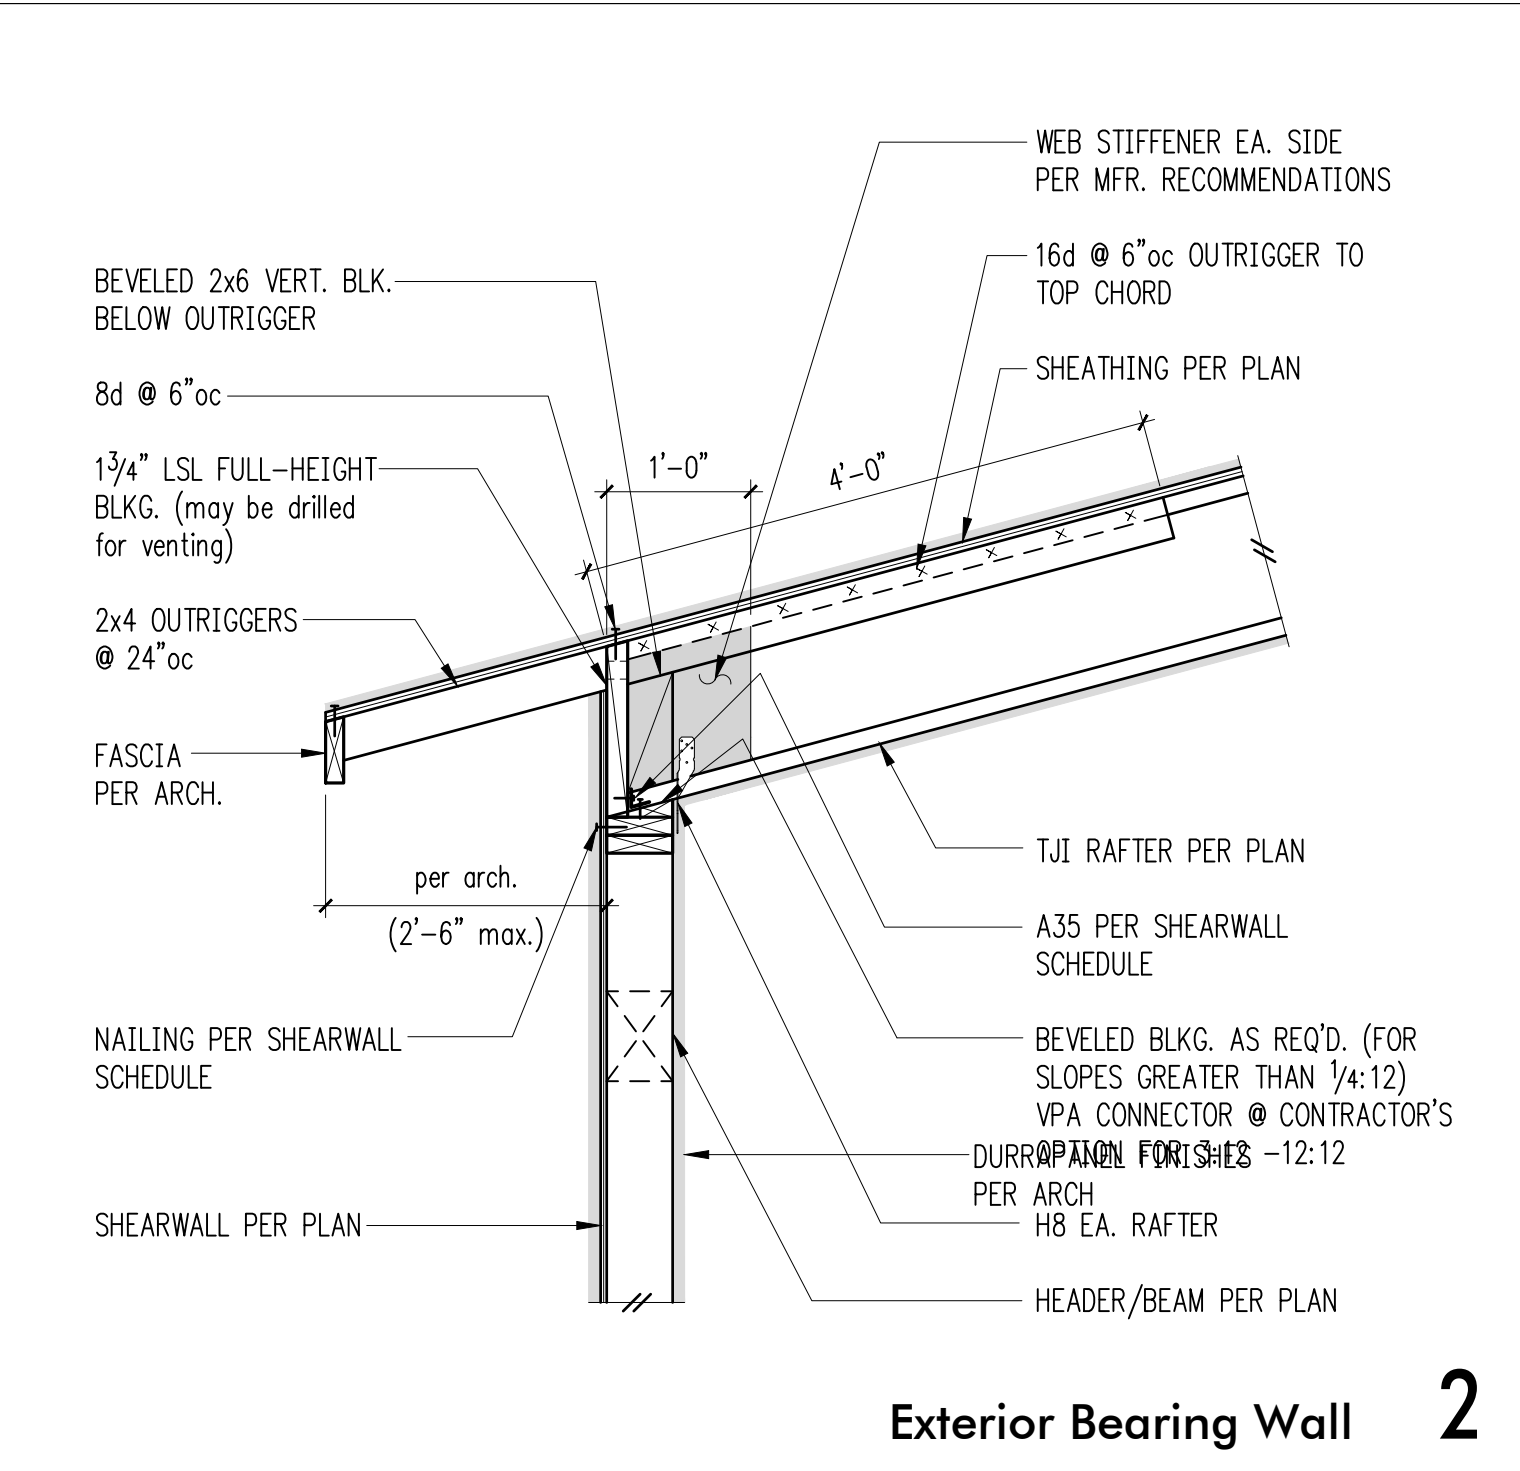


Ridge Beam w/ LSSR Hangers 3

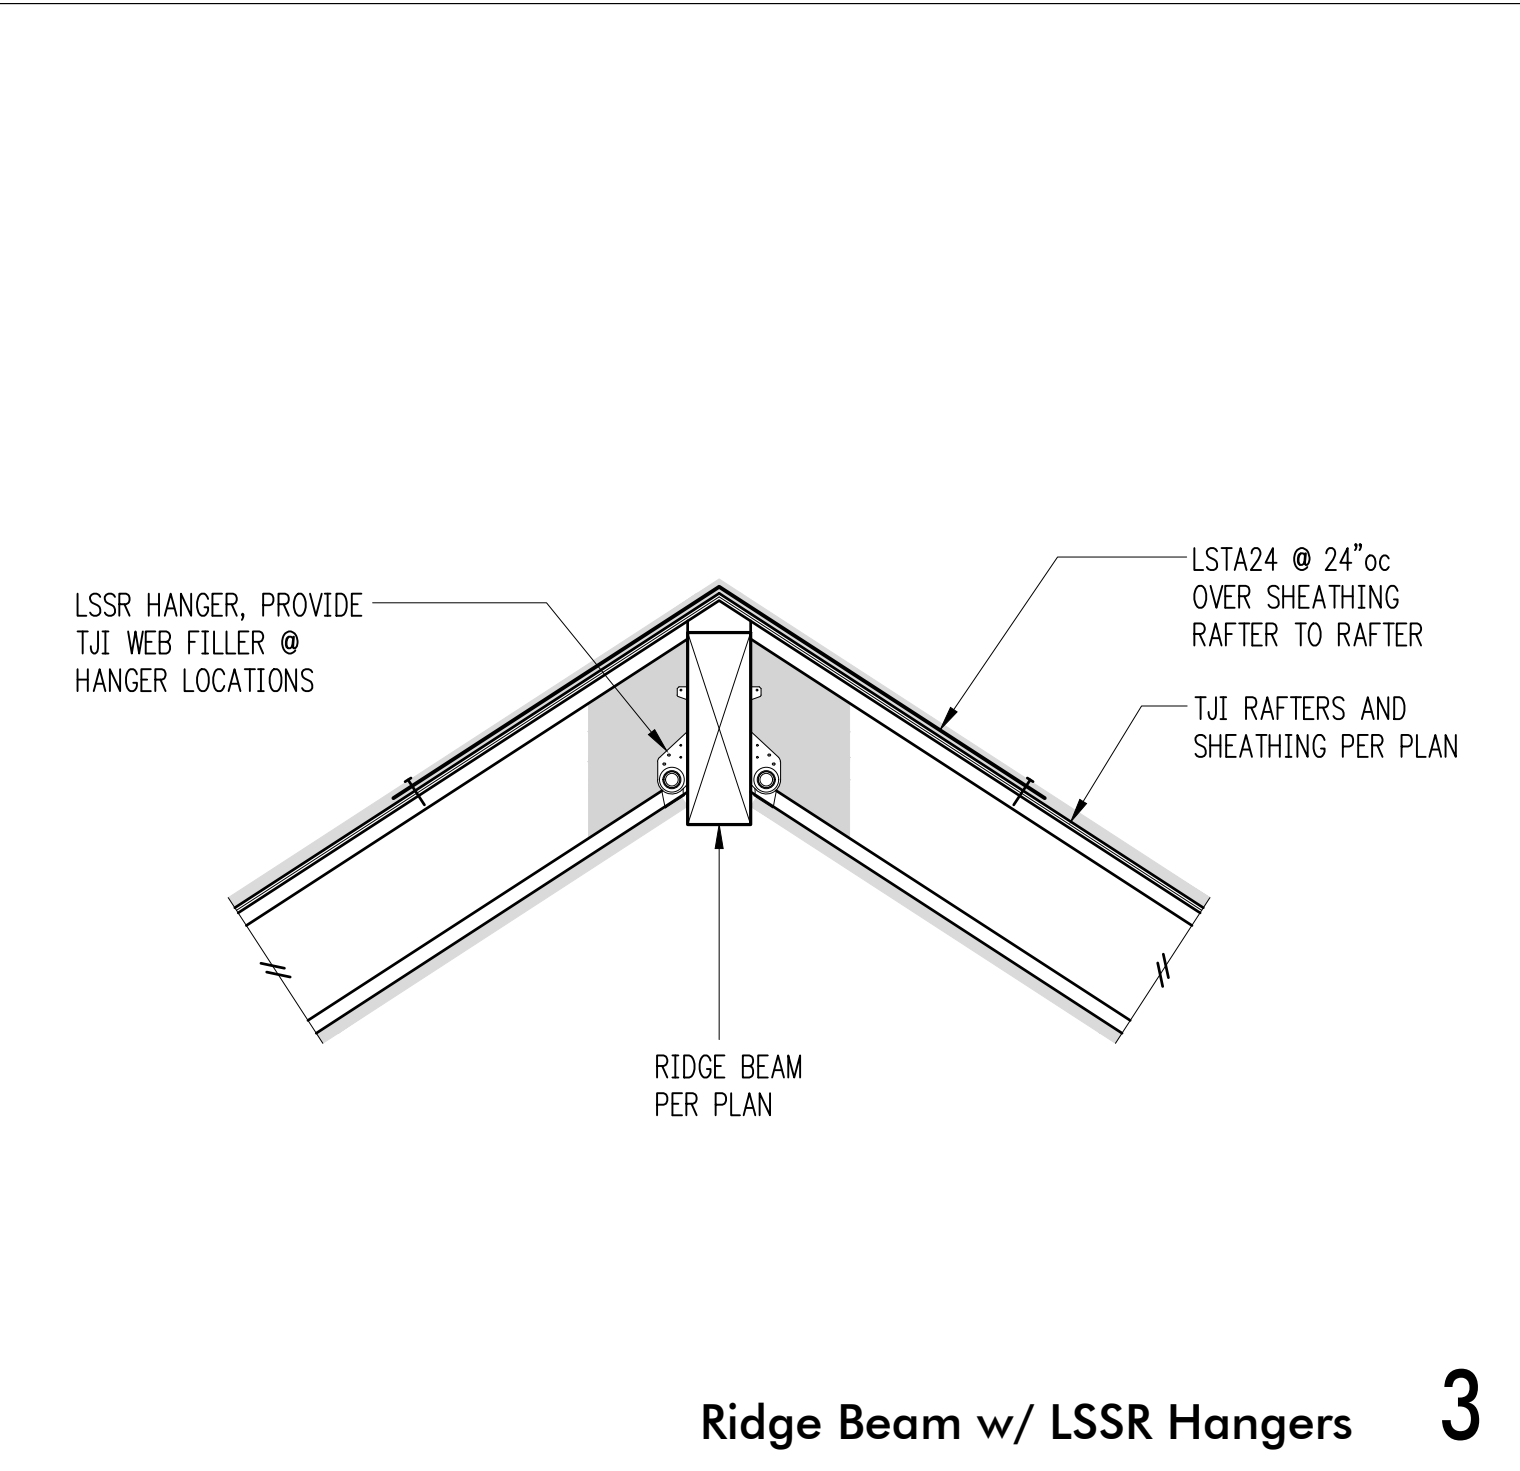


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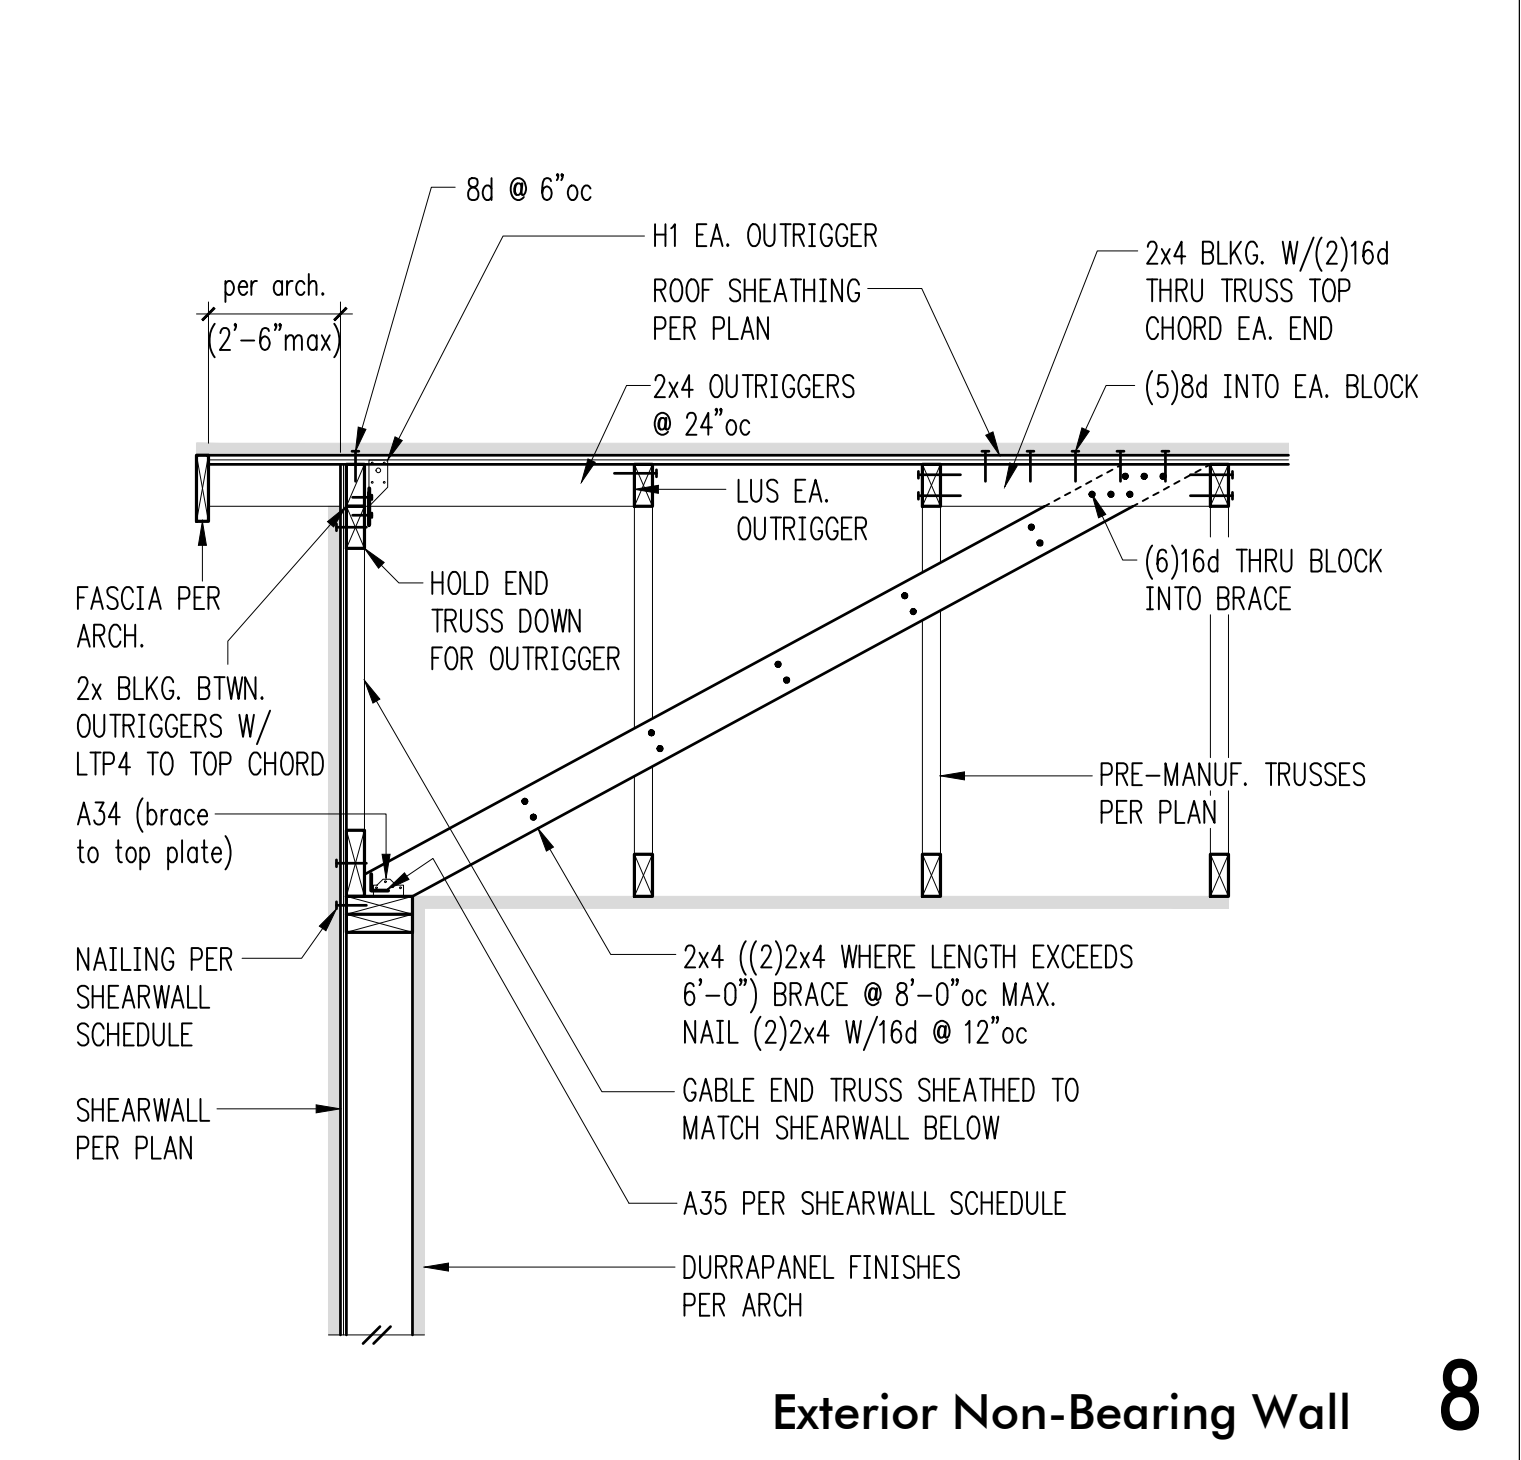
CC/CCQ Series Connection 5

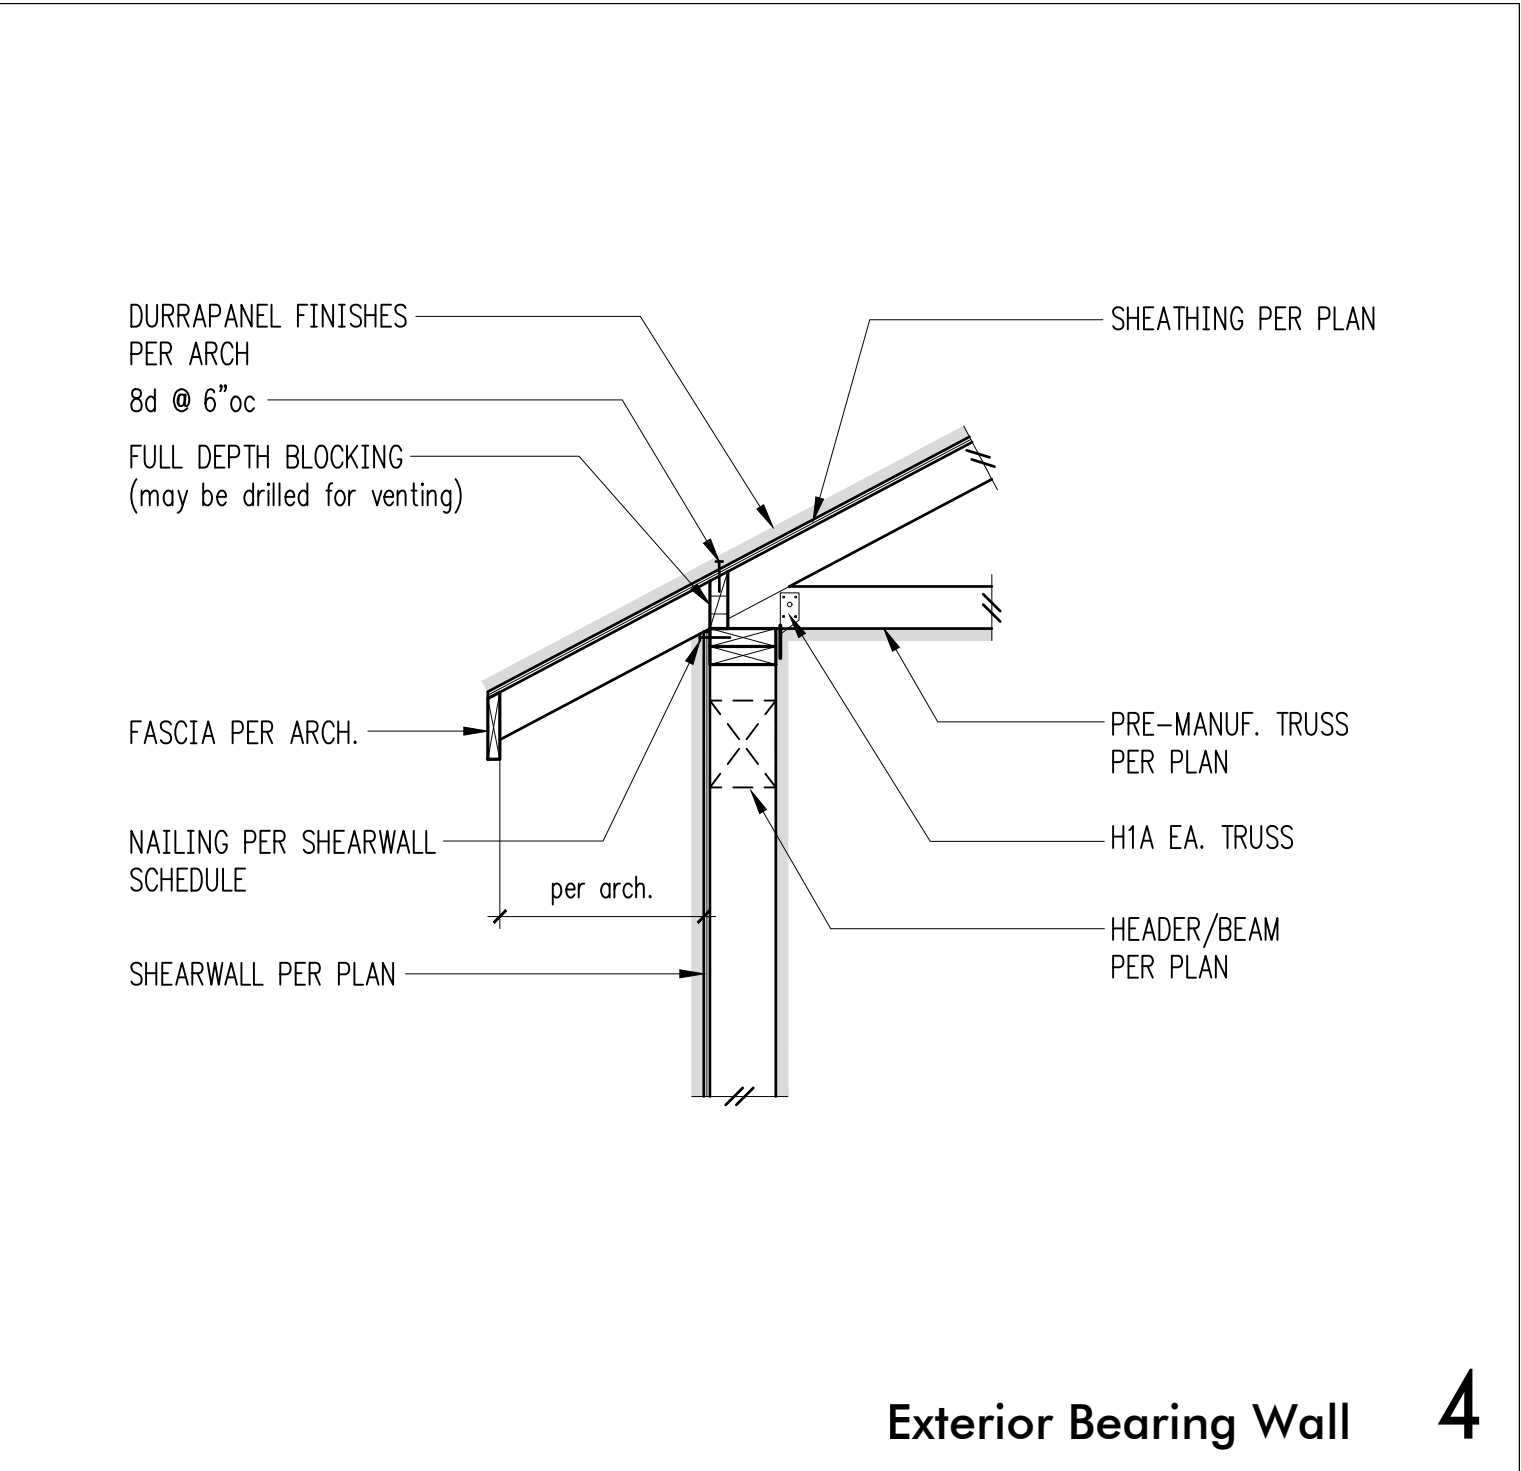


Exterior Non-Bearing Wall 6

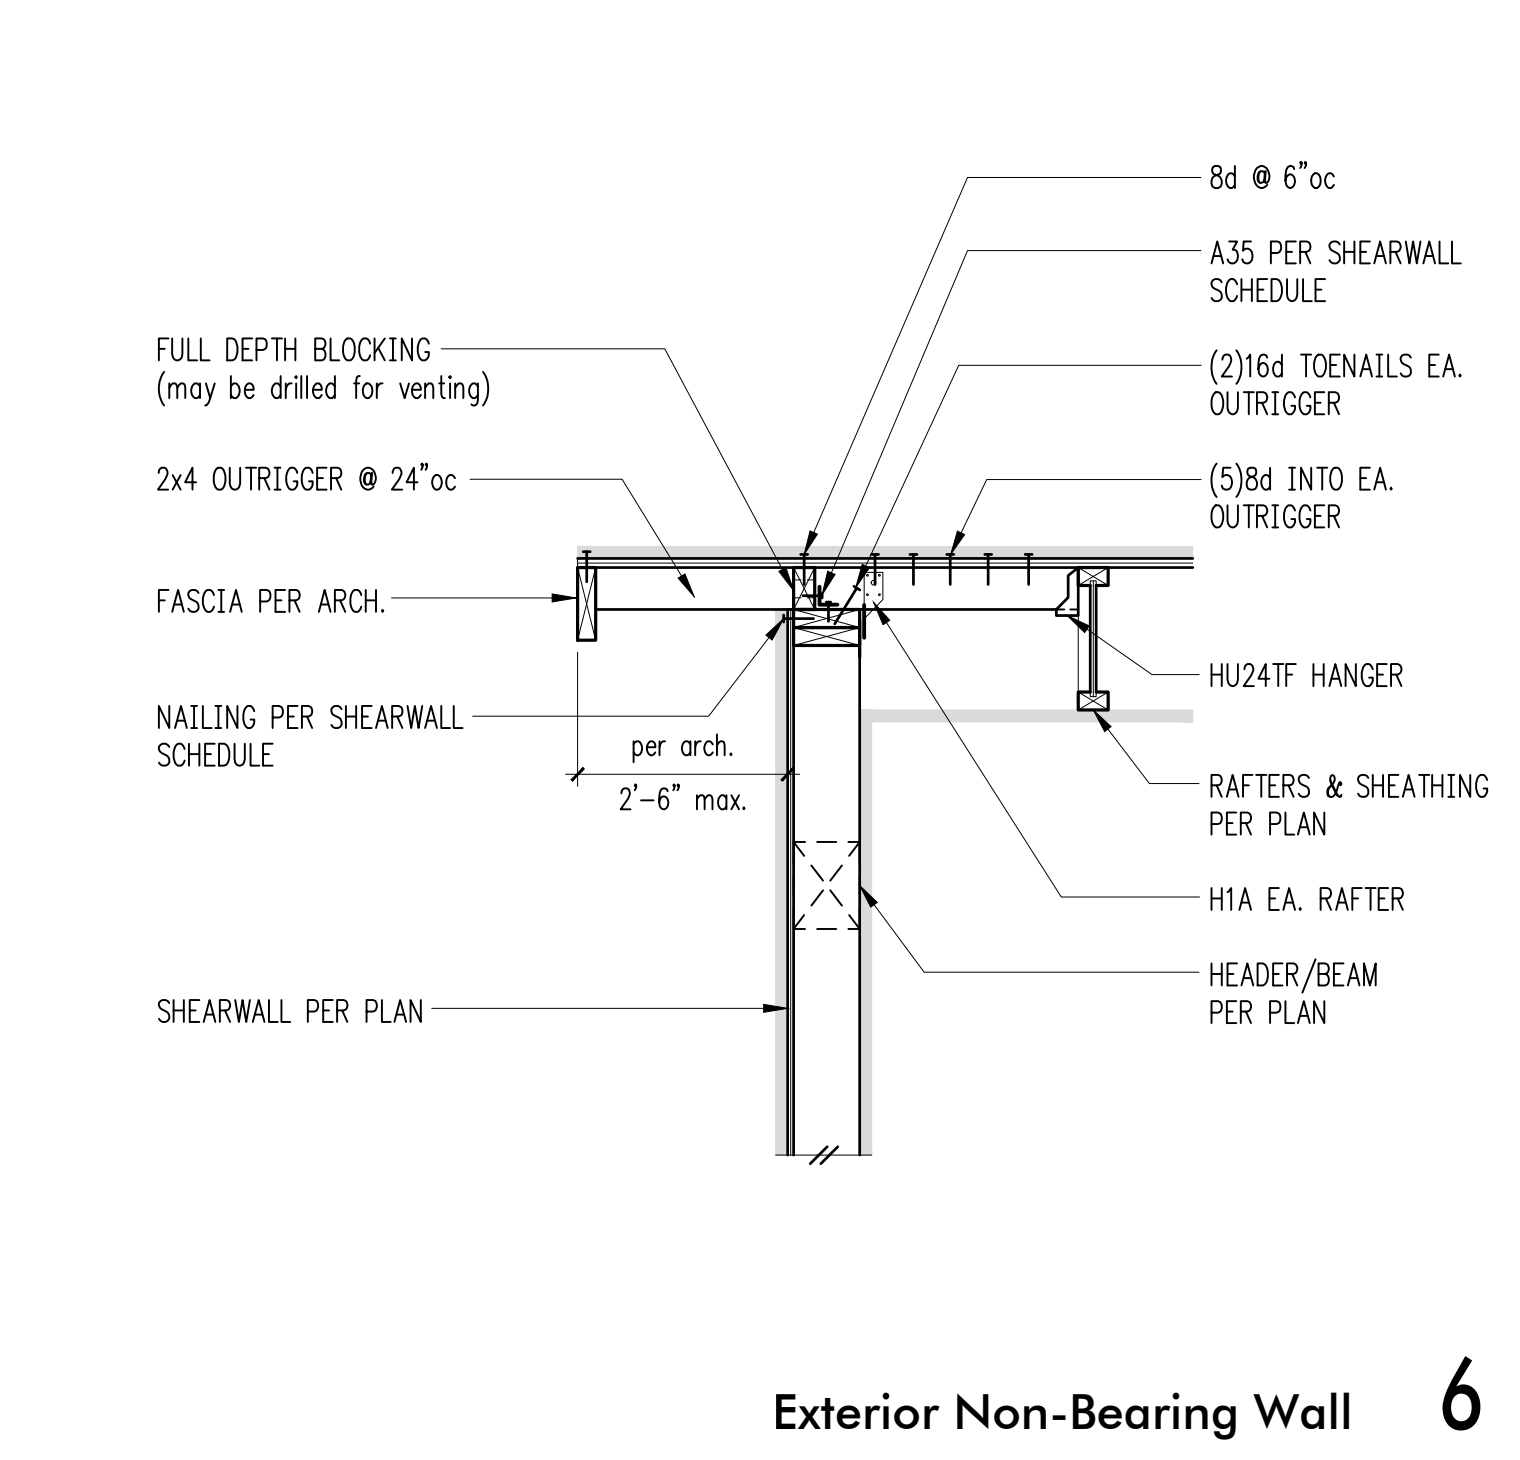


Shearwall Extension Thru Truss Depth (perpendicular to truss) 7

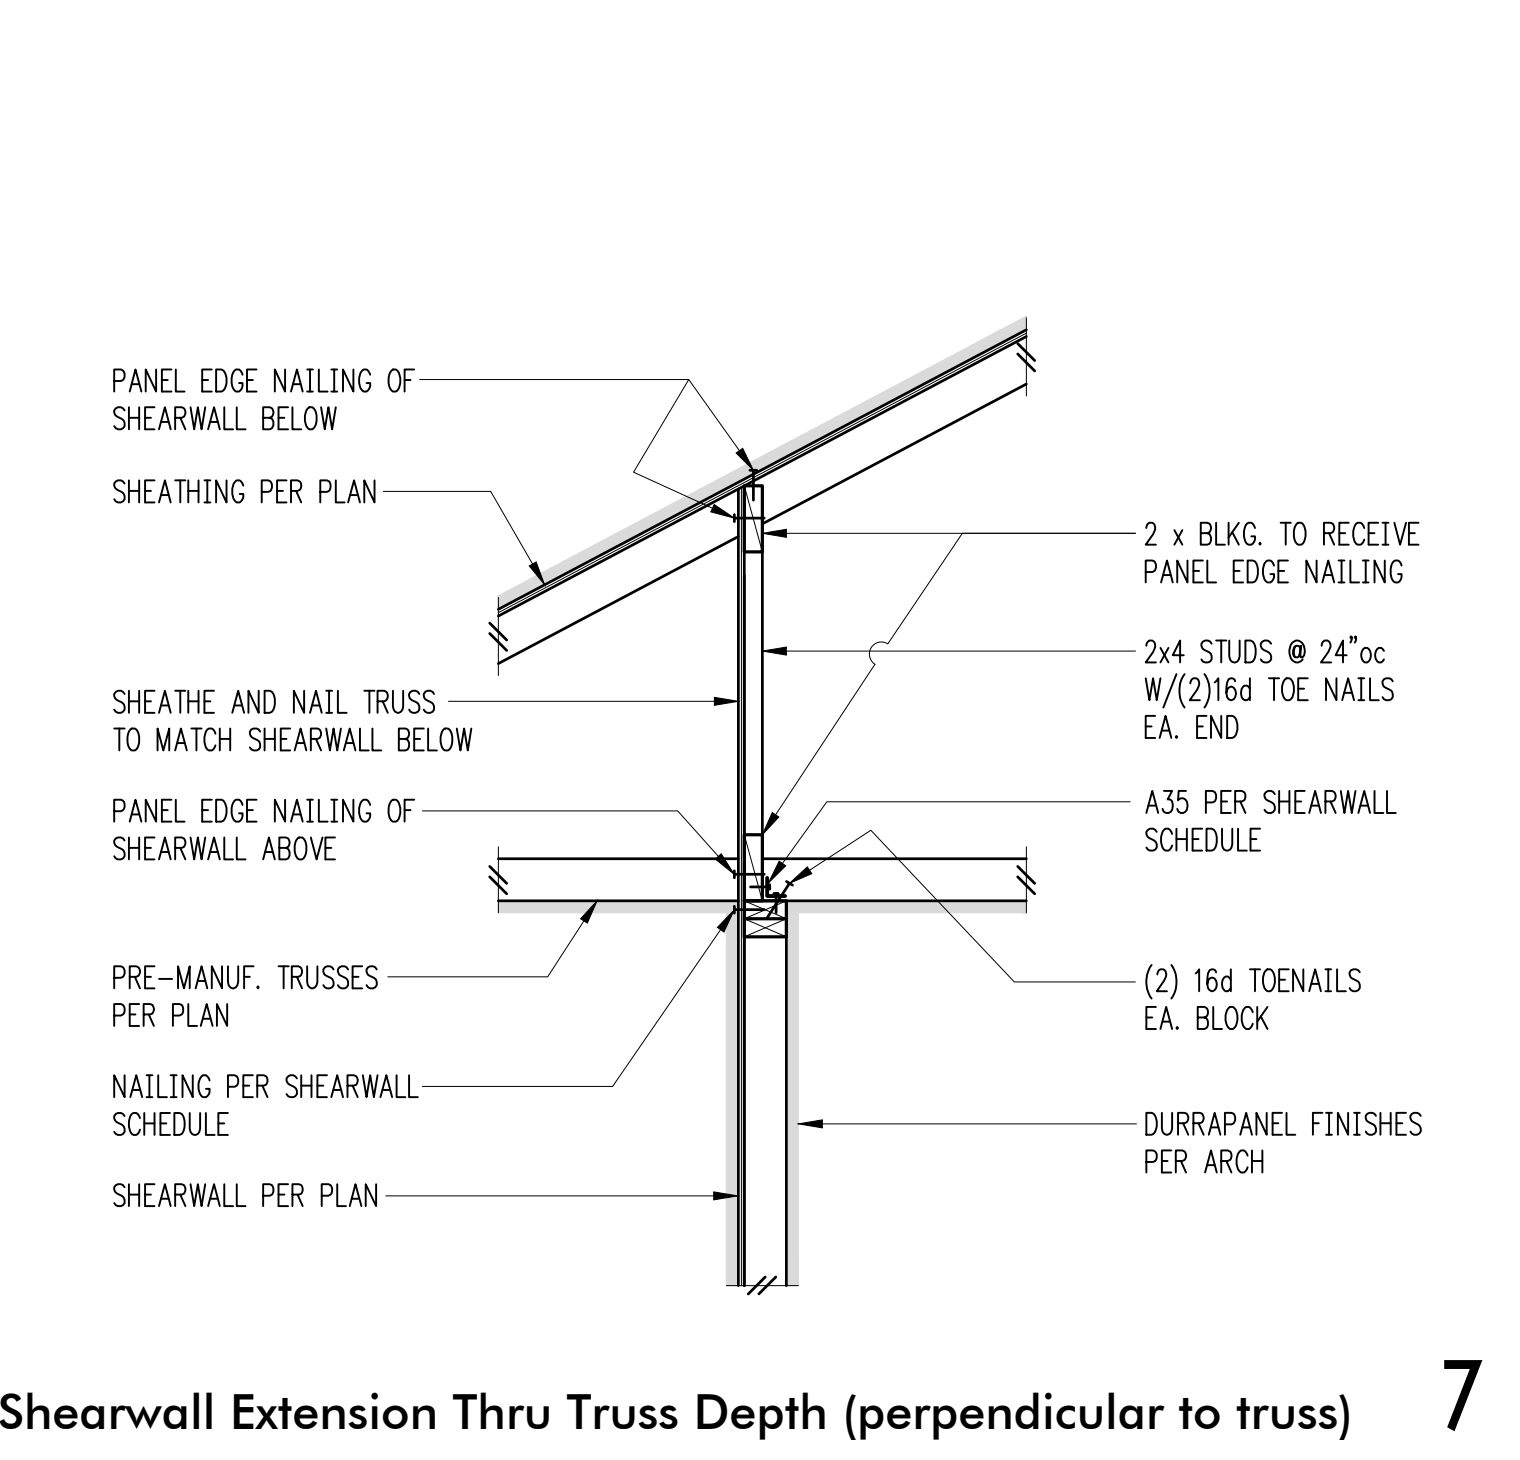


Exterior Non-Bearing Wall 8

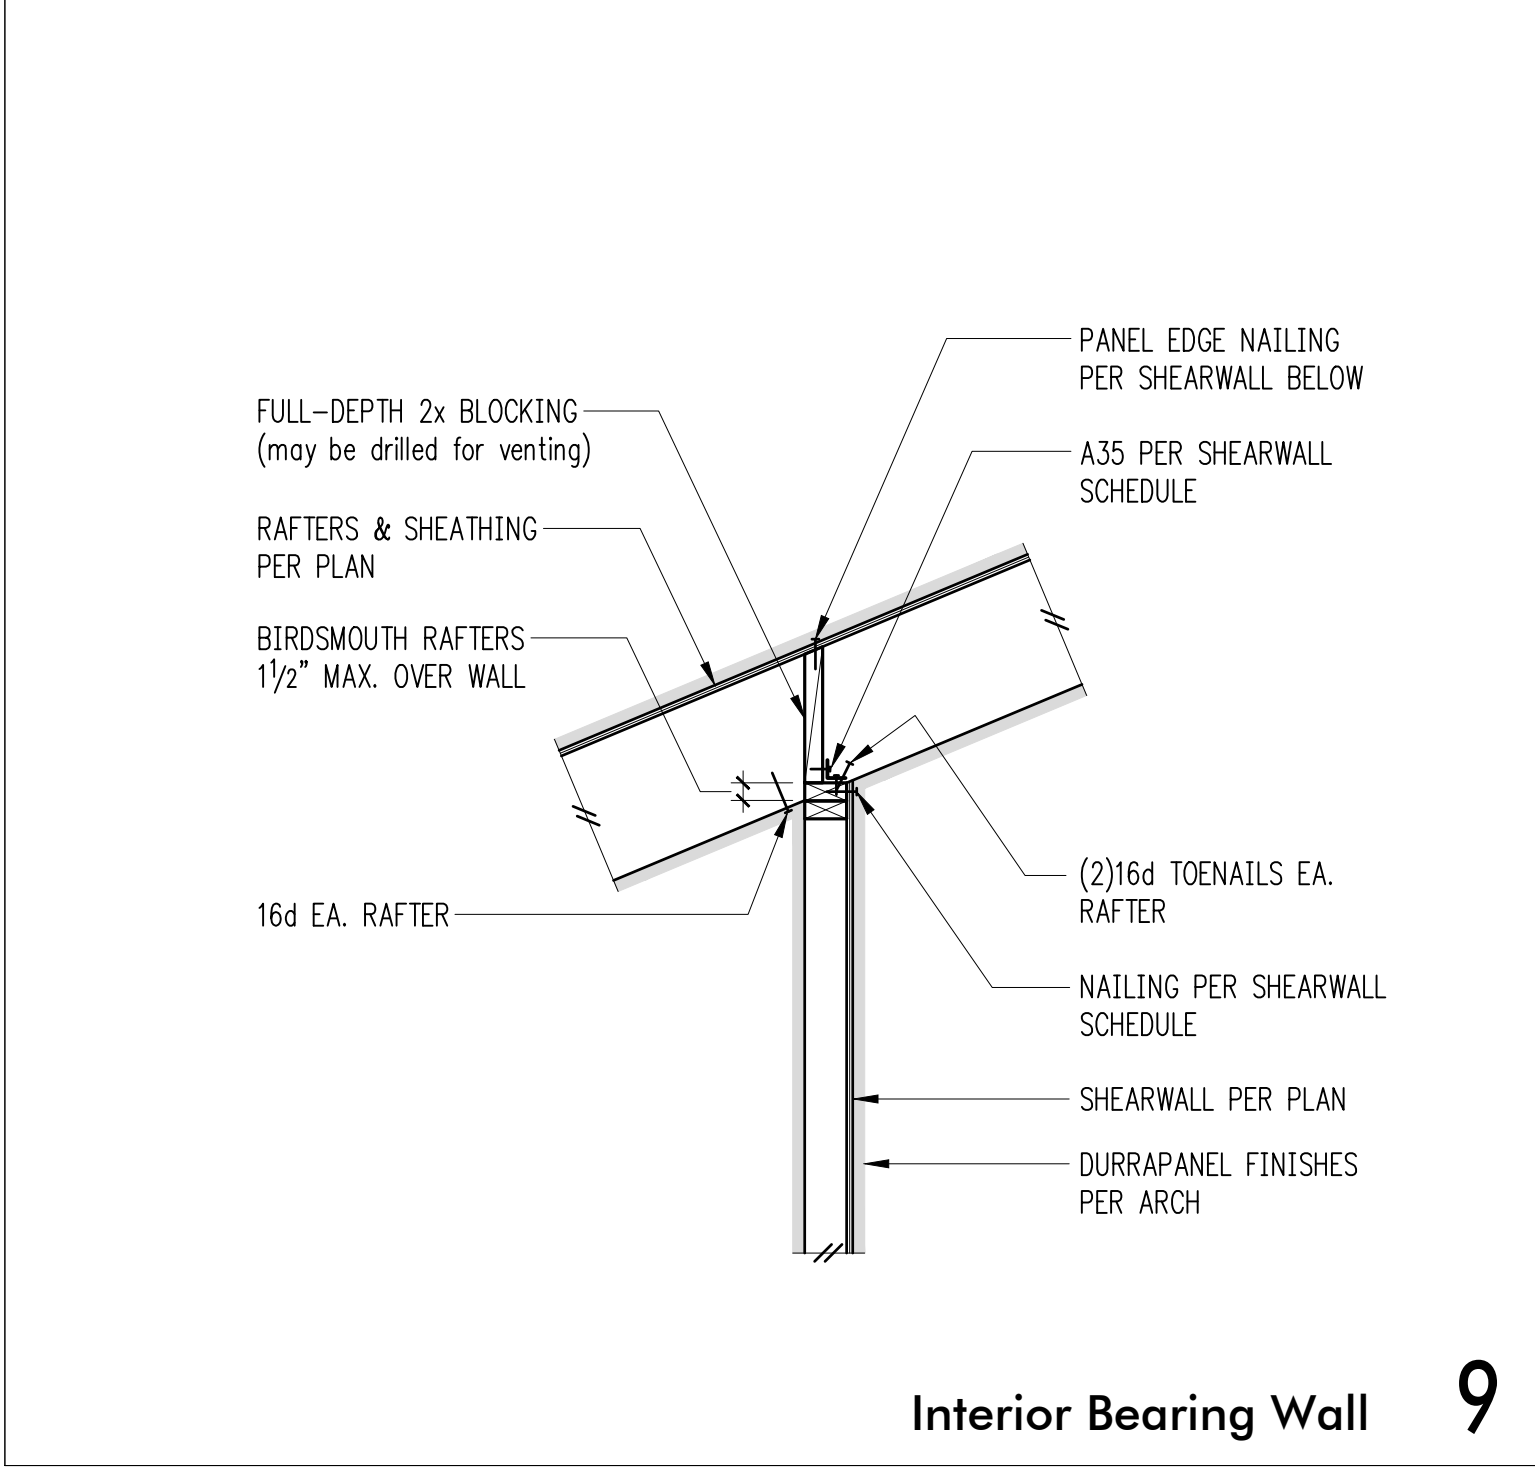


Interior Bearing Wall 9

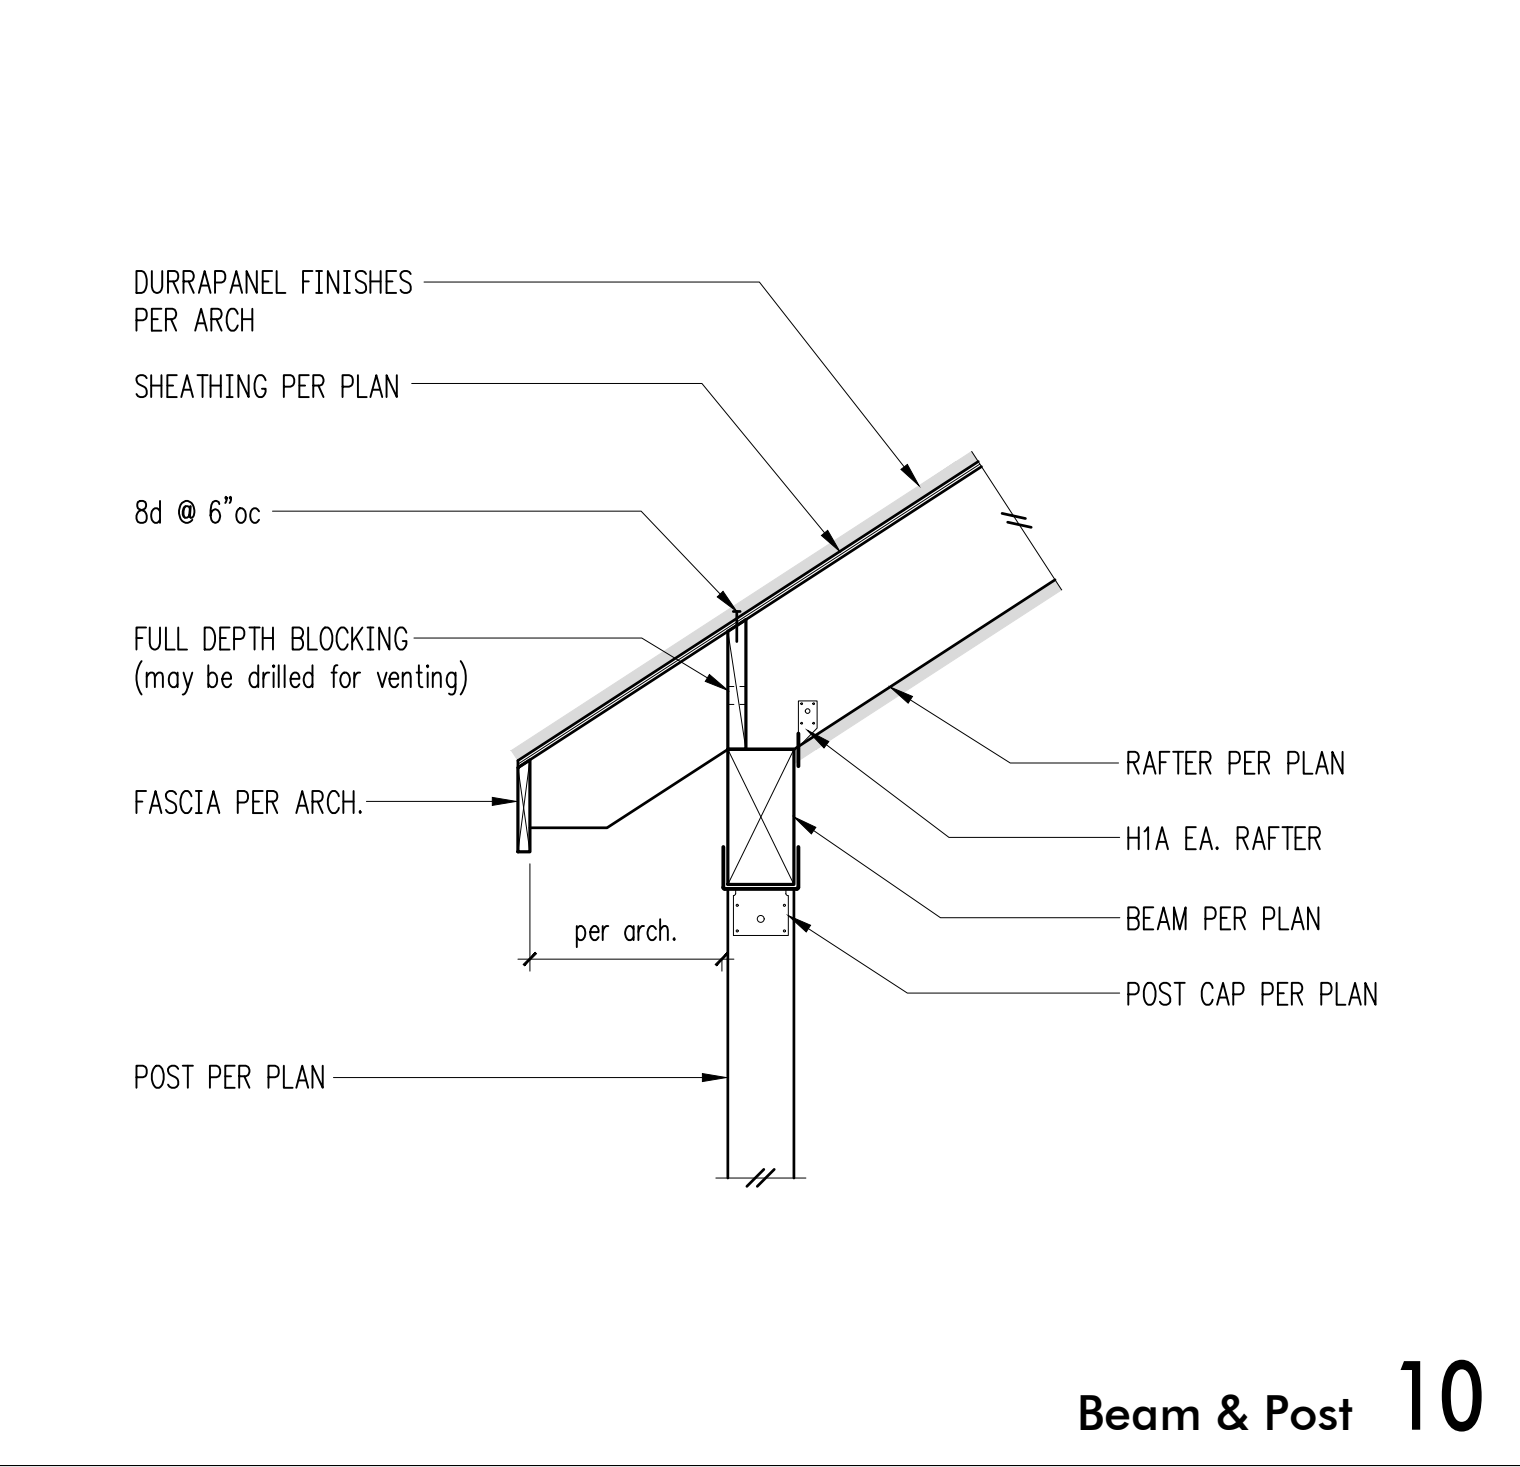

Beam & Post 10

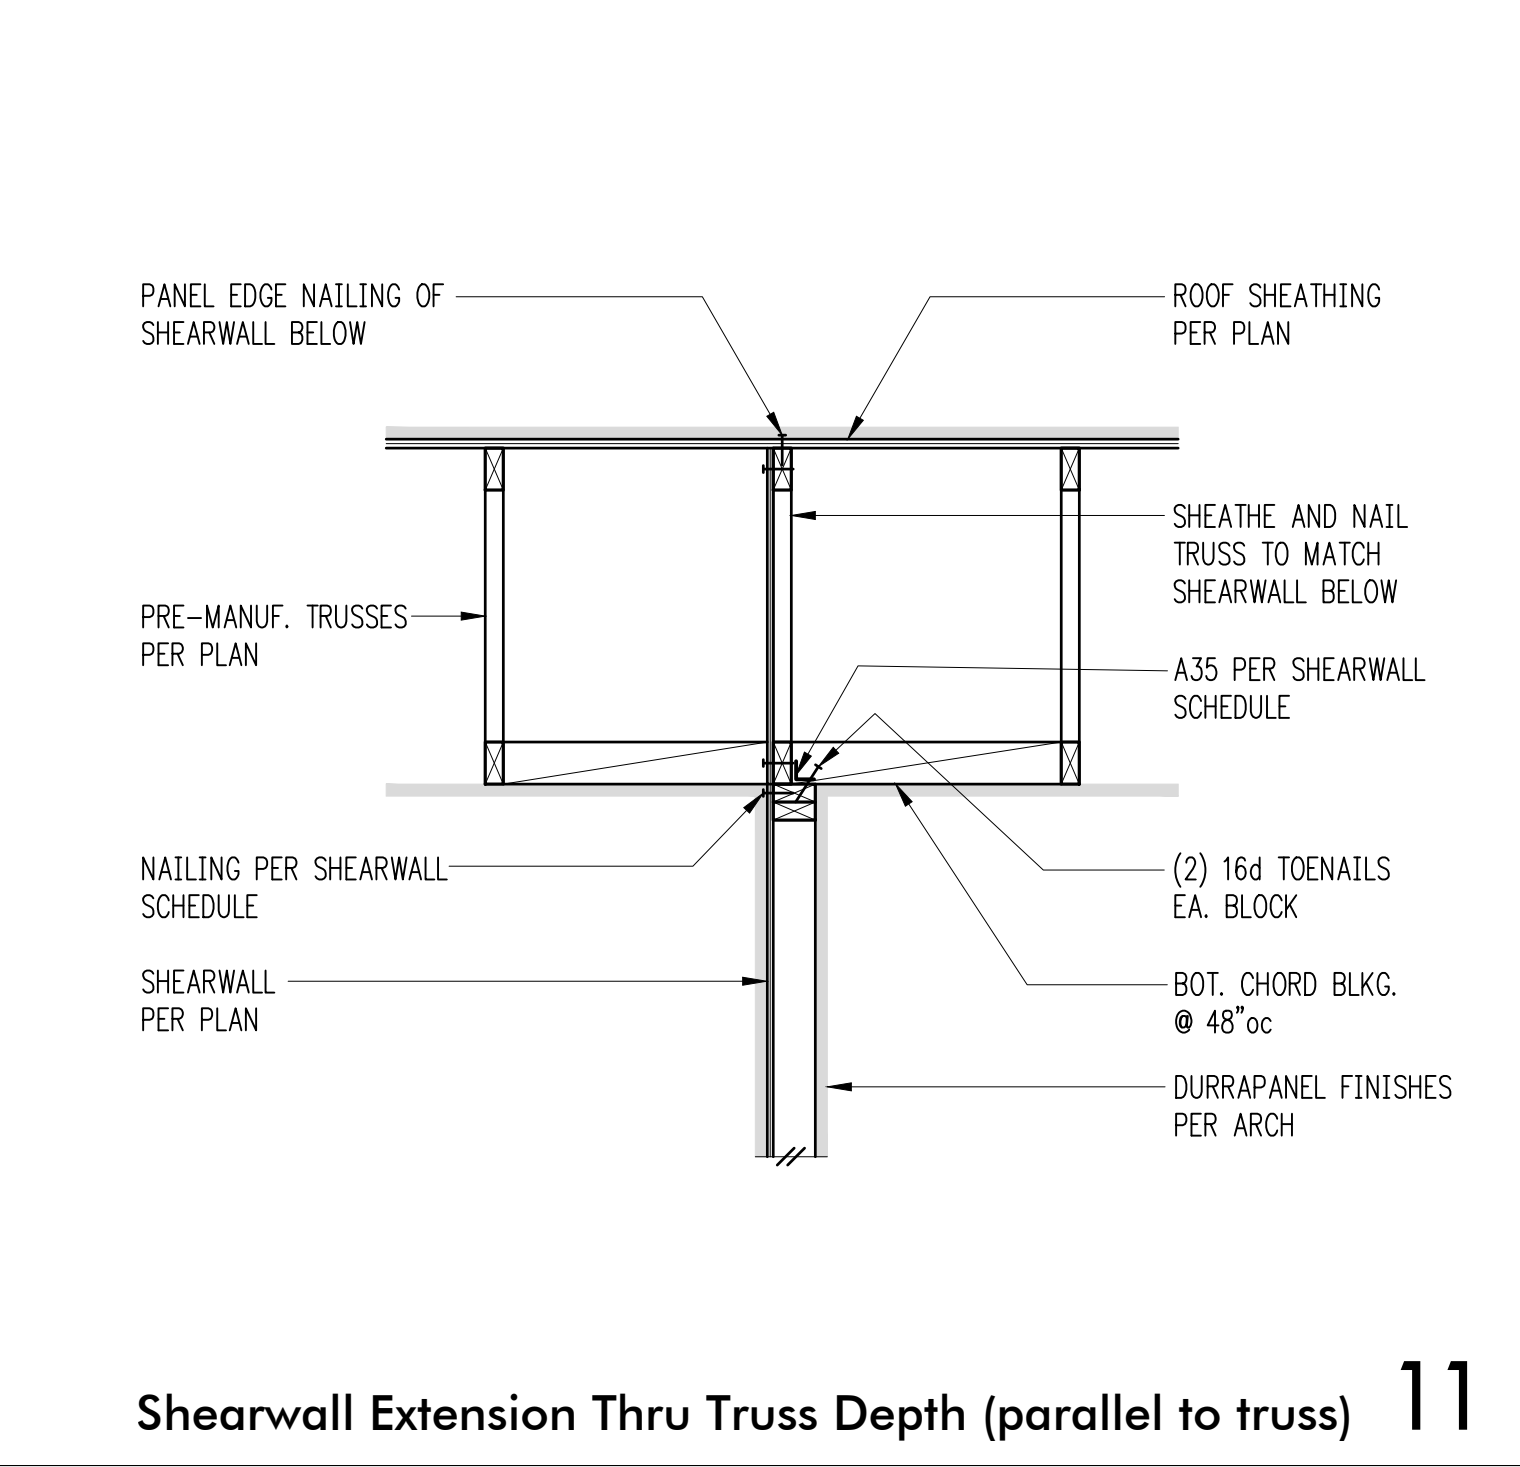

Shearwall Extension Thru Truss Depth (parallel to truss) 11

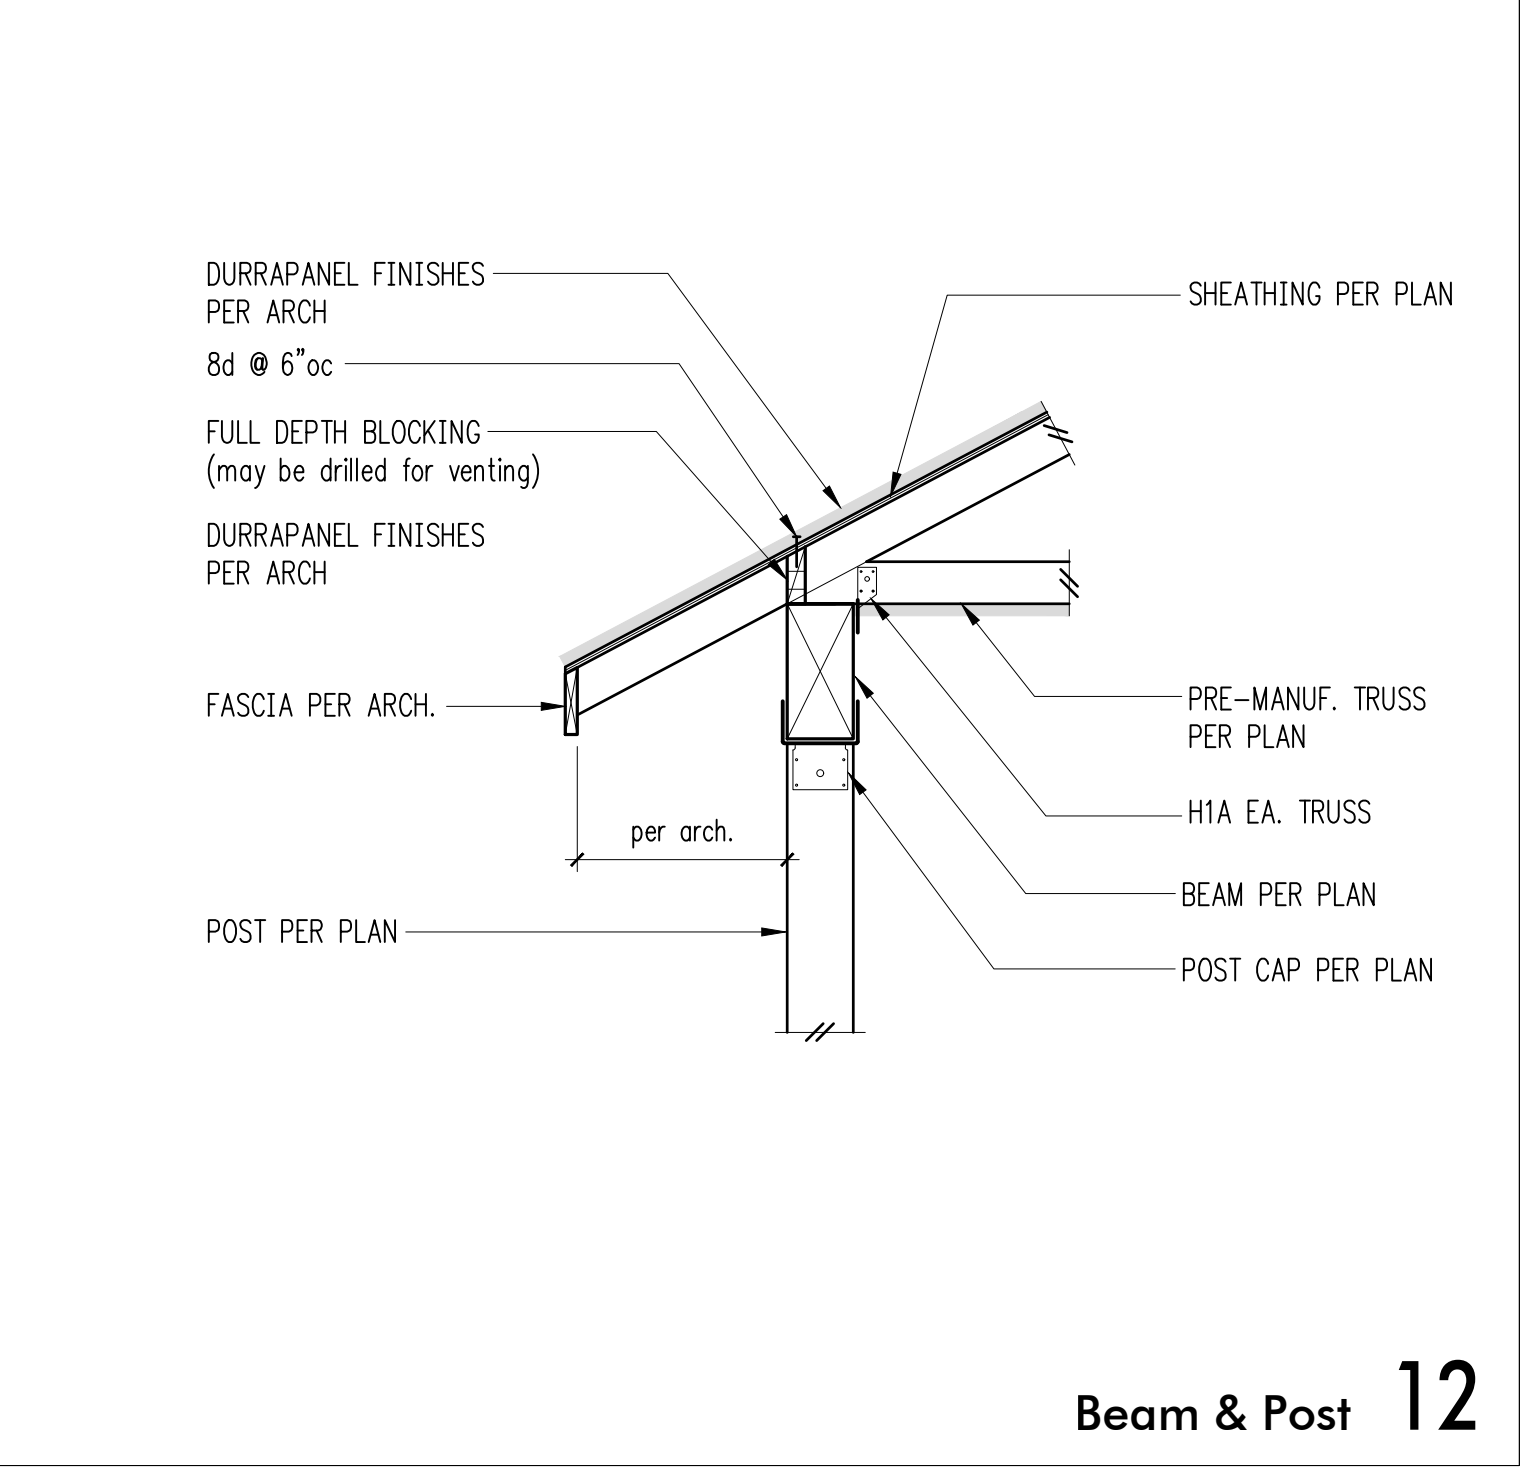

Beam & Post 12

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**PRELIMINARY**  
**NOT FOR**  
**CONSTRUCTION**

DRAWN: RJ

DESIGN: AGL

CHECKED: AGL

APPROVED: -

REVISIONS:


JURISDICTIONAL APPROVAL STAMP:

PROJECT TITLE:

**Ojai Permanent Supportive Housing**  
611 S Montgomery St  
Ojai, CA

ARCHITECT:

**DJA Architects**

ISSUE:

**Design Development**

SHEET TITLE:

**Wood Framing Details**

SCALE:

**3/4" = 1'-0" U.N.O.**

DATE:

**25 July, 2025**

PROJECT NO:

**02061-2025-01**

SHEET NO:

**S4.2**



GENERAL NOTES		SYMBOLS	ABBREVIATIONS	
<p><u>GENERAL NOTES:</u></p> <ol style="list-style-type: none"><li>ALL WORK SHALL COMPLY WITH APPLICABLE CODES, LOCAL ORDINANCES, &amp; LOCAL REQUIREMENTS, AS A MINIMUM. ADDITIONAL, MORE STRINGENT REQUIREMENTS SHALL GOVERN.</li><li>CONTRACT DOCUMENTS ARE SCHEMATICS, NOT SHOP DRAWINGS. SHOP DRAWINGS SHALL BE PROVIDED BY THE CONTRACTOR AS REQUIRED TO CLARIFY DETAILS OF INSTALLATION.</li><li>ALL SUBSTITUTIONS SHALL BE PRE-APPROVED.</li><li>PAY FOR ALL PERMITS &amp; FEES RELATED TO THE EXECUTION OF THIS WORK.</li><li>INSPECT &amp; REPORT ON DEFECTIVE EXISTING CONDITIONS PRIOR TO BID OR START OF WORK.</li><li>DO NOT CUT OR MODIFY STRUCTURAL MEMBERS WITHOUT PRIOR WRITTEN APPROVAL BY ARCHITECT.</li><li>COORDINATE WITH OTHER TRADES &amp; ARCHITECT FOR THE PROPER &amp; COMPLETE INSTALLATION OF THE WORK.</li><li>MAKE ALL NECESSARY PROVISIONS TO CREATE A SAFE WORK ENVIRONMENT.</li><li>PROVIDE SUBMITTALS FOR ALL WORK.</li><li>IDENTIFY ALL MECHANICAL EQUIPMENT WITH PLASTIC ENGRAVED TAGS.</li><li>ISOLATE MOTORIZED OR MOVING EQUIPMENT FROM STRUCTURE WITH APPROVED METHODS.</li><li>INSULATE INDIRECT WASTE PIPING TO PREVENT CONDENSATION.</li><li>COORDINATE AIR TERMINALS WITH ARCHITECTURAL CEILING TYPES AND SURFACE FINISHES, AS APPROPRIATE. PROVIDE COLOR SAMPLES TO ARCHITECT.</li><li>PROVIDE A 1 YEAR WARRANTY FOR ALL WORK.</li><li>PRODUCT INSTALLATION METHODS SHALL BE IN STRICT ACCORDANCE WITH MANUFACTURER'S DETAILED INSTRUCTIONS.</li><li>DUCT SIZES ARE INSIDE CLEAR DIMENSIONS. FOR LINED DUCTS, MAINTAIN SIZES INSIDE LINING.</li><li>ALL CONTROL WIRING INSIDE MECHANICAL ROOMS AND CONCEALED IN WALLS SHALL BE IN CONDUIT, INSTALLED BY MECHANICAL. ALL HVAC COMMUNICATIONS WIRING WITHIN 3 FEET OF ELECTRICAL PANELS OR OTHER DEVICES SHALL BE SHIELDED TO PREVENT SIGNAL DISRUPTION. REMAINING WIRING SHALL BE PLENUM RATED.</li></ol> <p><u>ELECTRICAL COORDINATION:</u></p> <ol style="list-style-type: none"><li>MOTOR STARTERS, LINE VOLTAGE WIRING &amp; ALL CONDUIT IS THE RESPONSIBILITY OF THE ELECTRICAL CONTRACTOR. LOW VOLTAGE WIRING &amp; LOW VOLTAGE CONTROL DEVICES SHALL BE THE RESPONSIBILITY OF THE MECHANICAL CONTRACTOR.</li><li>ALL PRODUCTS REQUIRING ELECTRICAL CONNECTION SHALL BE LISTED &amp; CLASSIFIED BY UL OR APPROVED TESTING FIRM.</li></ol> <p><u>DUCT SMOKE DETECTORS:</u></p> <ol style="list-style-type: none"><li>WHERE A FIRE ALARM SYSTEM IS REQUIRED OR PROVIDED, THE FIRE ALARM CONTRACTOR SHALL PROVIDE &amp; INSTALL THE DUCT DETECTOR &amp; MAKE ALL NECESSARY CONNECTIONS TO THE FIRE ALARM SYSTEM. MECHANICAL CONTRACTOR SHALL PREPARE DUCTWORK, INCLUDING ANY REQUIRED ACCESS FOR INSTALLATION OF DETECTORS BY THE FIRE ALARM CONTRACTOR. MECHANICAL CONTRACTOR SHALL INSTALL THE WIRING &amp; CONTROLS FOR THE FAN SHUTDOWN.</li><li>WHERE A FIRE ALARM SYSTEM IS NOT REQUIRED OR PROVIDED, THE MECHANICAL CONTRACTOR SHALL PROVIDE &amp; INSTALL THE DUCT SMOKE DETECTOR &amp; ALL ASSOCIATED CONTROLS &amp; DEVICES FOR ITS PROPER OPERATION. MECHANICAL CONTRACTOR SHALL COORDINATE HIS WORK WITH THE ELECTRICAL CONTRACTOR FOR CONDUIT, WIRING, &amp; POWER REQUIREMENTS.</li></ol> <p><u>TITLE 24 REQUIREMENTS:</u></p> <ol style="list-style-type: none"><li>PROVIDE ACCEPTANCE TESTING AND CERTIFICATES FOR ALL APPLICABLE SYSTEMS PER REQUIREMENTS OF 2022 TITLE 24 NON-RESIDENTIAL ENERGY STANDARDS.</li><li>WHERE APPLICABLE, PROVIDE DUCT LEAKAGE TESTING BY A CERTIFIED HERS RATER PER 2022 TITLE 24 REQUIREMENTS, SECTION 120.4(g). THIS SHALL BE PART OF THE BASE CONTRACT WORK.</li><li>PER SECTION 110.1: ANY APPLIANCE REGULATED BY THE APPLIANCE EFFICIENCY REGULATIONS, TITLE 20 CALIFORNIA CODE OF REGULATIONS, SECTION 1601 ET SEQ., MAY BE INSTALLED ONLY IF THE APPLIANCE FULLY COMPLIES WITH SECTION 1608(a) OF THOSE REGULATIONS.</li><li>ANY SPACE-CONDITIONING EQUIPMENT MAY BE INSTALLED ONLY IF THE MANUFACTURER HAS CERTIFIED TO THE CA ENERGY COMMISSION THAT THE EQUIPMENT COMPLIES WITH THE APPLICABLE REQUIREMENTS OF TITLE 24, SECTION 110.2.</li><li>ANY SERVICE WATER HEATING SYSTEM OR EQUIPMENT MAY BE INSTALLED ONLY IF THE MANUFACTURER HAS CERTIFIED THAT THE SYSTEM OR EQUIPMENT COMPLIES WITH ALL OF THE REQUIREMENTS OF TITLE 24, SECTION 110.3 FOR THAT SYSTEM OR EQUIPMENT.</li><li>INSTALLING CONTRACTOR SHALL PROVIDE APPLICABLE CERTIFICATES OF INSTALLATION (NRCI) AND ACCEPTANCE (NRCA) AT TIME OF INSPECTION PER 2022 TITLE 24 REQUIREMENTS.</li></ol> <p><u>CA GREEN BUILDING CODE (CGBC):</u></p> <ol style="list-style-type: none"><li>COMPLY WITH ALL MANDATORY REQUIREMENTS OF CHAPTER 5 OF THE 2022 CGBC.</li><li>COMPLY WITH ALL ENVIRONMENTAL QUALITY REQUIREMENTS OF CHAPTER 5 OF THE 2022 CGBC INCLUDING PRE- AND POST-OCCUPANCY FILTERS AND VOC LIMITS. PROVIDE DOCUMENTATION OF COMPLIANCE AS REQUIRED.</li></ol> <p><u>TEST AND BALANCE:</u></p> <ol style="list-style-type: none"><li>ALL SYSTEMS SHALL BE TESTED BY A CERTIFIED INDEPENDENT AGENCY, TO NEBB OR AABC STANDARDS. PROVIDE CERTIFIED AIR BALANCE REPORT FOR REVIEW PRIOR TO FINAL INSPECTION.</li><li>BALANCE SYSTEM IN AT LEAST TWO PHASES: 2.1. PRELIMINARY/ROUGH 2.2. FINAL FOR REVIEW BY ARCHITECT. AN ADDITIONAL REBALANCE MAY BE REQUIRED FOR FINAL APPROVAL.</li></ol>		<p><u>PRODUCTS:</u></p> <ol style="list-style-type: none"><li>ALL PRODUCTS SHALL BE NEW, IN PERFECT CONDITION, &amp; SHALL BEAR THE MANUFACTURER'S LABEL.</li><li>DUCTWORK SHALL CONFORM TO THE CMC &amp; TO SMACNA STANDARDS FOR GAGES &amp; INSTALLATION, UNLESS OTHERWISE NOTED TO BE MORE STRINGENT. INSULATE ALL HEATING, COOLING &amp; RETURN DUCTS PER TITLE 24 REQUIREMENTS. DUCT LINER SHALL BE FIBER-FREE ARMAFLEX FS SA. DUCT LINER SHALL BE ALLOWED ONLY WHERE PERMITTED BY THE CMC AND LOCAL JURISDICTIONS. DUCTWRAP SHALL BE JM "MICROLITE" XG.</li><li>CMC COMPLIANCE: ALL AIR DISTRIBUTION SYSTEM DUCTS AND PLENUMS, INCLUDING, BUT NOT LIMITED TO, BUILDING CAVITIES, MECHANICAL CLOSETS, AIR-HANDLER BOXES AND SUPPORT PLATFORMS USED AS DUCTS OR PLENUMS, SHALL MEET THE REQUIREMENTS OF THE CMC SECTIONS 601.0, 602.0, 603.0, 604.0, 605.0, AND ANSI/SMACNA-006-2006 HVAC DUCT CONSTRUCTION STANDARDS METAL AND FLEXIBLE 3RD EDITION. CONNECTIONS OF METAL DUCTS AND THE INNER CORE OF FLEXIBLE DUCTS SHALL BE MECHANICALLY FASTENED. OPENINGS SHALL BE SEALED WITH MASTIC, TAPE, AEROSOL SEALANT, OR OTHER DUCT-CLOSURE SYSTEM THAT MEETS THE APPLICABLE REQUIREMENTS OF UL 181, UL 181A, OR UL 181B. IF MASTIC OR TAPE IS USED TO SEAL OPENINGS GREATER THAN 1/4 INCH, THE COMBINATION OF MASTIC AND EITHER MESH OR TAPE SHALL BE USED. PORTIONS OF SUPPLY-AIR AND RETURN-AIR DUCTS CONVEYING HEATED OR COOLED AIR LOCATED IN ONE OR MORE OF THE FOLLOWING SPACES SHALL BE INSULATED TO A MINIMUM INSTALLED LEVEL OF R-8: OUTDOORS; OR IN A SPACE BETWEEN THE ROOF AND AN INSULATED CEILING; OR IN A SPACE DIRECTLY UNDER A ROOF WITH FIXED VENTS OR OPENINGS TO THE OUTSIDE OR UNCONDITIONED SPACES; OR IN AN UNCONDITIONED CRAWLSPACE; OR IN OTHER UNCONDITIONED SPACES. PORTIONS OF SUPPLY-AIR DUCTS THAT ARE NOT IN ONE OF THESE SPACES, INCLUDING DUCTS BURIED IN CONCRETE SLAB, SHALL BE INSULATED TO A MINIMUM INSTALLED LEVEL OF R-4.2 OR BE ENCLOSED IN DIRECTLY CONDITIONED SPACE.</li><li>DUCTS EXPOSED TO WEATHER TRANSPORTING CONDITIONED AIR: 2" RIGID DUCTLINER, OR 2" RIGID DUCTBOARD ON OUTSIDE OF DUCTWORK WITH ALUMINUM CLADDING. EXTERNAL DUCTBOARD AND CLADDING ARE REQUIRED FOR ALL EXPOSED DUCTS DOWNSTREAM OF HIGH EFFICIENCY FILTERS (80% OR GREATER). DUCTWORK SEALANT: NON-HARDENING, WATER/FIRE RESISTIVE. HYDRO-STOP INC. "PREMIUMCOAT" SYSTEM ON ALL JOINTS AND ALL SURFACES OF DUCTWORK.</li><li>ALL REFRIGERANT PIPING, AND OTHER PIPING CONVEYING FLUIDS ABOVE AND/OR BELOW AMBIENT TEMPERATURE, THAT IS EXPOSED TO WEATHER SHALL BE INSULATED PER CURRENT TITLE 24 REQUIREMENTS AND SHALL BE INSTALLED WITH ALUMINUM JACKETING.</li><li>DUCTWORK SHALL BE ASTM RATED, GALVANIZED WITH G90 ZINC COATING. SEALANT: NON-HARDENING, WATER/FIRE RESISTIVE. FLEXIBLE DUCT ALLOWED LAST 5 FEET OF BRANCH UNO. PROVIDE MVD AT EACH BRANCH.</li><li>FLEXIBLE DUCT LENGTH LIMITATION: FACTORY-MADE FLEXIBLE AIR DUCTS AND CONNECTORS SHALL NOT BE MORE THAN 5 FEET IN LENGTH, AND SHALL NOT BE USED IN LIEU OF RIGID ELBOWS OR FITTINGS. FLEXIBLE AIR DUCTS SHALL BE PERMITTED TO BE USED AS AN ELBOW AT A TERMINAL DEVICE (CMC 603.4.1). EXCEPTION: RESIDENTIAL OCCUPANCIES.</li><li>ALL FLEXIBLE DUCTWORK SHALL HAVE NON-POROUS INNER CORES AND SHALL BE UL 181 LISTED. R-VALUES FOR DUCT INSULATION SHALL BE PER THE CURRENT CA TITLE 24 REQUIREMENTS.</li><li>FLEXIBLE DUCTWORK SHALL BE THERMAFLEX MKC, FLEXMASTER 3B, OR EQUAL.</li><li>ACOUSTICAL FLEX DUCT SHALL BE CASCO SILENT FLEX II OR EQUAL, EXCEPT WHERE PROHIBITED BY TITLE 24 REQUIREMENTS FOR NON-POROUS INNER CORES.</li><li>ALL FACTORY &amp; FIELD FABRICATED DUCT SYSTEMS &amp; PRESSURE SENSITIVE TAPES, MASTICS OR OTHER CLOSURE SYSTEMS SHALL COMPLY WITH UL 181.</li><li>JOINTS &amp; SEAMS OF CONCEALED DUCT SYSTEMS &amp; THEIR COMPONENTS SHALL BE SEALED WITH NON-HARDENING, WATER RESISTANT, FIRE RESISTIVE SEALANT, COMPATIBLE WITH MATING MATERIALS; DUCT TAPE SHALL NOT BE ALLOWED AS DUCT SEALER. EXPOSED DUCTWORK SHALL BE NEATLY JOINED AND FASTENED WITH SHEET METAL SCREWS.</li><li>DUCT SYSTEMS USED WITH BLOWER TYPE EQUIPMENT WHICH ARE PORTIONS OF A HEATING, COOLING, ABSORPTION, EVAPORATIVE COOLING OR OUTDOOR AIR VENTILATION SYSTEM SHALL BE SIZED IN ACCORDANCE WITH CHAPTER 17 OF THE CALIFORNIA MECHANICAL CODE.</li><li>DUCT LEAKAGE TESTS (CMC SECTION 603.9.2): DUCTWORK SHALL BE LEAK-TESTED IN ACCORDANCE WITH THE SMACNA HVAC AIR DUCT LEAKAGE TEST MANUAL. REPRESENTATIVE SECTIONS TOTALING NOT LESS THAN 10 PERCENT OF THE TOTAL INSTALLED DUCT AREA SHALL BE TESTED. WHERE THE TESTED 10 PERCENT FAIL TO COMPLY WITH THE REQUIREMENTS OF THIS SECTION, THEN 40 PERCENT OF THE TOTAL INSTALLED DUCT AREA SHALL BE TESTED. WHERE THE TESTED 40 PERCENT FAIL TO COMPLY WITH THE REQUIREMENTS OF THIS SECTION, THEN 100 PERCENT OF THE TOTAL INSTALLED DUCT AREA SHALL BE TESTED. SECTIONS SHALL BE SELECTED BY THE BUILDING OWNER OR DESIGNATED REPRESENTATIVE OF THE BUILDING OWNER. POSITIVE PRESSURE LEAKAGE TESTING SHALL BE PERMITTED FOR NEGATIVE PRESSURE DUCTWORK.</li><li>PROTECT ALL EQUIPMENT AND DUCT OPENINGS DURING CONSTRUCTION. AT THE TIME OF ROUGH INSTALLATION AND DURING STORAGE ON THE CONSTRUCTION SITE UNTIL FINAL STARTUP OF THE HEATING, COOLING AND VENTILATING EQUIPMENT, ALL DUCT AND OTHER RELATED AIR DISTRIBUTION COMPONENT OPENINGS SHALL BE COVERED WITH TAPE, PLASTIC, SHEET METAL OR OTHER METHODS ACCEPTABLE TO THE ENFORCING AGENCY TO REDUCE THE AMOUNT OF DUST, WATER AND DEBRIS WHICH MAY ENTER THE SYSTEM.</li><li>ENVIRONMENTAL AIR DUCT EXHAUST SHALL TERMINATE NOT LESS THAN 3 FEET FROM A PROPERTY LINE, 10 FEET FROM A FORCED AIR INLET, 3 FEET FROM OPENINGS INTO THE BUILDING, AND SHALL NOT DISCHARGE ONTO A PUBLIC WALKWAY (CMC 502.1). SEE CMC 502.2.2 FOR DISCHARGE REQUIREMENTS FOR PRODUCT CONVEYING DUCTS. PROVIDE BACK-DRAFT DAMPERS ON EXHAUST SYSTEMS PER CMC 504.1.1.</li><li>PROVIDE MINIMUM 26 GAGE SHEET METAL AND UL LISTED PENETRATION FIRE STOPPING FOR ALL DUCTS PENETRATING RATED ASSEMBLIES. ALL VERTICAL AND HORIZONTAL PENETRATIONS OF RATED ASSEMBLIES SHALL COMPLY WITH CHAPTER 7 OF THE CBC, INCLUDING FIRE DAMPERS AND RATED SHAFT ENCLOSURES WHERE REQUIRED, COORDINATE WITH THE ARCHITECT AND GC PRIOR TO INSTALLATION.</li></ol>	<div><div><div><div><div><div></div><div></div><div></div><div></div><div></div><div></div><div></div><div></div><div></div><div></div><div></div><div></div><div></div><div></div><div></div><div></div><div></div><div></div><div></div><div></div><div></div><div></div><div></div><div></div><div></div><div></div><div></div><div></div><div></div><div></div><div></div><div></div><div></div><div></div><div></div><div></div><div></div><div></div><div></div><div></div><div></div><div></div><div></div><div></div><div></div><div></div><div></div><div></div><div></div><div></div><div></div><div></div><div></div><div></div><div></div><div></div><div></div><div></div><div></div><div></div><div></div><div></div><div></div><div></div><div></div><div></div><div></div><div></div><div></div><div></div><div></div><div></div><div></div><div></div><div></div><div></div><div></div><div></div><div></div><div></div><div></div><div></div><div></div><div></div><div></div><div></div><div></div><div></div><div></div><div></div><div></div><div></div><div></div><div></div><div></div><div></div><div></div><div></div><div></div><div></div><div></div><div></div><div></div><div></div><div></div><div></div><div></div><div></div><div></div><div></div><div></div><div></div><div></div><div></div><div></div><div></div><div></div><div></div><div></div><div></div><div></div><div></div><div></div><div></div><div></div><div></div><div></div><div></div><div></div><div></div><div></div><div></div><div></div><div></div><div></div><div></div><div></div><div></div><div></div><div></div><div></div><div></div><div></div><div></div><div></div><div></div><div></div><div></div><div></div><div></div><div></div><div></div><div></div><div></div><div></div><div></div><div></div><div></div><div></div><div></div><div></div><div></div><div></div><div></div><div></div><div></div><div></div><div></div><div></div><div></div><div></div><div></div><div></div><div></div><div></div><div></div><div></div><div></div><div></div><div></div><div></div><div></div><div></div><div></div><div></div><div></div><div></div><div></div><div></div><div></div><div></div><div></div><div></div><div></div><div></div><div></div><div></div><div></div><div></div><div></div><div></div><div></div><div></div><div></div><div></div><div></div><div></div><div></div><div></div><div></div><div></div><div></div><div></div><div></div><div></div><div></div><div></div><div></div><div></div><div></div><div></div><div></div><div></div><div></div><div></div><div></div><div></div><div></div><div></div><div></div><div></div><div></div><div></div><div></div><div></div><div></div><div></div><div></div><div></div><div></div><div></div><div></div><div></div><div></div><div></div><div></div><div></div><div></div><div></div><div></div><div></div><div></div><div></div><div></div><div></div><div></div><div></div><div></div><div></div><div></div><div></div><div></div><div></div><div></div><div></div><div></div><div></div><div></div><div></div><div></div><div></div><div></div><div></div><div></div><div></div><div></div><div></div><div></div><div></div><div></div><div></div><div></div><div></div><div></div><div></div><div></div><div></div><div></div><div></div><div></div><div></div><div></div><div></div><div></div><div></div><div></div><div></div><div></div><div></div><div></div><div></div><div></div><div></div><div></div><div></div><div></div><div></div><div></div><div></div><div></div><div></div><div></div><div></div><div></div><div></div><div></div><div></div><div></div><div></div><div></div><div></div><div></div><div></div><div></div><div></div><div></div><div></div><div></div><div></div><div></div><div></div><div></div><div></div><div></div><div></div><div></div><div></div><div></div><div></div><div></div><div></div><div></div><div></div><div></div><div></div><div></div><div></div><div></div><div></div><div></div><div></div><div></div><div></div><div></div><div></div><div></div><div></div><div></div><div></div><div></div><div></div><div></div><div></div><div></div><div></div><div></div><div></div><div></div><div></div><div></div><div></div><div></div><div></div><div></div><div></div><div></div><div></div><div></div><div></div><div></div><div></div><div></div><div></div><div></div><div></div><div></div><div></div><div></div><div></div><div></div><div></div><div></div><div></div><div></div><div></div><div></div><div></div><div></div><div></div><div></div><div></div><div></div><div></div><div></div><div></div><div></div><div></div><div></div><div></div><div></div><div></div><div></div><div></div><div></div><div></div><div></div><div></div><div></div><div></div><div></div><div></div><div></div><div></div><div></div><div></div><div></div><div></div><div></div><div></div><div></div><div></div><div></div><div></div><div></div><div></div><div></div><div></div><div></div><div></div><div></div><div></div><div></div><div></div><div></div><div></div><div></div><div></div><div></div><div></div><div></div><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MULTIZONE SPLIT SYSTEM HEAT PUMPS (RESIDENTIAL UNITS)														VRF SYSTEM INSULATION SPECIFICATION											
TAG	MANUFACTURER	MODEL (INDOOR UNIT)	CFM (LO-MED-HI)	ESP	AHRI COOLING (MBH)	AHRI HEATING (MBH)	ELECTRICAL		APPROX WEIGHT (LBS)	SERVES	NOTES	TAG	MANUFACTURER	MODEL (OUTDOOR UNIT)	AHRI COOLING (MBH)	AHRI HEATING (MBH)	SEER2/HSPF2	ELECTRICAL				APPROX WEIGHT (LBS)	NOTES		
<div>FC101</div>	SAMSUNG	AM012 FEVDCG	293-321-364	N/A	12	13.5	208/230-1-60		0.31	20.9	101 SINGLE	<div>123</div>	<div>HP1</div>	SAMSUNG	AM048 FCMDCG	48	54	21.3/10.5	208/230-1-60	24	30	1.2 (x2)	19.3	243.6	<div>INSULATION SPECIFICATION:</div> <div>MATERIAL: LOW-DENSITY EPDM CLOSED-CELL ELASTOMERIC FOAM, CFC AND HCFC GAS FREE WITH OVERLAP SEAL.</div> <div>THERMAL CONDUCTIVITY: 0.235 (BTU*in/hr*fi²*F) AT 75°F.</div> <div>WATER VAPOR PERMEABILITY: &lt;0.03 PERM (4.38 x 10¹¹ g/Po*s*m) PER ASTM E96.</div> <div>WATER ABSORPTION: &lt;0.2% BY VOLUME PER ASTM C 209.</div> <div>WORKING TEMPERATURE: -70°F TO 257°F (-57°C TO 125°C) CONTINUOUS PER ASTM C 411.</div> <div>SURFACE BURNING CHARACTERISTICS: MEETS 25/50 FLAME-SPREAD/ SMOKE-GENERATED PER UL723 AND ASTM E84. ADDITIONALLY MEETS UL-945 V-A, V-O AND IS SELF-EXTINGUISHING PER ASTM D 635.</div> <div>UV RESISTANT: EPDM PROVIDES UV RESISTANCE IN ACCORDANCE WITH ASTM G7/G90.</div> <div>OZONE RESISTANT: MEETS ASTM D 1171.</div> <div>TITLE 24 INSULATION WALL THICKNESS SPECIFICATION:</div> <div>HOT GAS PIPES: ABOVE 200°F (3-PIPE HEAT RECOVERY SYSTEM) USE 2½" WALL THICKNESS; BELOW 200°F (2-PIPE HEAT RECOVERY SYSTEMS) USE 1½" WALL THICKNESS; (HEAT PUMPS AND LINE SETS FOLLOW THE SAME ABOVE REQUIREMENTS BASED ON PIPE TEMPERATURES). NOTE: 2½" THICKNESS REQUIRES DOUBLE LAYERS TO MEET 25/50 FIRE/SMOKE CODES.</div> <div>LIQUID PIPES: 1" WALL THICKNESS</div> <div>SUCTION GAS PIPES: 1" WALL THICKNESS FOR LESS THAN 1" PIPE; 1½" WALL THICKNESS FOR GREATER THAN 1" PIPE</div>
<div>FC102</div>	SAMSUNG										102 SINGLE	<div>123</div>													
<div>FC103</div>	SAMSUNG										103 SINGLE	<div>123</div>													
<div>FC104</div>	SAMSUNG										104 SINGLE	<div>123</div>													
<div>FC105</div>	SAMSUNG										105 SINGLE	<div>123</div>	<div>HP2</div>	SAMSUNG	AM048 FCMDCG	48	54	21.3/10.5	208/230-1-60	24	30	1.2 (x2)	19.3	243.6	<div>INSULATION SPECIFICATION:</div> <div>MATERIAL: LOW-DENSITY EPDM CLOSED-CELL ELASTOMERIC FOAM, CFC AND HCFC GAS FREE WITH OVERLAP SEAL.</div> <div>THERMAL CONDUCTIVITY: 0.235 (BTU*in/hr*fi²*F) AT 75°F.</div> <div>WATER VAPOR PERMEABILITY: &lt;0.03 PERM (4.38 x 10¹¹ g/Po*s*m) PER ASTM E96.</div> <div>WATER ABSORPTION: &lt;0.2% BY VOLUME PER ASTM C 209.</div> <div>WORKING TEMPERATURE: -70°F TO 257°F (-57°C TO 125°C) CONTINUOUS PER ASTM C 411.</div> <div>SURFACE BURNING CHARACTERISTICS: MEETS 25/50 FLAME-SPREAD/ SMOKE-GENERATED PER UL723 AND ASTM E84. ADDITIONALLY MEETS UL-945 V-A, V-O AND IS SELF-EXTINGUISHING PER ASTM D 635.</div> <div>UV RESISTANT: EPDM PROVIDES UV RESISTANCE IN ACCORDANCE WITH ASTM G7/G90.</div> <div>OZONE RESISTANT: MEETS ASTM D 1171.</div> <div>TITLE 24 INSULATION WALL THICKNESS SPECIFICATION:</div> <div>HOT GAS PIPES: ABOVE 200°F (3-PIPE HEAT RECOVERY SYSTEM) USE 2½" WALL THICKNESS; BELOW 200°F (2-PIPE HEAT RECOVERY SYSTEMS) USE 1½" WALL THICKNESS; (HEAT PUMPS AND LINE SETS FOLLOW THE SAME ABOVE REQUIREMENTS BASED ON PIPE TEMPERATURES). NOTE: 2½" THICKNESS REQUIRES DOUBLE LAYERS TO MEET 25/50 FIRE/SMOKE CODES.</div> <div>LIQUID PIPES: 1" WALL THICKNESS</div> <div>SUCTION GAS PIPES: 1" WALL THICKNESS FOR LESS THAN 1" PIPE; 1½" WALL THICKNESS FOR GREATER THAN 1" PIPE</div>
<div>FC106</div>	SAMSUNG										106 SINGLE	<div>123</div>													
<div>FC107</div>	SAMSUNG										107 SINGLE	<div>123</div>													
<div>FC108</div>	SAMSUNG										108 SINGLE	<div>123</div>													
<div>FC109</div>	SAMSUNG										109 SINGLE	<div>123</div>	<div>HP3</div>	SAMSUNG	AM036 FCMDCG	38	42	22.0/11.0	208/230-1-60	22	30	1.2 (x2)	19.3	243.6	<div>INSULATION SPECIFICATION:</div> <div>MATERIAL: LOW-DENSITY EPDM CLOSED-CELL ELASTOMERIC FOAM, CFC AND HCFC GAS FREE WITH OVERLAP SEAL.</div> <div>THERMAL CONDUCTIVITY: 0.235 (BTU*in/hr*fi²*F) AT 75°F.</div> <div>WATER VAPOR PERMEABILITY: &lt;0.03 PERM (4.38 x 10¹¹ g/Po*s*m) PER ASTM E96.</div> <div>WATER ABSORPTION: &lt;0.2% BY VOLUME PER ASTM C 209.</div> <div>WORKING TEMPERATURE: -70°F TO 257°F (-57°C TO 125°C) CONTINUOUS PER ASTM C 411.</div> <div>SURFACE BURNING CHARACTERISTICS: MEETS 25/50 FLAME-SPREAD/ SMOKE-GENERATED PER UL723 AND ASTM E84. ADDITIONALLY MEETS UL-945 V-A, V-O AND IS SELF-EXTINGUISHING PER ASTM D 635.</div> <div>UV RESISTANT: EPDM PROVIDES UV RESISTANCE IN ACCORDANCE WITH ASTM G7/G90.</div> <div>OZONE RESISTANT: MEETS ASTM D 1171.</div> <div>TITLE 24 INSULATION WALL THICKNESS SPECIFICATION:</div> <div>HOT GAS PIPES: ABOVE 200°F (3-PIPE HEAT RECOVERY SYSTEM) USE 2½" WALL THICKNESS; BELOW 200°F (2-PIPE HEAT RECOVERY SYSTEMS) USE 1½" WALL THICKNESS; (HEAT PUMPS AND LINE SETS FOLLOW THE SAME ABOVE REQUIREMENTS BASED ON PIPE TEMPERATURES). NOTE: 2½" THICKNESS REQUIRES DOUBLE LAYERS TO MEET 25/50 FIRE/SMOKE CODES.</div> <div>LIQUID PIPES: 1" WALL THICKNESS</div> <div>SUCTION GAS PIPES: 1" WALL THICKNESS FOR LESS THAN 1" PIPE; 1½" WALL THICKNESS FOR GREATER THAN 1" PIPE</div>
<div>FC110</div>	SAMSUNG										110 SINGLE	<div>123</div>													
<div>FC111</div>	SAMSUNG										111 SINGLE	<div>123</div>													
<div>FC112</div>	SAMSUNG	AM018 FEVDCG	424-487-555	N/A	18	20	208/230-1-60		0.44	26.5	112 DOUBLE	<div>123</div>													
<div>FC113</div>	SAMSUNG										113 SINGLE	<div>123</div>	<div>HP4</div>	SAMSUNG	AM060 FCMDCG	60	66	20.0/10.2	208/230-1-60	32	40	1.2 (x2)	19.3	243.6	<div>INSULATION SPECIFICATION:</div> <div>MATERIAL: LOW-DENSITY EPDM CLOSED-CELL ELASTOMERIC FOAM, CFC AND HCFC GAS FREE WITH OVERLAP SEAL.</div> <div>THERMAL CONDUCTIVITY: 0.235 (BTU*in/hr*fi²*F) AT 75°F.</div> <div>WATER VAPOR PERMEABILITY: &lt;0.03 PERM (4.38 x 10¹¹ g/Po*s*m) PER ASTM E96.</div> <div>WATER ABSORPTION: &lt;0.2% BY VOLUME PER ASTM C 209.</div> <div>WORKING TEMPERATURE: -70°F TO 257°F (-57°C TO 125°C) CONTINUOUS PER ASTM C 411.</div> <div>SURFACE BURNING CHARACTERISTICS: MEETS 25/50 FLAME-SPREAD/ SMOKE-GENERATED PER UL723 AND ASTM E84. ADDITIONALLY MEETS UL-945 V-A, V-O AND IS SELF-EXTINGUISHING PER ASTM D 635.</div> <div>UV RESISTANT: EPDM PROVIDES UV RESISTANCE IN ACCORDANCE WITH ASTM G7/G90.</div> <div>OZONE RESISTANT: MEETS ASTM D 1171.</div> <div>TITLE 24 INSULATION WALL THICKNESS SPECIFICATION:</div> <div>HOT GAS PIPES: ABOVE 200°F (3-PIPE HEAT RECOVERY SYSTEM) USE 2½" WALL THICKNESS; BELOW 200°F (2-PIPE HEAT RECOVERY SYSTEMS) USE 1½" WALL THICKNESS; (HEAT PUMPS AND LINE SETS FOLLOW THE SAME ABOVE REQUIREMENTS BASED ON PIPE TEMPERATURES). NOTE: 2½" THICKNESS REQUIRES DOUBLE LAYERS TO MEET 25/50 FIRE/SMOKE CODES.</div> <div>LIQUID PIPES: 1" WALL THICKNESS</div> <div>SUCTION GAS PIPES: 1" WALL THICKNESS FOR LESS THAN 1" PIPE; 1½" WALL THICKNESS FOR GREATER THAN 1" PIPE</div>
<div>FC114</div>	SAMSUNG										114 SINGLE	<div>123</div>													
<div>FC115</div>	SAMSUNG										115 SINGLE	<div>123</div>													
<div>FC116</div>	SAMSUNG										116 SINGLE	<div>123</div>													
<div>FC117</div>	SAMSUNG										117 SINGLE	<div>123</div>	<div>HP5</div>	SAMSUNG	AM060 FCMDCG	60	66	20.0/10.2	208/230-1-60	32	40	1.2 (x2)	19.3	243.6	<div>INSULATION SPECIFICATION:</div> <div>MATERIAL: LOW-DENSITY EPDM CLOSED-CELL ELASTOMERIC FOAM, CFC AND HCFC GAS FREE WITH OVERLAP SEAL.</div> <div>THERMAL CONDUCTIVITY: 0.235 (BTU*in/hr*fi²*F) AT 75°F.</div> <div>WATER VAPOR PERMEABILITY: &lt;0.03 PERM (4.38 x 10¹¹ g/Po*s*m) PER ASTM E96.</div> <div>WATER ABSORPTION: &lt;0.2% BY VOLUME PER ASTM C 209.</div> <div>WORKING TEMPERATURE: -70°F TO 257°F (-57°C TO 125°C) CONTINUOUS PER ASTM C 411.</div> <div>SURFACE BURNING CHARACTERISTICS: MEETS 25/50 FLAME-SPREAD/ SMOKE-GENERATED PER UL723 AND ASTM E84. ADDITIONALLY MEETS UL-945 V-A, V-O AND IS SELF-EXTINGUISHING PER ASTM D 635.</div> <div>UV RESISTANT: EPDM PROVIDES UV RESISTANCE IN ACCORDANCE WITH ASTM G7/G90.</div> <div>OZONE RESISTANT: MEETS ASTM D 1171.</div> <div>TITLE 24 INSULATION WALL THICKNESS SPECIFICATION:</div> <div>HOT GAS PIPES: ABOVE 200°F (3-PIPE HEAT RECOVERY SYSTEM) USE 2½" WALL THICKNESS; BELOW 200°F (2-PIPE HEAT RECOVERY SYSTEMS) USE 1½" WALL THICKNESS; (HEAT PUMPS AND LINE SETS FOLLOW THE SAME ABOVE REQUIREMENTS BASED ON PIPE TEMPERATURES). NOTE: 2½" THICKNESS REQUIRES DOUBLE LAYERS TO MEET 25/50 FIRE/SMOKE CODES.</div> <div>LIQUID PIPES: 1" WALL THICKNESS</div> <div>SUCTION GAS PIPES: 1" WALL THICKNESS FOR LESS THAN 1" PIPE; 1½" WALL THICKNESS FOR GREATER THAN 1" PIPE</div>
<div>FC118</div>	SAMSUNG										118 SINGLE	<div>123</div>													
<div>FC119</div>	SAMSUNG	AM018 FEVDCG	424-487-555	N/A	18	20	208/230-1-60		0.44	26.5	119 DOUBLE	<div>123</div>													
<div>FC120</div>	SAMSUNG										120 SINGLE	<div>123</div>													
<div>FC121</div>	SAMSUNG										121 SINGLE	<div>123</div>	<div>HP6</div>	SAMSUNG	AM036 FCMDCG	38	42	22.0/11.0	208/230-1-60	22	30	1.2 (x2)	19.3	243.6	<div>INSULATION SPECIFICATION:</div> <div>MATERIAL: LOW-DENSITY EPDM CLOSED-CELL ELASTOMERIC FOAM, CFC AND HCFC GAS FREE WITH OVERLAP SEAL.</div> <div>THERMAL CONDUCTIVITY: 0.235 (BTU*in/hr*fi²*F) AT 75°F.</div> <div>WATER VAPOR PERMEABILITY: &lt;0.03 PERM (4.38 x 10¹¹ g/Po*s*m) PER ASTM E96.</div> <div>WATER ABSORPTION: &lt;0.2% BY VOLUME PER ASTM C 209.</div> <div>WORKING TEMPERATURE: -70°F TO 257°F (-57°C TO 125°C) CONTINUOUS PER ASTM C 411.</div> <div>SURFACE BURNING CHARACTERISTICS: MEETS 25/50 FLAME-SPREAD/ SMOKE-GENERATED PER UL723 AND ASTM E84. ADDITIONALLY MEETS UL-945 V-A, V-O AND IS SELF-EXTINGUISHING PER ASTM D 635.</div> <div>UV RESISTANT: EPDM PROVIDES UV RESISTANCE IN ACCORDANCE WITH ASTM G7/G90.</div> <div>OZONE RESISTANT: MEETS ASTM D 1171.</div> <div>TITLE 24 INSULATION WALL THICKNESS SPECIFICATION:</div> <div>HOT GAS PIPES: ABOVE 200°F (3-PIPE HEAT RECOVERY SYSTEM) USE 2½" WALL THICKNESS; BELOW 200°F (2-PIPE HEAT RECOVERY SYSTEMS) USE 1½" WALL THICKNESS; (HEAT PUMPS AND LINE SETS FOLLOW THE SAME ABOVE REQUIREMENTS BASED ON PIPE TEMPERATURES). NOTE: 2½" THICKNESS REQUIRES DOUBLE LAYERS TO MEET 25/50 FIRE/SMOKE CODES.</div> <div>LIQUID PIPES: 1" WALL THICKNESS</div> <div>SUCTION GAS PIPES: 1" WALL THICKNESS FOR LESS THAN 1" PIPE; 1½" WALL THICKNESS FOR GREATER THAN 1" PIPE</div>
<div>FC122</div>	SAMSUNG										122 SINGLE	<div>123</div>													
<div>FC123</div>	SAMSUNG										123 SINGLE	<div>123</div>													
<div>FC124</div>	SAMSUNG										124 SINGLE	<div>123</div>													
<div>FC125</div>	SAMSUNG										125 SINGLE	<div>123</div>	<div>HP7</div>	SAMSUNG	AM048 FCMDCG	48	54	21.3/10.5	208/230-1-60	24	30	1.2 (x2)	19.3	243.6	<div>INSULATION SPECIFICATION:</div> <div>MATERIAL: LOW-DENSITY EPDM CLOSED-CELL ELASTOMERIC FOAM, CFC AND HCFC GAS FREE WITH OVERLAP SEAL.</div> <div>THERMAL CONDUCTIVITY: 0.235 (BTU*in/hr*fi²*F) AT 75°F.</div> <div>WATER VAPOR PERMEABILITY: &lt;0.03 PERM (4.38 x 10¹¹ g/Po*s*m) PER ASTM E96.</div> <div>WATER ABSORPTION: &lt;0.2% BY VOLUME PER ASTM C 209.</div> <div>WORKING TEMPERATURE: -70°F TO 257°F (-57°C TO 125°C) CONTINUOUS PER ASTM C 411.</div> <div>SURFACE BURNING CHARACTERISTICS: MEETS 25/50 FLAME-SPREAD/ SMOKE-GENERATED PER UL723 AND ASTM E84. ADDITIONALLY MEETS UL-945 V-A, V-O AND IS SELF-EXTINGUISHING PER ASTM D 635.</div> <div>UV RESISTANT: EPDM PROVIDES UV RESISTANCE IN ACCORDANCE WITH ASTM G7/G90.</div> <div>OZONE RESISTANT: MEETS ASTM D 1171.</div> <div>TITLE 24 INSULATION WALL THICKNESS SPECIFICATION:</div> <div>HOT GAS PIPES: ABOVE 200°F (3-PIPE HEAT RECOVERY SYSTEM) USE 2½" WALL THICKNESS; BELOW 200°F (2-PIPE HEAT RECOVERY SYSTEMS) USE 1½" WALL THICKNESS; (HEAT PUMPS AND LINE SETS FOLLOW THE SAME ABOVE REQUIREMENTS BASED ON PIPE TEMPERATURES). NOTE: 2½" THICKNESS REQUIRES DOUBLE LAYERS TO MEET 25/50 FIRE/SMOKE CODES.</div> <div>LIQUID PIPES: 1" WALL THICKNESS</div> <div>SUCTION GAS PIPES: 1" WALL THICKNESS FOR LESS THAN 1" PIPE; 1½" WALL THICKNESS FOR GREATER THAN 1" PIPE</div>
<div>FC126</div>	SAMSUNG										126 SINGLE	<div>123</div>													
<div>FC127</div>	SAMSUNG										127 SINGLE	<div>123</div>													
<div>FC128</div>	SAMSUNG										128 SINGLE	<div>123</div>													
<div>FC129</div>	SAMSUNG										129 SINGLE	<div>123</div>	<div>HP8</div>	SAMSUNG	AM048 FCMDCG	48	54	21.3/10.5	208/230-1-60	24	30	1.2 (x2)	19.3	243.6	<div>INSULATION SPECIFICATION:</div> <div>MATERIAL: LOW-DENSITY EPDM CLOSED-CELL ELASTOMERIC FOAM, CFC AND HCFC GAS FREE WITH OVERLAP SEAL.</div> <div>THERMAL CONDUCTIVITY: 0.235 (BTU*in/hr*fi²*F) AT 75°F.</div> <div>WATER VAPOR PERMEABILITY: &lt;0.03 PERM (4.38 x 10¹¹ g/Po*s*m) PER ASTM E96.</div> <div>WATER ABSORPTION: &lt;0.2% BY VOLUME PER ASTM C 209.</div> <div>WORKING TEMPERATURE: -70°F TO 257°F (-57°C TO 125°C) CONTINUOUS PER ASTM C 411.</div> <div>SURFACE BURNING CHARACTERISTICS: MEETS 25/50 FLAME-SPREAD/ SMOKE-GENERATED PER UL723 AND ASTM E84. ADDITIONALLY MEETS UL-945 V-A, V-O AND IS SELF-EXTINGUISHING PER ASTM D 635.</div> <div>UV RESISTANT: EPDM PROVIDES UV RESISTANCE IN ACCORDANCE WITH ASTM G7/G90.</div> <div>OZONE RESISTANT: MEETS ASTM D 1171.</div> <div>TITLE 24 INSULATION WALL THICKNESS SPECIFICATION:</div> <div>HOT GAS PIPES: ABOVE 200°F (3-PIPE HEAT RECOVERY SYSTEM) USE 2½" WALL THICKNESS; BELOW 200°F (2-PIPE HEAT RECOVERY SYSTEMS) USE 1½" WALL THICKNESS; (HEAT PUMPS AND LINE SETS FOLLOW THE SAME ABOVE REQUIREMENTS BASED ON PIPE TEMPERATURES). NOTE: 2½" THICKNESS REQUIRES DOUBLE LAYERS TO MEET 25/50 FIRE/SMOKE CODES.</div> <div>LIQUID PIPES: 1" WALL THICKNESS</div> <div>SUCTION GAS PIPES: 1" WALL THICKNESS FOR LESS THAN 1" PIPE; 1½" WALL THICKNESS FOR GREATER THAN 1" PIPE</div>
<div>FC130</div>	SAMSUNG										130 SINGLE	<div>123</div>													

1) PROVIDE FACTORY ADVANCED WIRED CONTROLLER. INSTALL PER MFR'S INSTRUCTIONS. 2) PROVIDE DRAIN PAN LEVEL SENSOR ACCESSORY PER EQUIPMENT SUPPLIER'S RECOMMENDATION AND OBSERVE MFR'S WIRING INSTRUCTIONS FOR UNIT SHUTDOWN IN THE EVENT OF PRIMARY CONDENSATE DRAIN BLOCKAGE. 3) PROVIDE AIR CLEANER, IWAVE-M #54XY42. 24VAC, POWERED BY THE FAN COIL UNIT, NO DEDICATED POWER SUPPLY. INSTALL PER MANUFACTURER'S INSTRUCTIONS. 4) INTEGRAL CONDENSATE LIFT MECHANISM, MAX 29" LIFT. 5) PROVIDE FACTORY SEACOAST-OPERATION CORROSION PROTECTION OPTION. 6) PROVIDE DRAIN TRENCH WITH GRAVEL FILL AROUND OUTDOOR UNIT MOUNTING PAD TO CAPTURE CONDENSATION RUNOFF. 7) PROVIDE MCM-A300UN CENTRAL CONTROLLER AND MIM-D01AUN DATA MANAGEMENT SERVER FOR WEB-INTERFACE. SEE CONTROLS DRAWINGS. 8) PROVIDE AIDOO PRO SAMSUNG NASA THERMOSTAT ADAPTER, #AZAIGWSPA2, AND VENSTAR T8900 THERMOSTAT. 9) MULTI-SPLIT. 3 FAN COILS, 1 OUTDOOR UNIT. INSTALL PER MANUFACTURER'S INSTRUCTIONS. PROVIDE ALL REQUIRED REFRIGERANT PIPING COMPONENTS, INCLUDING BRANCHES AND/OR HEADERS, FOR A COMPLETE WORKING INSTALLATION. SEE VRF PIPING SCHEMATICS, SHEET M3.2. CONTRACTOR TO OBSERVE MANUFACTURER'S REFRIGERANT LINESET LENGTH LIMITATIONS AND VERIFY REQUIRED PIPING LENGTHS PRIOR TO EQUIPMENT INSTALLATION.

REVISIONS		
#	DATE	DESCRIPTION
JOB NUMBER:		DJA-2501
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EQUIPMENT SCHEDULES & COMPLIANCE NOTES		
M1.2		



SINGLE ZONE SPLIT SYSTEM HEAT PUMPS

TAG	MANUFACTURER	MODEL (INDOOR UNIT)	CFM (LO-MED-HI)	OSA	ESP	ELECTRICAL			APPROX WEIGHT (LBS)	TAG	MANUFACTURER	MODEL (OUTDOOR UNIT)	AHRI COOLING (MBH)	AHRI HEATING (MBH)	SEER2/HSPF2	ELECTRICAL					APPROX WEIGHT (LBS)	NOTES	SERVES
						VOLT-PH-Hz	MCA	MOCP								VOLT-PH-Hz	MCA	MOCP	FAN (FLA)	COMP (RLA)			
<div>FC</div> <div>A</div>	SAMSUNG	AM060 FEZDCG	1113-1391-1769	700	1.0	208/230-1-60	7.5	15	175	<div>HP</div> <div>A</div>	SAMSUNG	AM060 FCMDCG	60	66	16.5/9.5	208/230-1-60	32.0	40	1.2 (x2)	19.3	244	<div>1</div> <div>2</div> <div>4</div> <div>5</div> <div>6</div> <div>7</div> <div>8</div>	02 GATHERING SPACE
<div>FC</div> <div>B</div>	SAMSUNG	AM036 DNZDCG	901-1074-1229	180	0.8	<div>3</div>			126	<div>HP</div> <div>B</div>	SAMSUNG	AM036 DXSCCG	36	40	18.7/9.5	208/230-1-60	35.8	40	1.2 (x2)	22.6	212	<div>1</div> <div>2</div> <div>4</div> <div>5</div> <div>6</div> <div>7</div>	OFFICES & LAUNDRY

1

INSTALL PER MANUFACTURER'S INSTRUCTIONS. PROVIDE ALL REQUIRED REFRIGERANT PIPING COMPONENTS, INCLUDING BRANCHES AND/OR HEADERS, FOR A COMPLETE WORKING INSTALLATION. 

2

PROVIDE FACTORY ADVANCED WIRED CONTROLLER. INSTALL PER MFR'S INSTRUCTIONS.

3

INDOOR UNIT IS POWERED BY OUTDOOR UNIT. 

4

PROVIDE DRAIN PAN LEVEL SENSOR ACCESSORY PER EQUIPMENT SUPPLIER'S RECOMMENDATION AND OBSERVE MFR'S WIRING INSTRUCTIONS FOR UNIT SHUTDOWN IN THE EVENT OF PRIMARY CONDENSATE DRAIN BLOCKAGE.

5

PROVIDE NEEDLEPOINT BI-POLAR IONIZER, PLASMA AIR 602 SERIES. 24VAC, POWERED BY THE FAN COIL UNIT, NO DEDICATED POWER SUPPLY. INSTALL PER MANUFACTURER'S INSTRUCTIONS. 

6

PROVIDE FACTORY SEACOAST-OPERATION CORROSION PROTECTION OPTION.

7

PROVIDE FACTORY "VFB-\_" SERIES FILTER BASE, SIZE PER MFR. PROVIDE PLEATED FILTERS, MINIMUM MERV-13.

8


PROVIDE FACTORY SUPPLEMENTAL ELECTRIC HEATING KIT, VHK-305C. 208/230V, kW: 3.8/4.6, MCA: 29.4/32.5A, BREAKER: 30/35A.

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EXHAUST & SUPPLY FANS

TAG	MANUFACTURER	MODEL	CFM	CONT. CFM	ESP (IWG)	ELECTRICAL					BACKDRAFT DAMPER	SONES	MOUNTING	APPROX WEIGHT (LBS)	SERVES	NOTES
						VOLT-PH-Hz	AMPS	WATTS	MCA	MOCP	HP					
<div>CEF</div> <div>04</div>	PANASONIC	FV-05- 11VK3	80 <div>1</div>	30 <div>2</div>	0.25	120-1-60	0.16	9.2	-	-	-	INTEGRAL	0.3	<div>3</div>	9.5	RESTROOM 04 <div>4</div> <div>6</div>
<div>CEF</div> <div>09</div>	PANASONIC	FV-05- 11VK3	80 <div>1</div>	30 <div>2</div>	0.25	120-1-60	0.16	9.2	-	-	-	INTEGRAL	0.3	<div>3</div>	9.5	RESTROOM 09 <div>4</div> <div>6</div>
<div>CEF</div> <div>10</div>	PANASONIC	FV-11- 15VK3	150 <div>1</div>	50 <div>2</div>	0.25	120-1-60	0.27	17.4	-	-	-	INTEGRAL	0.6	<div>3</div>	9.5	LAUNDRY 10 <div>4</div> <div>6</div>
<div>CEF</div> <div>R</div>	PANASONIC	FV-05- 11VK3	110 <div>1</div>	30 <div>2</div>	0.25	120-1-60	0.20	12.1	-	-	-	INTEGRAL	0.3	<div>3</div>	9.5	RESTROOM RESIDENTIAL UNIT <div>4</div> <div>5</div> <div>6</div> <div>7</div> <div>8</div> <div>9</div>
<div>EF</div> <div>R</div>	GREENHECK	SQ-9-VG	760	<div>10</div>	0.7	115-1-60	-	-	5.0	15	0.16	PROVIDE	6.0	<div>3</div>	97	RESIDENTIAL UNITS SUPPLY VENTILATION <div>7</div> <div>11</div>

1

"PICK-A-FLOW" SPEED SELECTOR SETTING. 

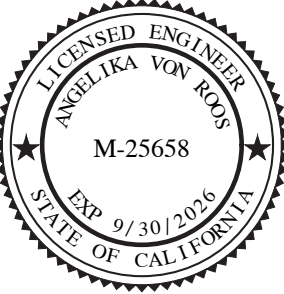2

PROVIDE PANASONIC "MULTI-SPEED WITH TIME DELAY" MODULE (FV-VS15VK1). 

3

PROVIDE FACTORY VIBRATION ISOLATION HARDWARE.

4

PROVIDE BIRD SCREEN AND WEATHER PROTECTION AT TERMINATION TO OUTDOORS. 

5

PROVIDE PANASONIC CONDENSATION SENSOR MODULE (FV-CSVK1). 

6

PROVIDE PANASONIC MOTION SENSOR MODULE (FV-MSVK1).

7

CONTRIBUTES TO COMPLIANCE WITH MANDATORY REQUIREMENTS FOR VENTILATION & INDOOR AIR QUANTITY. 

8

QUANTITY: 30. 

9

PROVIDE FACTORY RADIATION DAMPER ACCESSORY (PC-RD05C5).

10

PROVIDE FACTORY SPEED CONTROLLER. FAN SHALL OPERATE OPERATE CONTINUOUSLY, PROVIDE CLEARLY LABELED SHUTOFF SWITCH LOCATED IN MECHANICAL ROOM 11.

11

PROVIDE FACTORY GALVANIZED FILTER BOX WITH 2" MERV-13 PLEATED FILTERS.

AIR TERMINAL SCHEDULE

TAG	MANUFACTURER	MODEL	APPLICATION	NOTES
<div>SIZE</div> <div>A</div> <div>CFM</div>	TITUS	S300 SERIES	SPIRAL DUCT SUPPLY	<div>1</div> <div>2</div> <div>3</div> <div>4</div>
<div>SIZE</div> <div>B</div> <div>CFM</div>	METALAIRE	5000 SERIES	CEILING SUPPLY	<div>1</div> <div>2</div> <div>3</div> <div>4</div>
<div>SIZE</div> <div>C</div> <div>CFM</div>	METALAIRE			<div>1</div> <div>2</div> <div>3</div> <div>4</div>
<div>SIZE</div> <div>D</div> <div>CFM</div>	METALAIRE	RH SERIES	RETURN	<div>1</div> <div>3</div> <div>4</div>

1

FRAME TYPES & COLORS TO MATCH SURFACE FINISH. COORDINATE WITH ARCHITECT. 

2

AIR PATTERN AS SHOWN ON PLANS.

3

SIZING ON PLANS BASED ON ASSUMPTION OF 55% FREE AREA. VERIFY WITH MANUFACTURER.

4

COORDINATE DIMENSIONS WITH ARCH OR INTERIOR DESIGNER. REDUCTIONS IN TOTAL AREA SHALL BE COORDINATED WITH MECHANICAL DESIGNER.

- FILLER PANEL FOR T-BAR APPLICATIONS.

- ALL ALUMINUM CONSTRUCTION EXCEPT FOR FIRE RATED ASSEMBLIES THAT REQUIRE STEEL CONSTRUCTION.


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JOB NUMBER: DJA-2501		
DATE: 07/24/2025		

EQUIPMENT  
SCHEDULES &  
DETAILS

M1.3



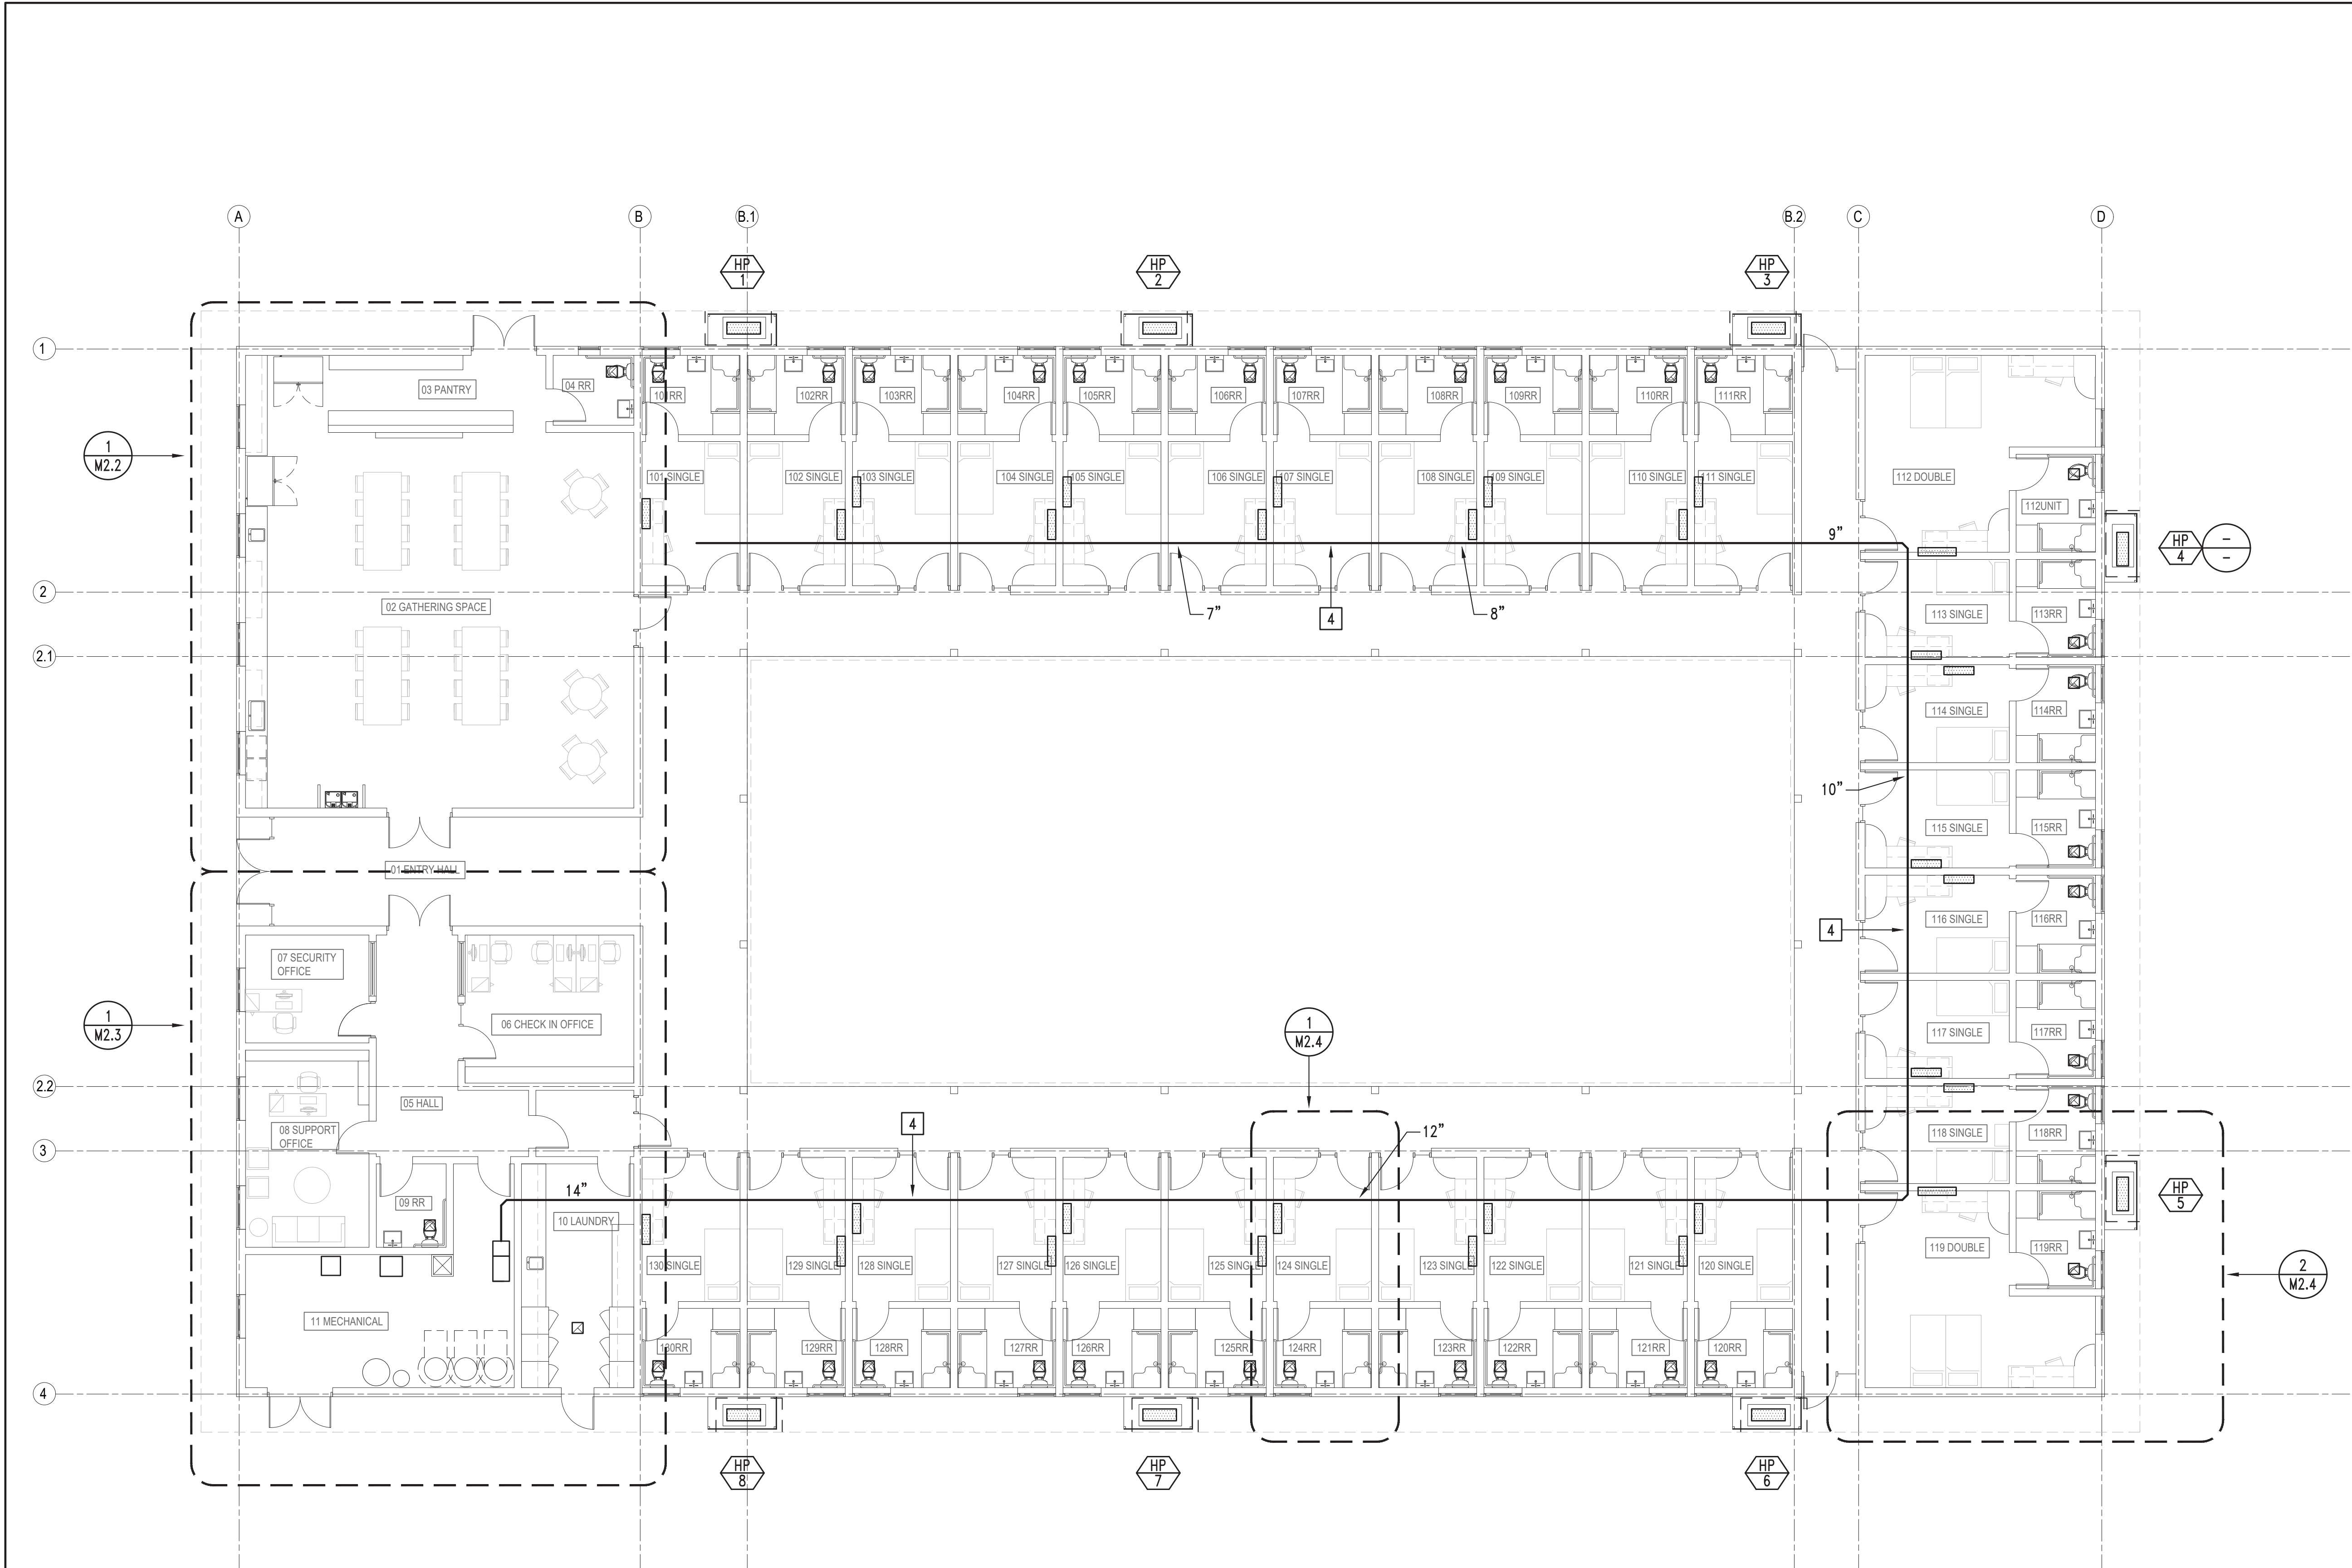

OVERALL MECHANICAL FLOOR PLAN


1/8" = 1'-0"



KEYNOTES


- 1 PROVIDE REFRIGERANT LINE SET. ROUTE TO CORRESPONDING INDOOR FAN COILS, SEE EQUIPMENT SCHEDULES. INSTALL PER MFR'S INSTRUCTIONS.
- 2 CONFORM TO MFR-RECOMMENDED CLEARANCES FOR AIRFLOW AND MAINTENANCE.
- 3 PROVIDE SHIELDED COMMUNICATIONS WIRING FOR ALL EQUIPMENT IN THE VICINITY OF ELECTRICAL EQUIPMENT OR DEVICES.
- 4 MAIN TRUNK DUCT IN ATTIC FOR COMMON SUPPLY COMPONENT OF RESIDENTIAL VENTILATION SYSTEM, SEE OVERALL FLOOR PLAN FOR SIZE, AND ENLARGED FLOOR PLANS FOR AIR DISTRIBUTION.

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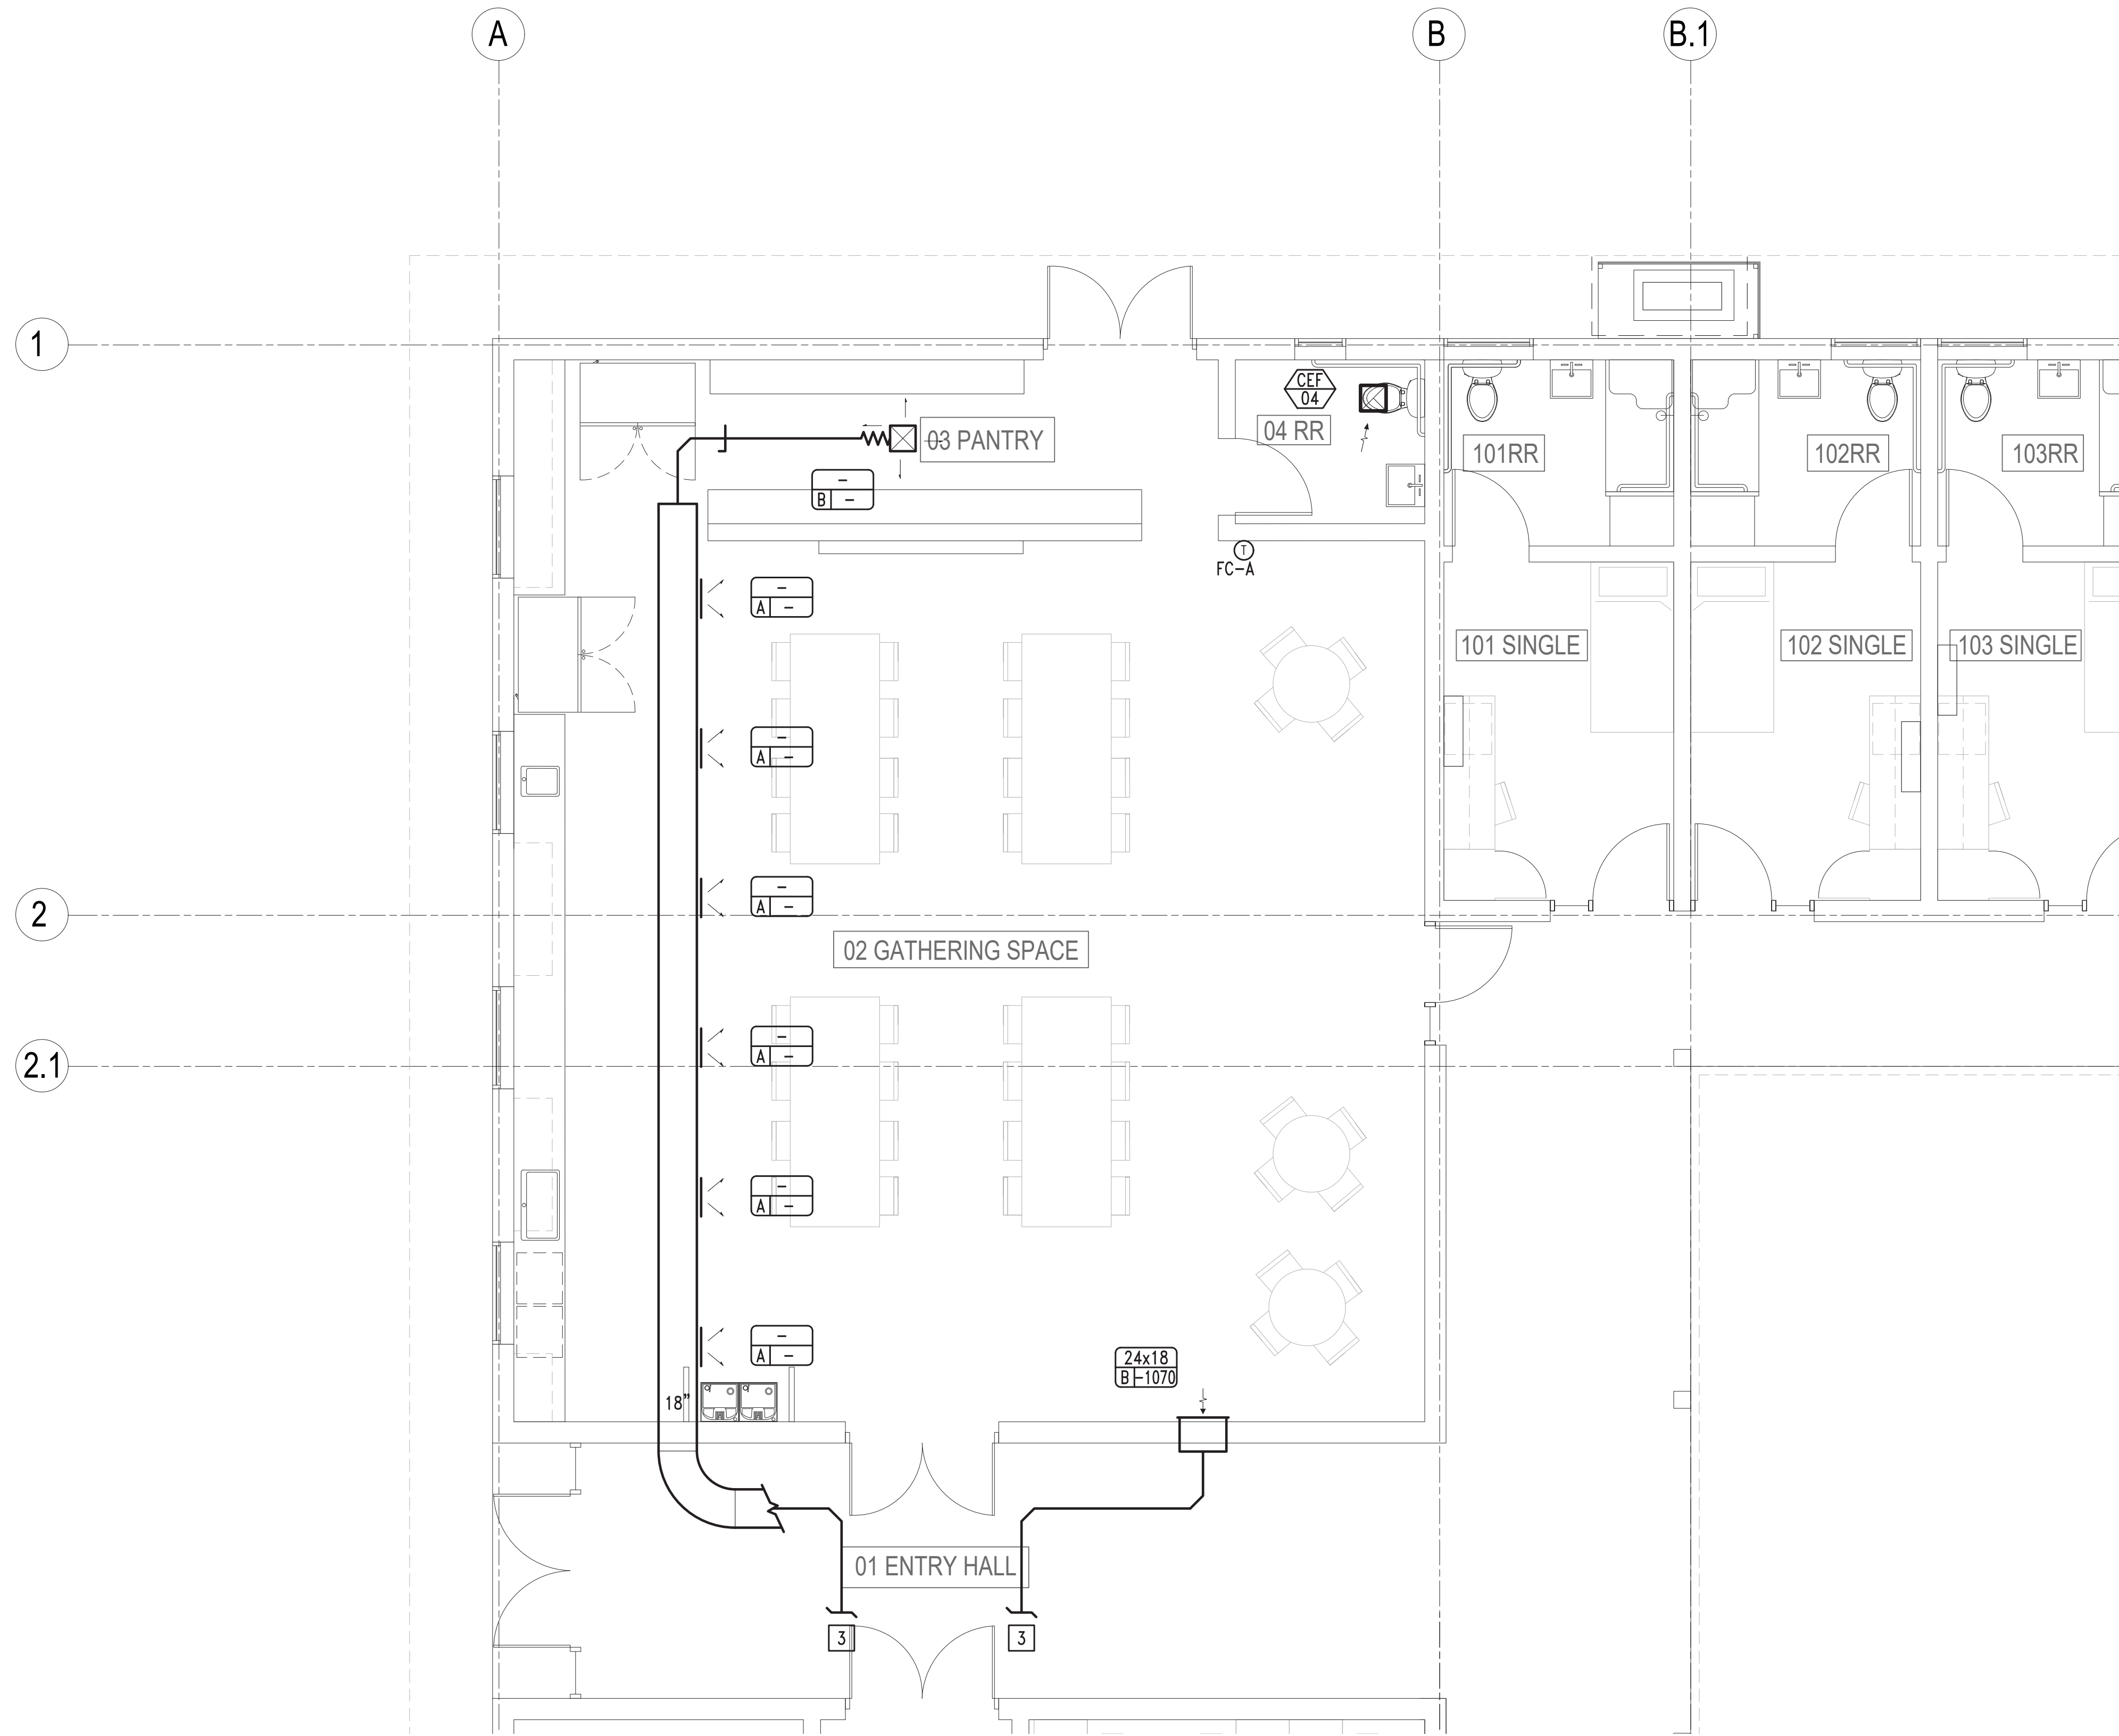
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#	DATE	DESCRIPTION
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OVERALL  
MECHANICAL  
FLOOR PLAN

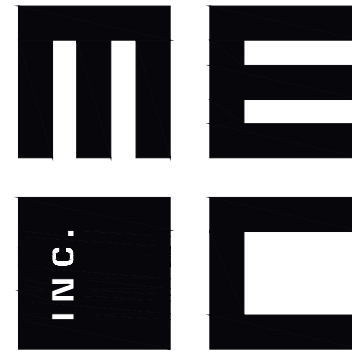M2.1



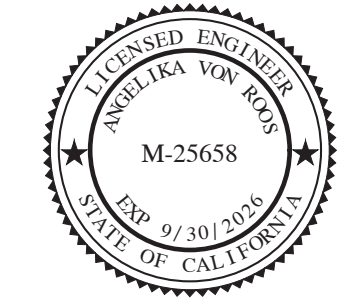

1 ENLARGED MECHANICAL FLOOR PLAN

1/4" = 1'-0"



KEYNOTES

- 1 TRANSITION DUCT FROM ROUND TO RECTANGULAR, ROUTE INTO DROPPED SOFFIT, COORDINATE WITH ARCHITECT.
- 2 ROUTE MIN. 6" EXHAUST DUCT TO ROOF. MAINTAIN MINIMUM 3'-0" FROM OPERABLE BUILDING OPENINGS. PROVIDE WEATHER PROTECTION AND BIRD SCREEN AT TERMINATION TO OUTDOORS.
- 3 SEE SHEET M2.3 FOR CONTINUATION.

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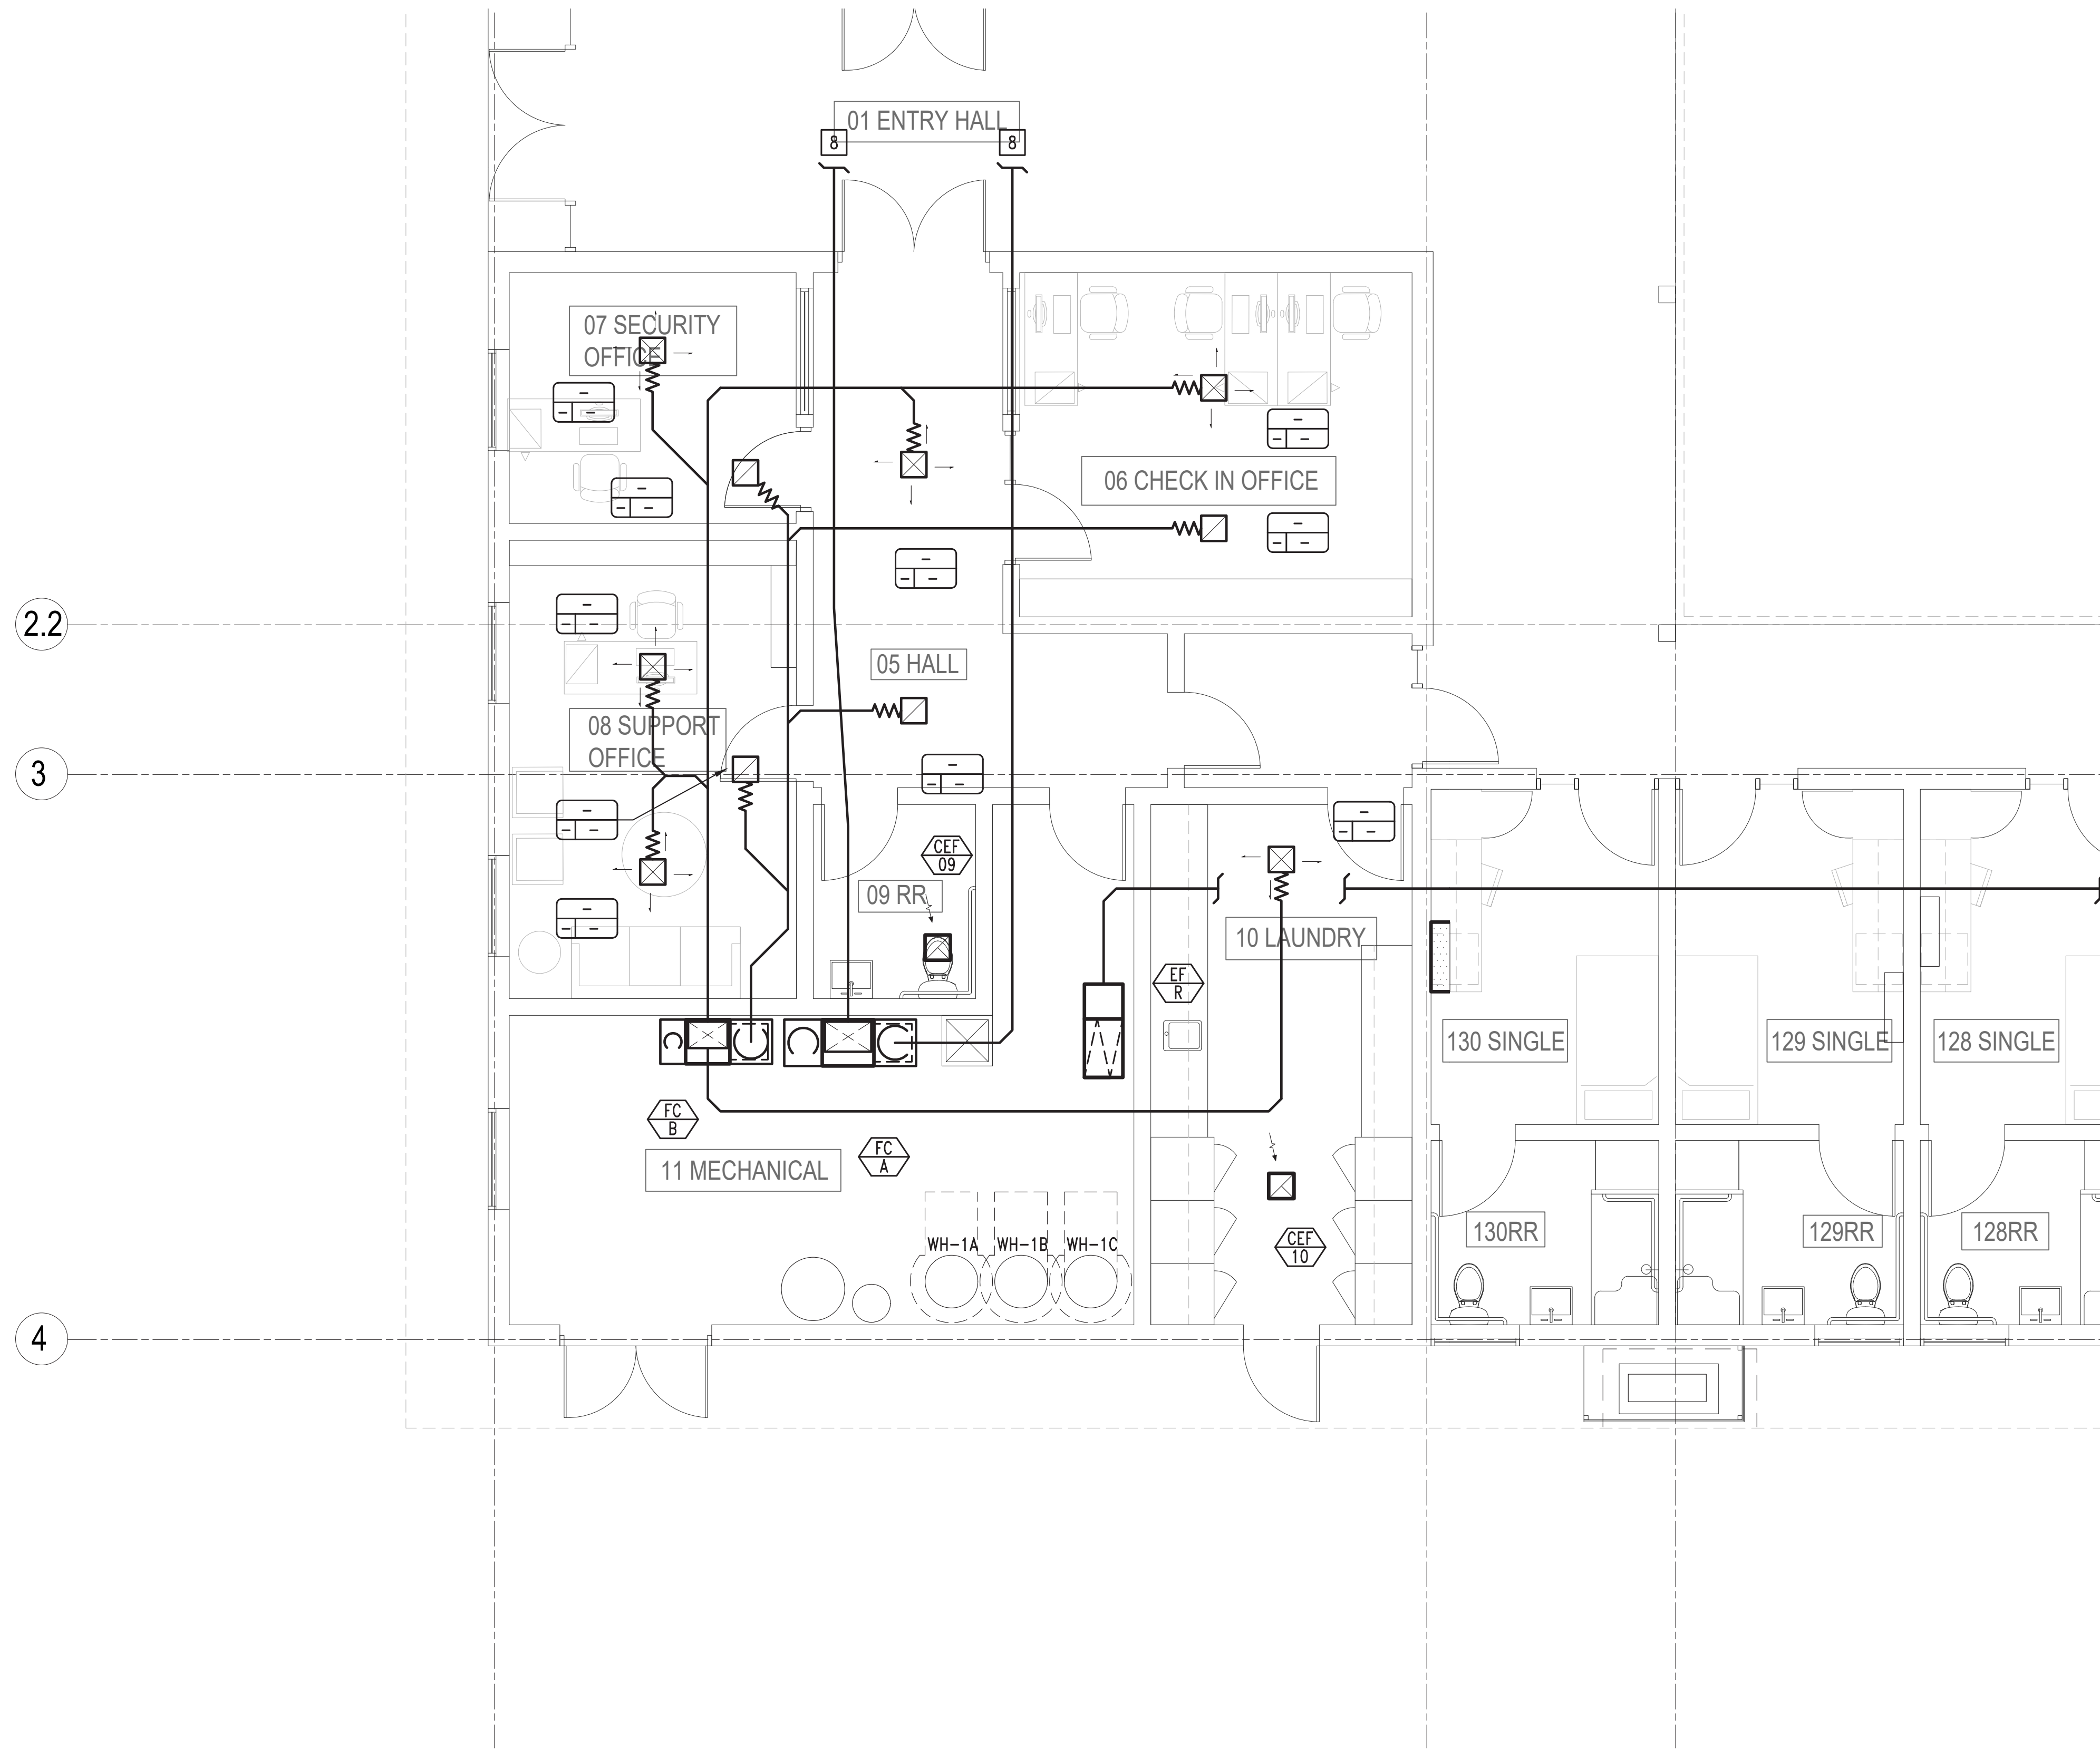
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DATE:		07/24/2025

ENLARGED  
MECHANICAL  
FLOOR PLAN

M2.2





1 ENLARGED MECHANICAL FLOOR PLAN

1/4" = 1'-0"

N

KEYNOTES

- 1
- ROUTE MIN 6" EXHAUST DUCT TO ROOF. MAINTAIN MINIMUM 3'-0" FROM OPERABLE BUILDING OPENINGS. MAINTAIN MINIMUM 3'-0" ABOVE OSA INTAKES WITHIN 10'-0". PROVIDE WEATHER PROTECTION AND BIRD SCREEN AT TERMINATION TO OUTDOORS.
- 2
- 4" DRYER VENT. TERMINATE TO EXTERIOR WITH BACKDRAFT DAMPER, MIN 3 FEET FROM PROPERTY LINE AND OPENINGS INTO BUILDING. EXHAUST DUCT FOR DOMESTIC DRYERS SHALL BE 4 INCHES MINIMUM, AND SHALL BE METAL AND HAVE A SMOOTH INTERIOR SURFACE. DUCT SHALL NOT EXCEED A TOTAL LENGTH OF 14 FEET INCLUDING TWO 90 DEGREE ELBOWS. TWO FEET SHALL BE DEDUCTED FOR EACH 90 DEGREE ELBOW IN EXCESS OF TWO. IF MAXIMUM LENGTH IS EXCEEDED, PROVIDE DRYER BOOSTER FAN BY ATMOSPHERE, OR EQUAL.
- 3
- PROVIDE DRAIN PIPE AND ROUTE FAN COIL CONDENSATE DRAIN TO APPROVED RECEPTOR PER PLUMBING PLAN.
- 4
- PROVIDE REFRIGERANT LINE SET. ROUTE TO CORRESPONDING FAN COIL. INSTALL PER MFR'S INSTRUCTIONS.
- 5
- CONFORM TO MFR-RECOMMENDED CLEARANCES FOR AIRFLOW AND MAINTENANCE.
- 6
- VOLUME BALANCING DAMPERS NOT READILY ACCESSIBLE IN THE ATTIC SHALL BE REMOTE, BATTERY OPERATED TYPE. COORDINATE CONTROL TERMINATION PANEL LOCATION WITH ARCHITECT, WITH EACH DAMPER LOCATION CLEARLY LABELED. INCLUDE ONE HAND HELD OPERATOR TO BE KEPT ON SITE FOR FUTURE BALANCING NEEDS. MANUFACTURER: METROPOLITAN AIR TECHNOLOGY, WWW.METAIRTECH.COM.
- 7
- PROVIDE SHIELDED COMMUNICATIONS WIRING FOR ALL EQUIPMENT IN THE VICINITY OF ELECTRICAL EQUIPMENT OR DEVICES.
- 8
- SEE SHEET M2.2 FOR CONTINUATION.
- 9
- MAIN RESIDENTIAL SUPPLY VENTILATION DUCT CONTINUATION, SEE OVERALL MECHANICAL FLOOR PLAN, SHEET M2.1.

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ENLARGED  
MECHANICAL  
FLOOR PLAN

M2.3


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- 1 ROUTE MIN 6" EXHAUST DUCT TO ROOF. MAINTAIN MINIMUM 3'-0" FROM OPERABLE BUILDING OPENINGS. PROVIDE WEATHER PROTECTION AND BIRD SCREEN AT TERMINATION TO OUTDOORS.
- 2 PROVIDE DRAIN PIPE AND ROUTE FAN COIL CONDENSATE DRAIN TO APPROVED RECEPTOR PER PLUMBING PLAN.
- 3 VOLUME BALANCING DAMPERS NOT READILY ACCESSIBLE IN THE ATTIC SHALL BE REMOTE, BATTERY OPERATED TYPE. COORDINATE CONTROL TERMINATION PANEL LOCATION WITH ARCHITECT, WITH EACH DAMPER LOCATION CLEARLY LABELED. INCLUDE ONE HAND HELD OPERATOR TO BE KEPT ON SITE FOR FUTURE BALANCING NEEDS. MANUFACTURER: METROPOLITAN AIR TECHNOLOGY, WWW.METAIRTECH.COM.
- 4 PROVIDE SHIELDED COMMUNICATIONS WIRING FOR ALL EQUIPMENT IN THE VICINITY OF ELECTRICAL EQUIPMENT OR DEVICES.
- 5 MAIN RESIDENTIAL SUPPLY VENTILATION DUCT CONTINUATION, SEE OVERALL MECHANICAL FLOOR PLAN, SHEET M2.1.



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JOB NUMBER: DJA-2501	
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## ENLARGED MECHANICAL FLOOR PLANS

## M2.4



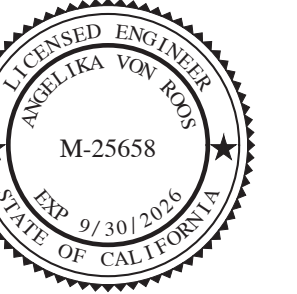


PLUMBING FIXTURES										ABBREVIATIONS										EST.1995 <div><div>ME</div><div>INC.</div><div>MECHANICAL ENGINEERING CONSULTANTS INC.</div></div> <div>315 E Canon Perdido, Ste B Santa Barbara, CA 93101 Tel (805) 957-4632</div>			
TAG	TYPE	MINIMUM CONNECTION SIZES				ELECTRICAL		SPECIFICATION		COMPRESSED AIR		MANHOLE		MINIMUM		MOUNTED		METAL					
		CW	HW	W	V	VOLTS	AMPS																
<div>WC</div> <div>1</div>	RESIDENTIAL UNIT WATER CLOSET	3/4"	–	4"	2"	–	–	SEE ARCHITECT FOR SPECIFICATION; ANGLE STOP: CHICAGO #1016-ABCP, & FLUIDMASTER NO BURST STAINLESS STEEL HOSE.		A	COMPRESSED AIR	MH	MANHOLE	MIN	MINIMUM	MTD	MOUNTED	MTL	METAL	MECHANICAL ENGINEERING CONSULTANTS INC.			
<div>WC</div> <div>2</div>	COMMON AREA WATER CLOSET	3/4"	–	4"	2"	–	–	SEE ARCHITECT FOR SPECIFICATION; ANGLE STOP: CHICAGO #1016-ABCP, & FLUIDMASTER NO BURST STAINLESS STEEL HOSE.		AFS	ABOVE FINISHED FLOOR	MIN	MINIMUM	MTD	MOUNTED	MTL	METAL						
<div>LAV</div> <div>1</div>	RESIDENTIAL UNIT LAVATORY	1/2"	1/2"	2"	1–1/2"	–	–	SEE ARCHITECT FOR SPECIFICATION; SUPPLIES/STOPS: CHICAGO #1016-ABCP.		AP	ACCESS PANEL	(N)	NEW	NC	NORMALLY CLOSED	NIC	NOT IN CONTRACT	NTS	NOT TO SCALE	315 E Canon Perdido, Ste B Santa Barbara, CA 93101 Tel (805) 957-4632			
<div>LAV</div> <div>2</div>	COMMON AREA LAVATORY	1/2"	1/2"	2"	1–1/2"	–	–	SEE ARCHITECT FOR SPECIFICATION; SUPPLIES/STOPS: CHICAGO #1016-ABCP.		ARCH	ARCHITECTURAL DRAWINGS	N/A	NOT APPLICABLE	OD	OUTSIDE DIAMETER	OFD	OVERFLOW DRAIN	OFL	OVERFLOW RAINWATER LEADER				
<div>SH</div> <div>1</div>	SHOWER	1/2"	1/2"	2"	1–1/2"	–	–	SEE ARCHITECT FOR SPECIFICATION. CONTROL VALVE SHALL BE OF THE PRESSURE BALANCE, THERMOSTATIC, OR COMBINATION MIXING VALVE TYPE THAT PROVIDES SCALD AND THERMAL SHOCK PROTECTION FOR THE RATED FLOW RATE OF THE SHOWER HEAD, AND SHALL COMPLY WITH ASSE 1016/ASME A112.1016 OR ASME A112.18.1/CSA B125.1 PER CPC SECTION 408.3.		CGC	CALIFORNIA GREEN CODE	OW	OILY WASTE	P&T	PRESSURE & TEMPERATURE RELIEF	PLCS	PLACES	POC	POINT OF CONNECTION	DESIGNED ENGINEER ANSI-ISA 104.100 EXP. 9/30/2026 STATE OF CALIFORNIA M-25658			
<div>FD</div> <div>1</div>	SHOWER FLOOR DRAIN	–	–	2"	1–1/2"	–	–	SEE ARCHITECT FOR SPECIFICATION.		CO	CLEANOUT	RD	ROOF DRAIN	REQD	REQUIRED	RLA	RATED LOAD AMPS	RWL	RAIN WATER LEADER				
<div>FD</div> <div>2</div>	FLOOR DRAIN	–	–	2"	1–1/2"	–	–	SEE ARCHITECT FOR SPECIFICATION. INCLUDE TRAP PRIMER CONNECTION; TRAP PRIMER: MIFAB M-500. INSTALL TRAP PRIMER ON CW SUPPLY OF FREQUENTLY USED FIXTURE WITH ISOLATION BALL SOV, WITH ACCESS.		CONT	CONTINUATION	SD	STORM DRAIN	SF	SQUARE FEET	SMH	SEWER MAN HOLE	SOV	SHUT OFF VALVE	OJAI PERMANENT SUPPORTIVE HOUSING Public Works Yard, Montgomery St Ojai, CA 93023			
<div>S</div> <div>1</div>	GATHERING SPACE KITCHEN SINK	1/2"	1/2"	2"	1–1/2"	–	–	SEE ARCHITECT FOR SPECIFICATION; SUPPLIES/STOPS: CHICAGO #1016-ABCP; CAST BRASS P-TRAP.		COTG	CLEAN OUT TO GRADE	SPEC	SPECIFICATIONS	STD	STANDARD	STL	STEEL	STRUCT	STRUCTURAL DRAWINGS				
<div>S</div> <div>2</div>	GATHERING SPACE BAR SINK	1/2"	1/2"	2"	1–1/2"	–	–	SEE ARCHITECT FOR SPECIFICATION; SUPPLIES/STOPS: CHICAGO #1016-ABCP; CAST BRASS P-TRAP.		CPC	CALIFORNIA PLUMBING CODE	SW	SOFTENED WATER	T24	CALIFORNIA ENERGY CODE	TMV	THERMOSTATIC MIXING VALVE	TW	TEMPERED WATER				
<div>S</div> <div>3</div>	LAUNDRY SINK	1/2"	1/2"	2"	1–1/2"	–	–	SEE ARCHITECT FOR SPECIFICATION; SUPPLIES/STOPS: CHICAGO #1016-ABCP; CAST BRASS P-TRAP.		CRC	CALIFORNIA RESIDENTIAL CODE	U	URINAL	UL	UNDERWRITERS' LABORATORIES, INC.	UNO	UNLESS NOTED OTHERWISE	UTR	UP THROUGH ROOF				
<div>FS</div> <div>1</div>	FLOOR SINK	–	–	2"	1–1/2"	–	–	JAY R. SMITH #3110, 12" TOP, NICKEL BRONZE GRATE.		CW	COLD WATER DOMESTIC	V	SANITARY VENT	VAC	HOUSE VACUUM	VB	VACUUM BREAKER	VR	VANDAL RESISTANT				
<div>MS</div> <div>1</div>	MOP SINK	3/4"	3/4"	3"	2"	–	–	FIAT #MSB2424 WITH GRID STRAINER, MOP HANGER; FAUCET: CHICAGO #540-LD897SWXFABCP, LEVER HANDLES WITH WALL BRACE, THREADED OUTLET & VACUUM BREAKER.		D	CONDENSATE OR EQUIPMENT DRAIN	W	SANITARY WASTE	W.C.	WATER COLUMN	WC	WATER CLOSET	WCO	WALL CLEAN OUT				
<div>DF</div> <div>1</div>	DRINKING FOUNTAIN	1/2"	–	2"	1–1/2"	–	–	HAWS #1011, DUAL HEIGHT, STAINLESS STEEL, LEAD FREE, SATIN FINISH, 6700.4 MOUNTING PLATE, 6800 CARRIER IF STUD WALL.		DIA	DIAMETER	WH	WATER HEATER	WHA	WATER HAMMER ARRESTER	WM	WATER METER	WT	WEIGHT				
										DN	DOWN												
										DW	DISHWASHER												
										DWGS	DRAWINGS												
										(E)	EXISTING												
										ELEC	ELECTRICAL DRAWINGS												
										ELEV	ELEVATION												
										EW	ELECTRIC WATER HEATER												
										(F)	FUTURE												
										FCO	FLOOR CLEAN OUT												
										FF	FINISHED FLOOR ELEVATION												
										FL	FLOW LINE												
										FLD	FLOOR DRAIN												
										FLR	FLOOR												
										FPM	FEET PER MINUTE												
										FS	FLOOR SINK												
										FT	FEET												
										G	GAS LINE (FUEL GAS)												
										GAL	GALLONS												
										GPC	GALLONS PER CYCLE												
										GP	GALLONS PER FLUSH												
										GC	GENERAL CONTRACTOR												
										GI	GALVANIZED IRON												
										GPM	GALLONS PER MINUTE												
										GW	GREASE WASTE												
										HB	HOSE BIBB												
										HP	HORSEPOWER												
										HW	HOT WATER DOMESTIC												
										HWR	HOT WATER RETURN DOMESTIC												
										IW	INDIRECT WASTE												
										KW	KILOWATT												
										LAV	LAVATORY												
										MBH	THOUSAND BTU PER HOUR												
										MFR	MANUFACTURER												
PLUMBING EQUIPMENT										SYMBOLS										DESIGN DEVELOPMENT - NOT FOR CONSTRUCTION			
TAG	TYPE	MIN CONNECTION SIZES & LOADS				GAS INPUT (MBH)		SPECIFICATION		WALL CLEAN OUT		3 WAY CONTROL VALVE		TRIPLE DUTY VALVE		UNION		STRAINER					
		CW	HW	VOLT–Ø	WATTS	AMPS																	
<div>WH</div> <div>1A</div>	HYBRID ELECTRIC WATER HEATER	3/4"	3/4"	208/240–1	4500	21	–	RHEEM PROFESSIONAL PRESTIGE PROTERRA HYBRID ELECTRIC HEAT PUMP MODEL #PROPH80 T2 RH400–30. 72 GALLON CAPACITY; HEAT PUMP MODULE: 4,200 BTUH, 4.07 UEF. ELECTRIC ELEMENT WATTAGE: 4,500 WATTS. MINIMUM BREAKER: 30A. 24.25" DIAMETER, 77" HEIGHT, 261 LBS. INSTALL PER MFR'S INSTRUCTIONS & RECOMMENDATIONS, INCLUDING "INSTALLATION GUIDELINES TO PROVIDE OPTIMAL EFFICIENCY."		<div></div>	WATER HAMMER ARRESTOR	<div></div>		<div></div>		<div></div>		<div></div>		<div></div>			
<div>WH</div> <div>1B</div>	HYBRID ELECTRIC WATER HEATER	3/4"	3/4"	208/240–1	4500	21	–	RHEEM PROFESSIONAL PRESTIGE PROTERRA HYBRID ELECTRIC HEAT PUMP MODEL #PROPH80 T2 RH400–30. 72 GALLON CAPACITY; HEAT PUMP MODULE: 4,200 BTUH, 4.07 UEF. ELECTRIC ELEMENT WATTAGE: 4,500 WATTS. MINIMUM BREAKER: 30A. 24.25" DIAMETER, 77" HEIGHT, 261 LBS. INSTALL PER MFR'S INSTRUCTIONS & RECOMMENDATIONS, INCLUDING "INSTALLATION GUIDELINES TO PROVIDE OPTIMAL EFFICIENCY."		<div></div>	PIPE DROP	<div></div>		<div></div>		<div></div>		<div></div>		<div></div>			
<div>WH</div> <div>1C</div>	HYBRID ELECTRIC WATER HEATER	3/4"	3/4"	208/240–1	4500	21	–	RHEEM PROFESSIONAL PRESTIGE PROTERRA HYBRID ELECTRIC HEAT PUMP MODEL #PROPH80 T2 RH400–30. 72 GALLON CAPACITY; HEAT PUMP MODULE: 4,200 BTUH, 4.07 UEF. ELECTRIC ELEMENT WATTAGE: 4,500 WATTS. MINIMUM BREAKER: 30A. 24.25" DIAMETER, 77" HEIGHT, 261 LBS. INSTALL PER MFR'S INSTRUCTIONS & RECOMMENDATIONS, INCLUDING "INSTALLATION GUIDELINES TO PROVIDE OPTIMAL EFFICIENCY."		<div></div>	PIPE RISER	<div></div>		<div></div>		<div></div>		<div></div>		<div></div>			
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										<div></div>	POINT OF DISCONNECTION	<div></div>		<div></div>		<div></div>		<div></div>		<div></div>			
										<div></div>	WASTE	<div></div>		<div></div>		<div></div>		<div></div>		<div></div>			
										<div></div>	VENT	<div></div>		<div></div>		<div></div>		<div></div>		<div></div>			
										<div></div>	FLOOR DRAIN	<div></div>		<div></div>		<div></div>		<div></div>		<div></div>			
										<div></div>	FLOOR SINK	<div></div>		<div></div>		<div></div>		<div></div>		<div></div>			
										<div></div>	PRESSURE & TEMPERATURE RELIEF VALVE	<div></div>		<div></div>		<div></div>		<div></div>		<div></div>			
										<div></div>	CHECK VALVE	<div></div>		<div></div>		<div></div>		<div></div>		<div></div>			
										<div></div>	BALL VALVE	<div></div>		<div></div>		<div></div>		<div></div>		<div></div>			
										<div></div>	BALL VALVE/MEMORY STOP	<div></div>		<div></div>		<div></div>		<div></div>		<div></div>			
										<div></div>	PRESSURE REDUCING VALVE	<div></div>		<div></div>		<div></div>		<div></div>		<div></div>			
										<div></div>	AUTOMATIC BALANCING VALVE	<div></div>		<div></div>		<div></div>		<div></div>		<div></div>			
										<div></div>	MANUAL SERVICE/BALANCING VALVE	<div></div>		<div></div>		<div></div>		<div></div>		<div></div>			
										<div></div>	BUTTERFLY VALVE	<div></div>		<div></div>		<div></div>		<div></div>		<div></div>			
										<div></div>	2 WAY CONTROL VALVE	<div></div>		<div></div>		<div></div>		<div></div>		<div></div>			
										<div></div>		<div></div>		<div></div>		<div></div>		<div></div>		<div></div>			
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OVERALL PLUMBING FLOOR PLAN



KEYNOTES

- 1 SEE CIVIL SITE UTILITY PLAN FOR CONTINUATION.
- 2 2% MINIMUM SLOPE ON ALL DRAINAGE PIPING.
- 3 ROUTE PIPING TO AVOID CONFLICTS WITH THE STRUCTURE, COORDINATE PIPING LOCATIONS RELATIVE TO BUILDING FOOTINGS WITH SEOR.
- 4 PROTECT THE INTEGRITY OF FIRE RATED ASSEMBLIES WITH UL LISTED FIRE STOP COMPATIBLE WITH THE PIPING MATERIALS AND CONSTRUCTION.
- 5 PROVIDE HEAT TAPE ON DOMESTIC HOT WATER DISTRIBUTION PIPING...
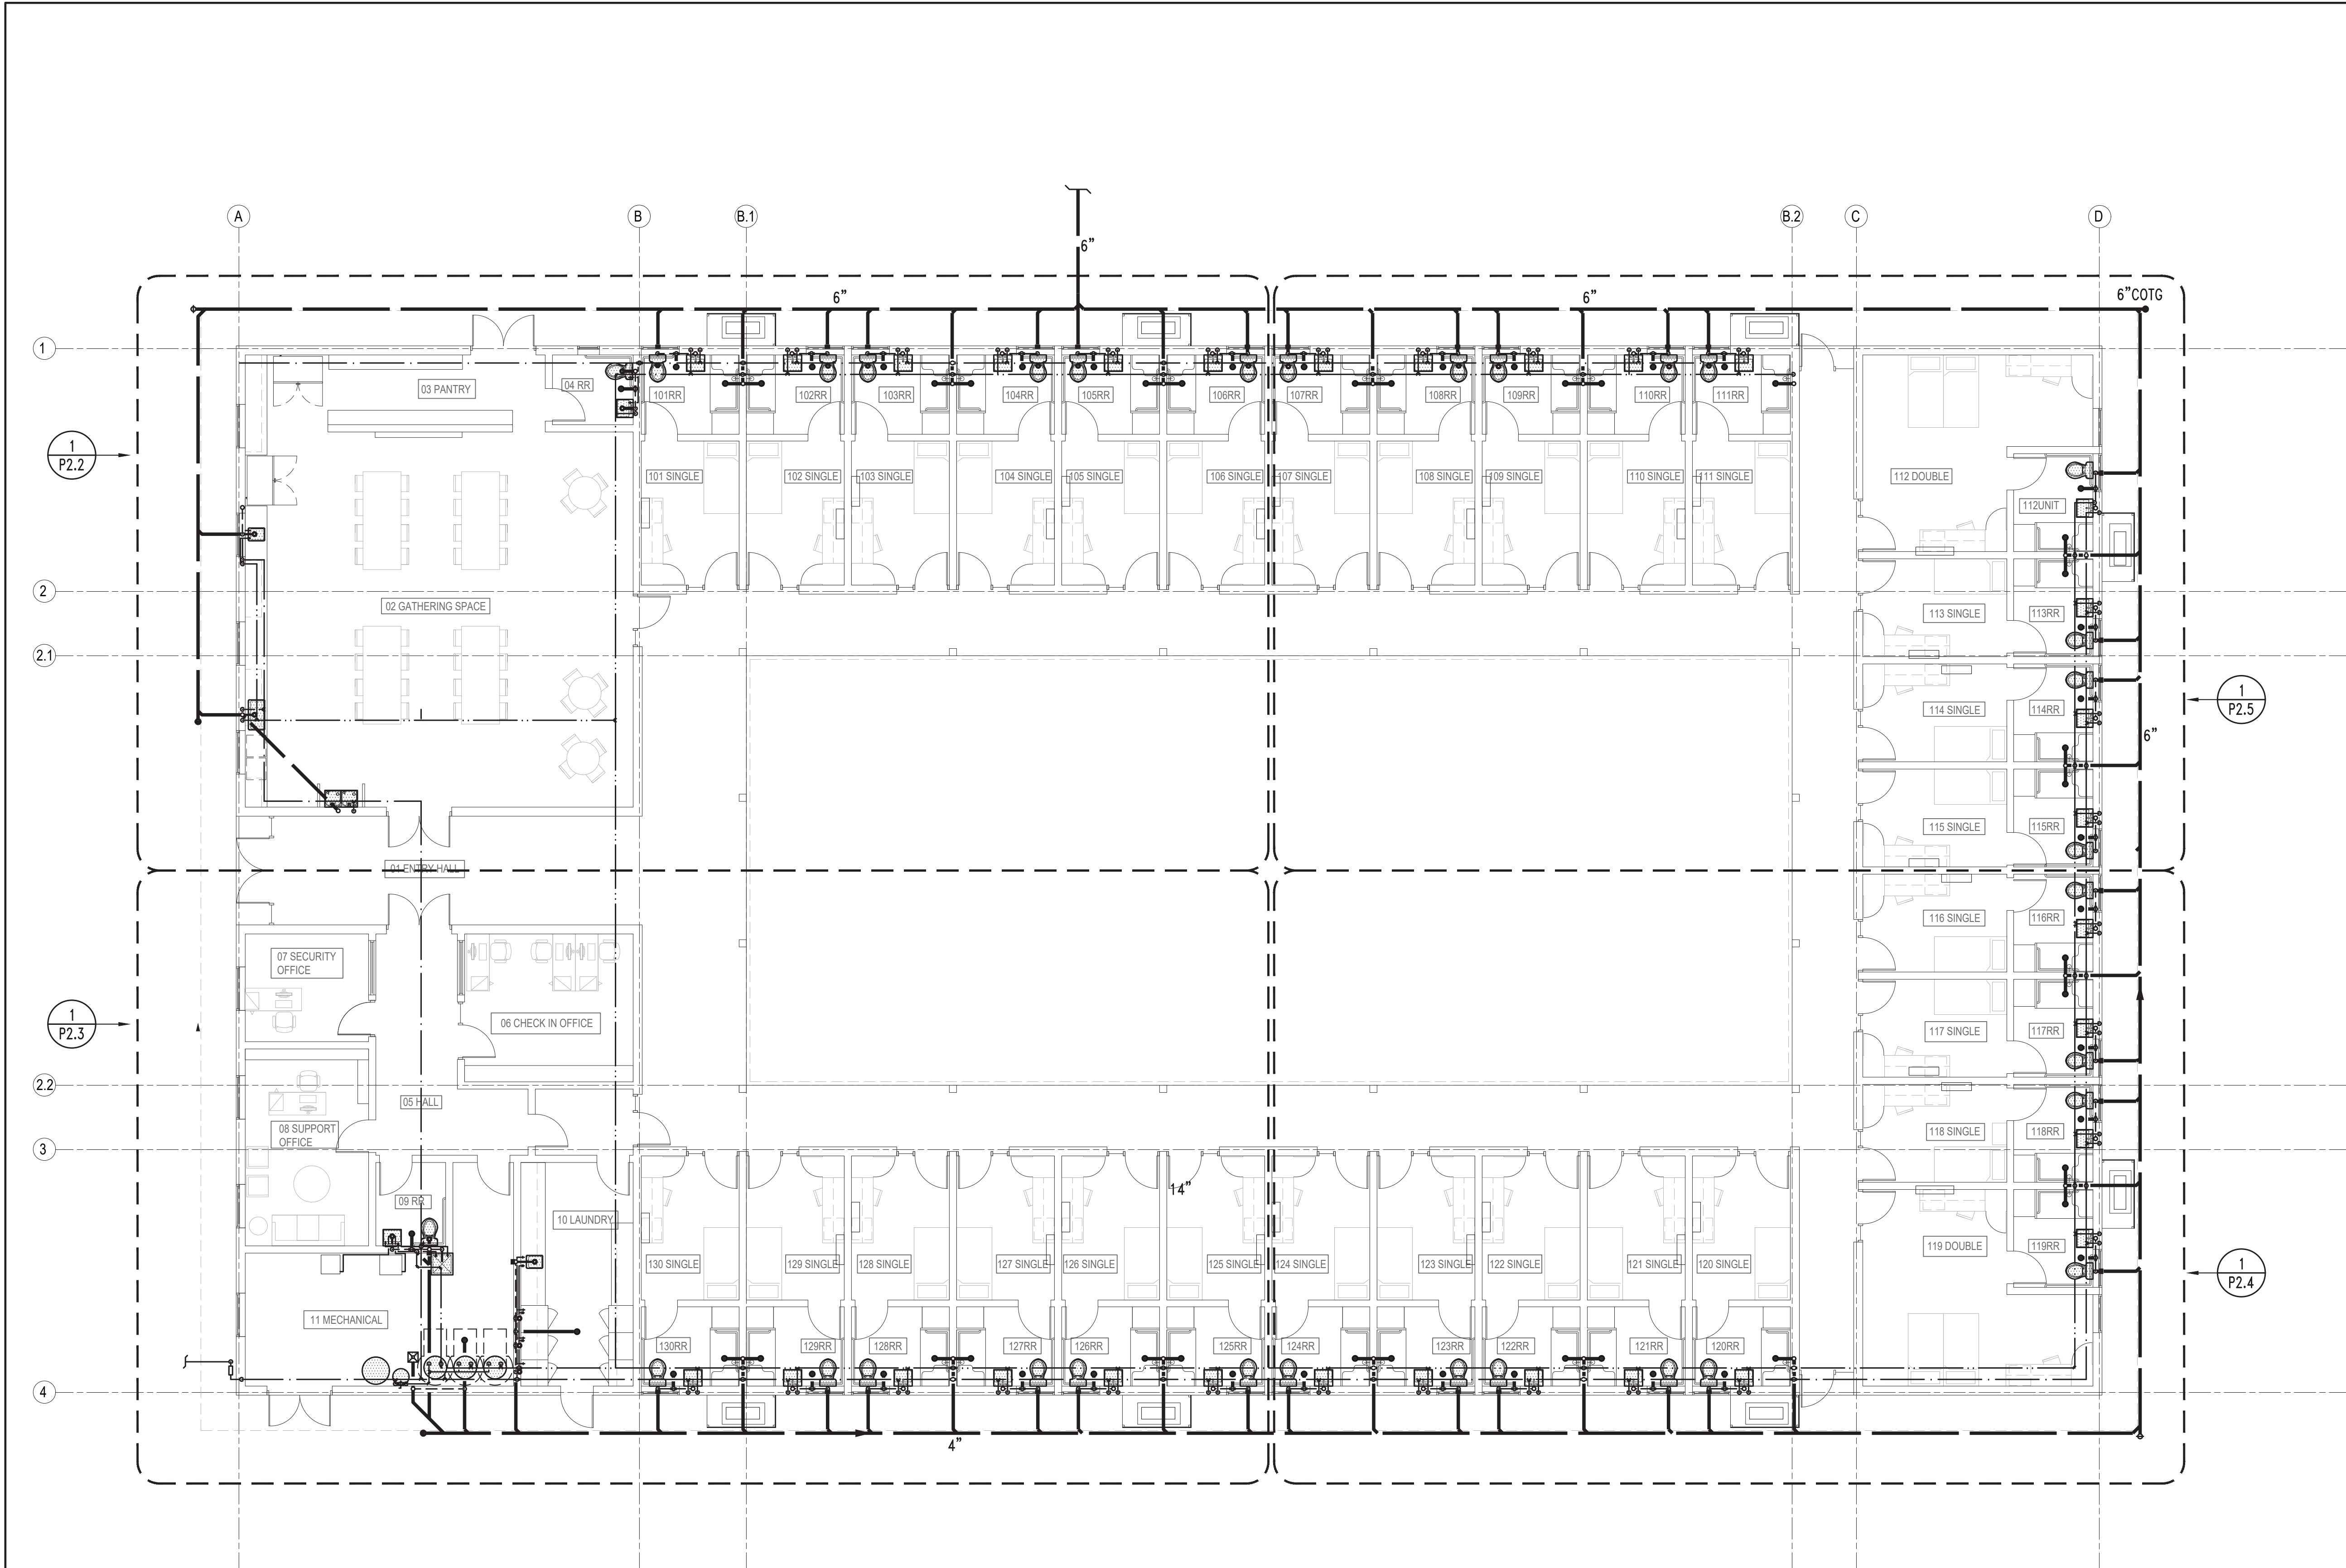
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315 E Canon Perdido, Ste B  
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DESIGN DEVELOPMENT - NOT FOR CONSTRUCTION

OJAI PERMANENT  
SUPPORTIVE HOUSING


Public Works Yard, Montgomery St  
Ojai, CA 93023

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#	DATE	DESCRIPTION
JOB NUMBER:		DJA-2501
DATE:		07/24/2025

OVERALL  
PLUMBING  
FLOOR PLAN

P2.1



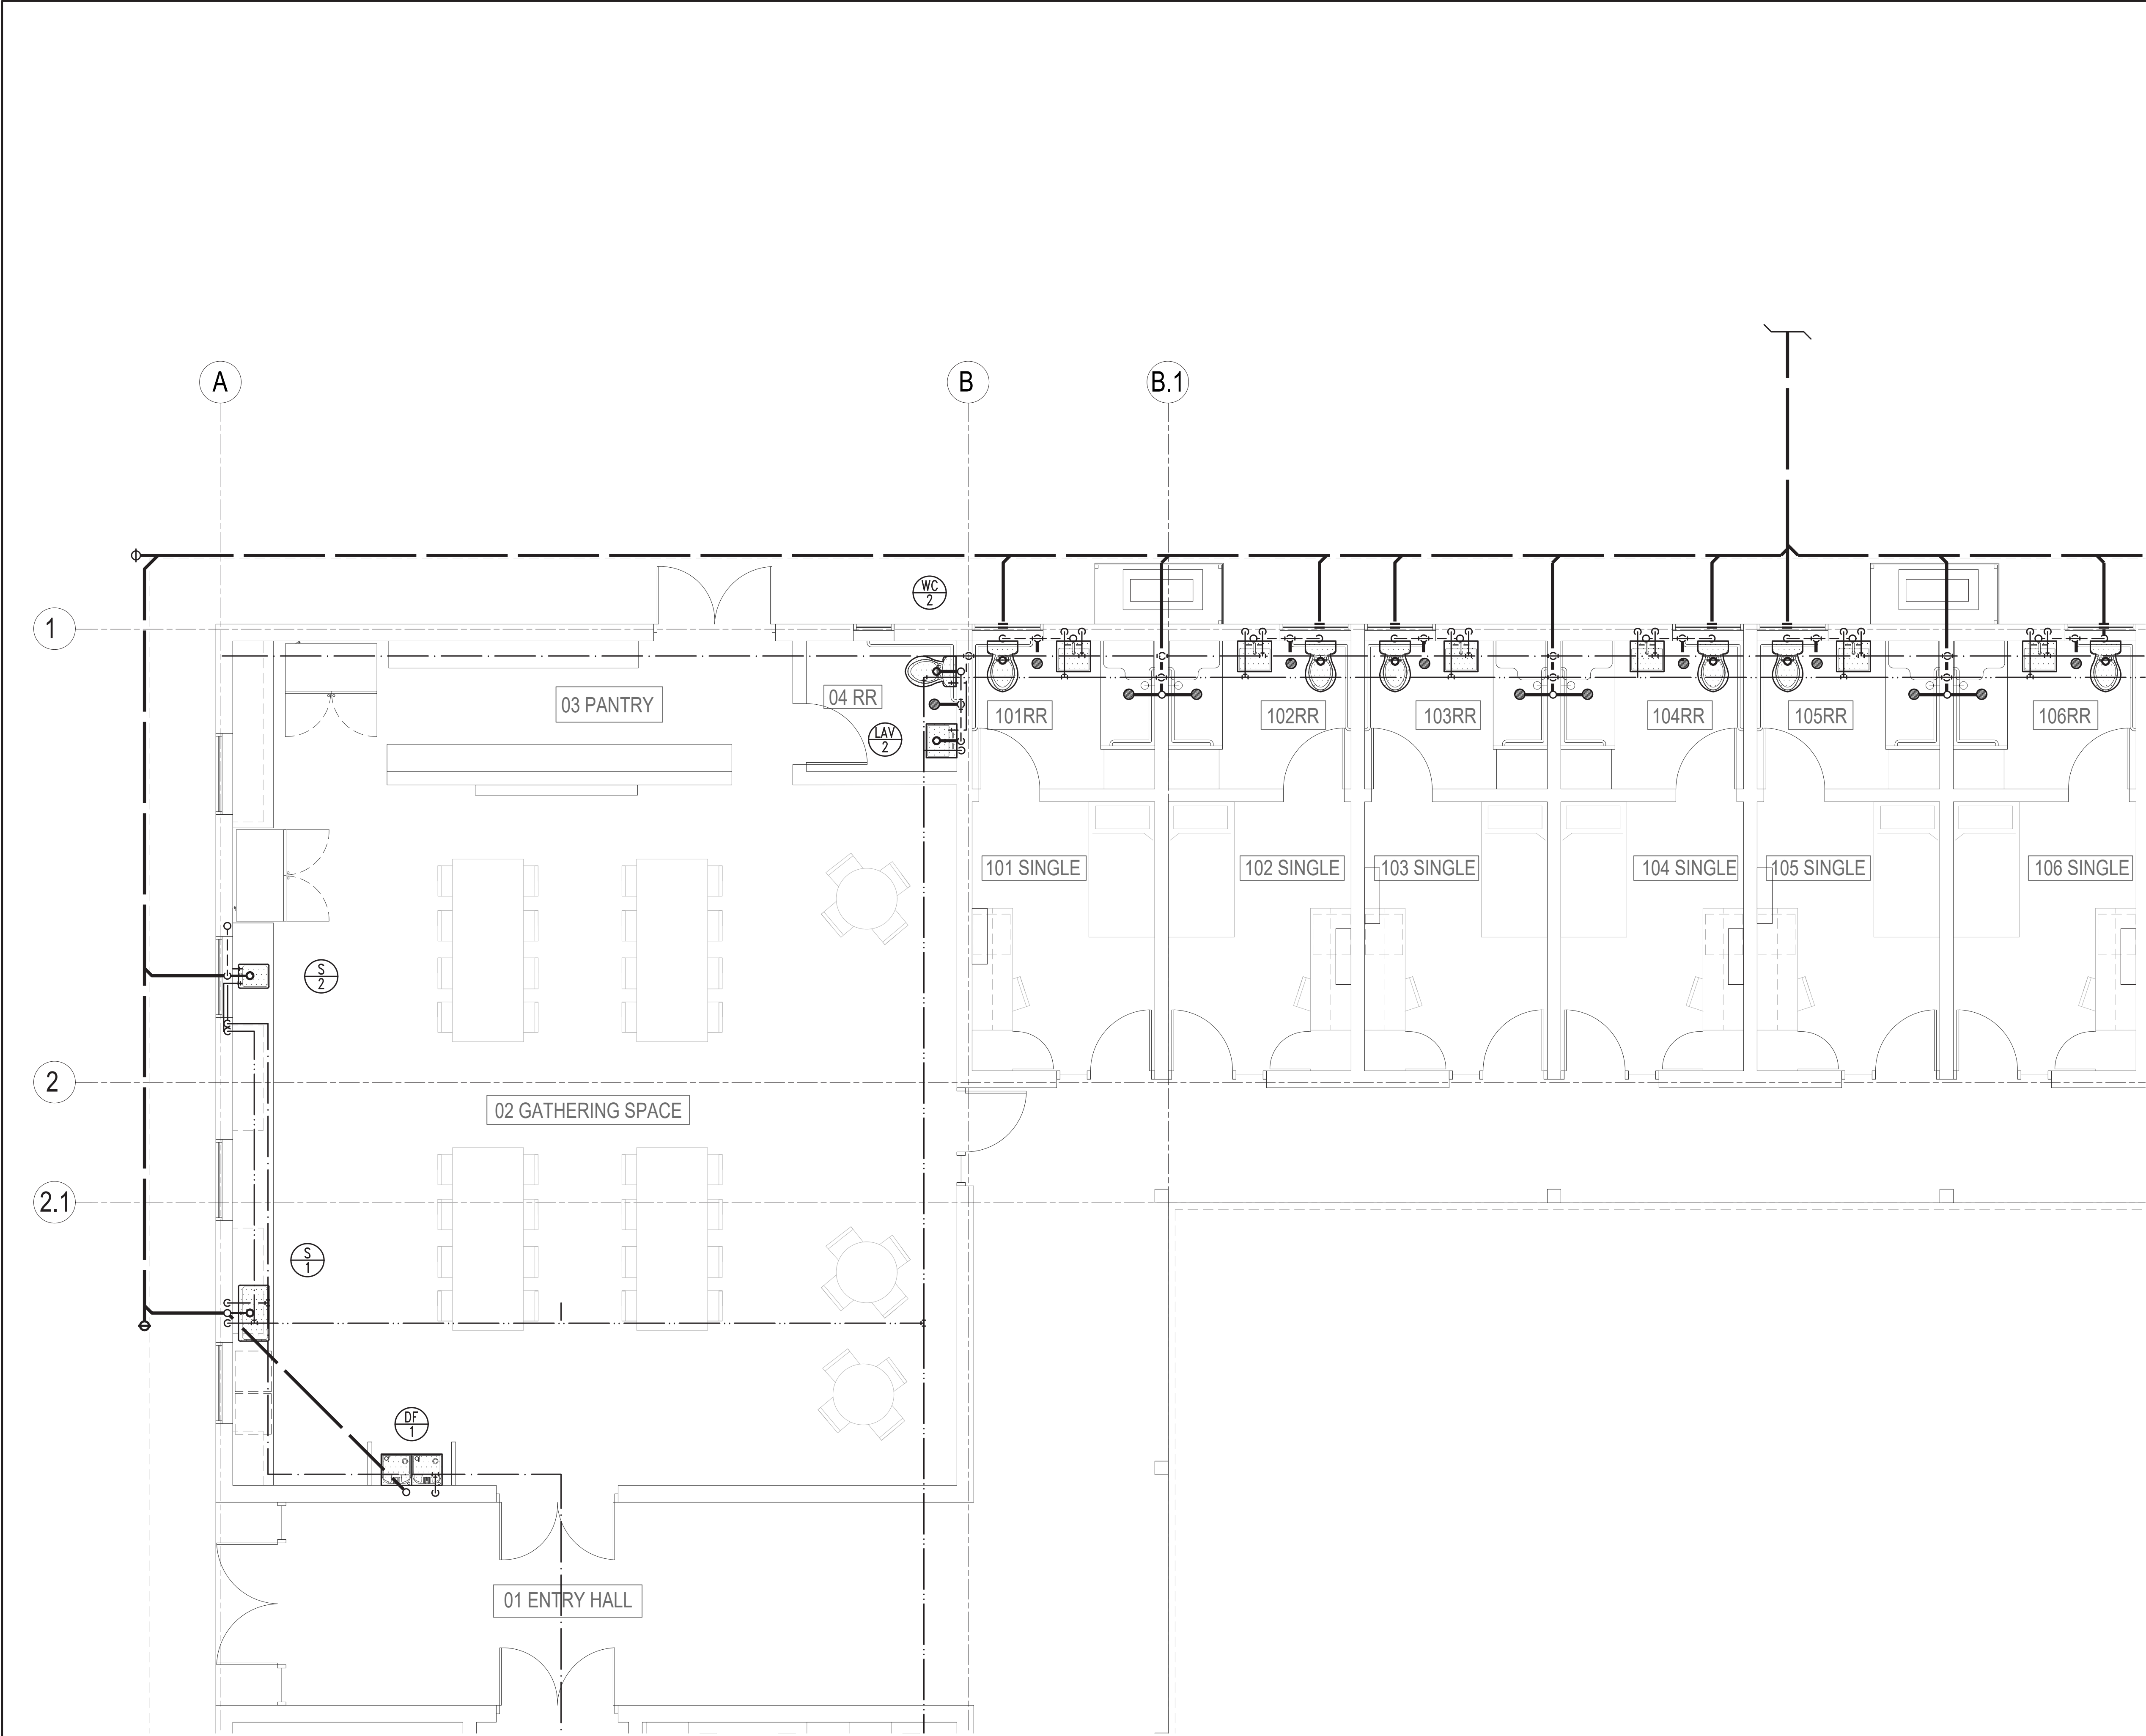

1 ENLARGED PLUMBING FLOOR PLAN

1/4" = 1'-0"



KEYNOTES


- 1 2% MINIMUM SLOPE ON ALL DRAINAGE PIPING.
- 2 ROUTE 1/2" HW TO DW. ROUTE IW FROM DW TO APPROVED AIR GAP FITTING AT SINK.
- 3 WHA WITH ACCESS.
- 4 ROUTE 1/2"CW TO REFRIGERATOR WITH ISOLATION VALVE, WATTS MODEL SD-2 (OR EQUAL) LEAD FREE STAINLESS STEEL BACKFLOW PREVENTER WITH ISOLATION VALVES, IN ACCESSIBLE LOCATION.
- 5 ROUTE PIPING TO AVOID CONFLICTS WITH THE STRUCTURE. STRUCTURAL MODIFICATIONS SHALL REQUIRE THE APPROVAL OF ARCHITECT AND SEOR.
- 6 PROTECT THE INTEGRITY OF FIRE RATED ASSEMBLIES WITH UL LISTED FIRE STOP COMPATIBLE WITH THE PIPING MATERIALS AND CONSTRUCTION.

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SUPPORTIVE HOUSING


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Ojai, CA 93023

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#	DATE	DESCRIPTION
JOB NUMBER:		DJA-2501
DATE:		07/24/2025

ENLARGED  
PLUMBING  
FLOOR PLAN

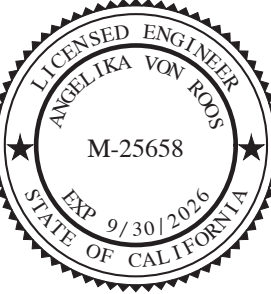P2.2



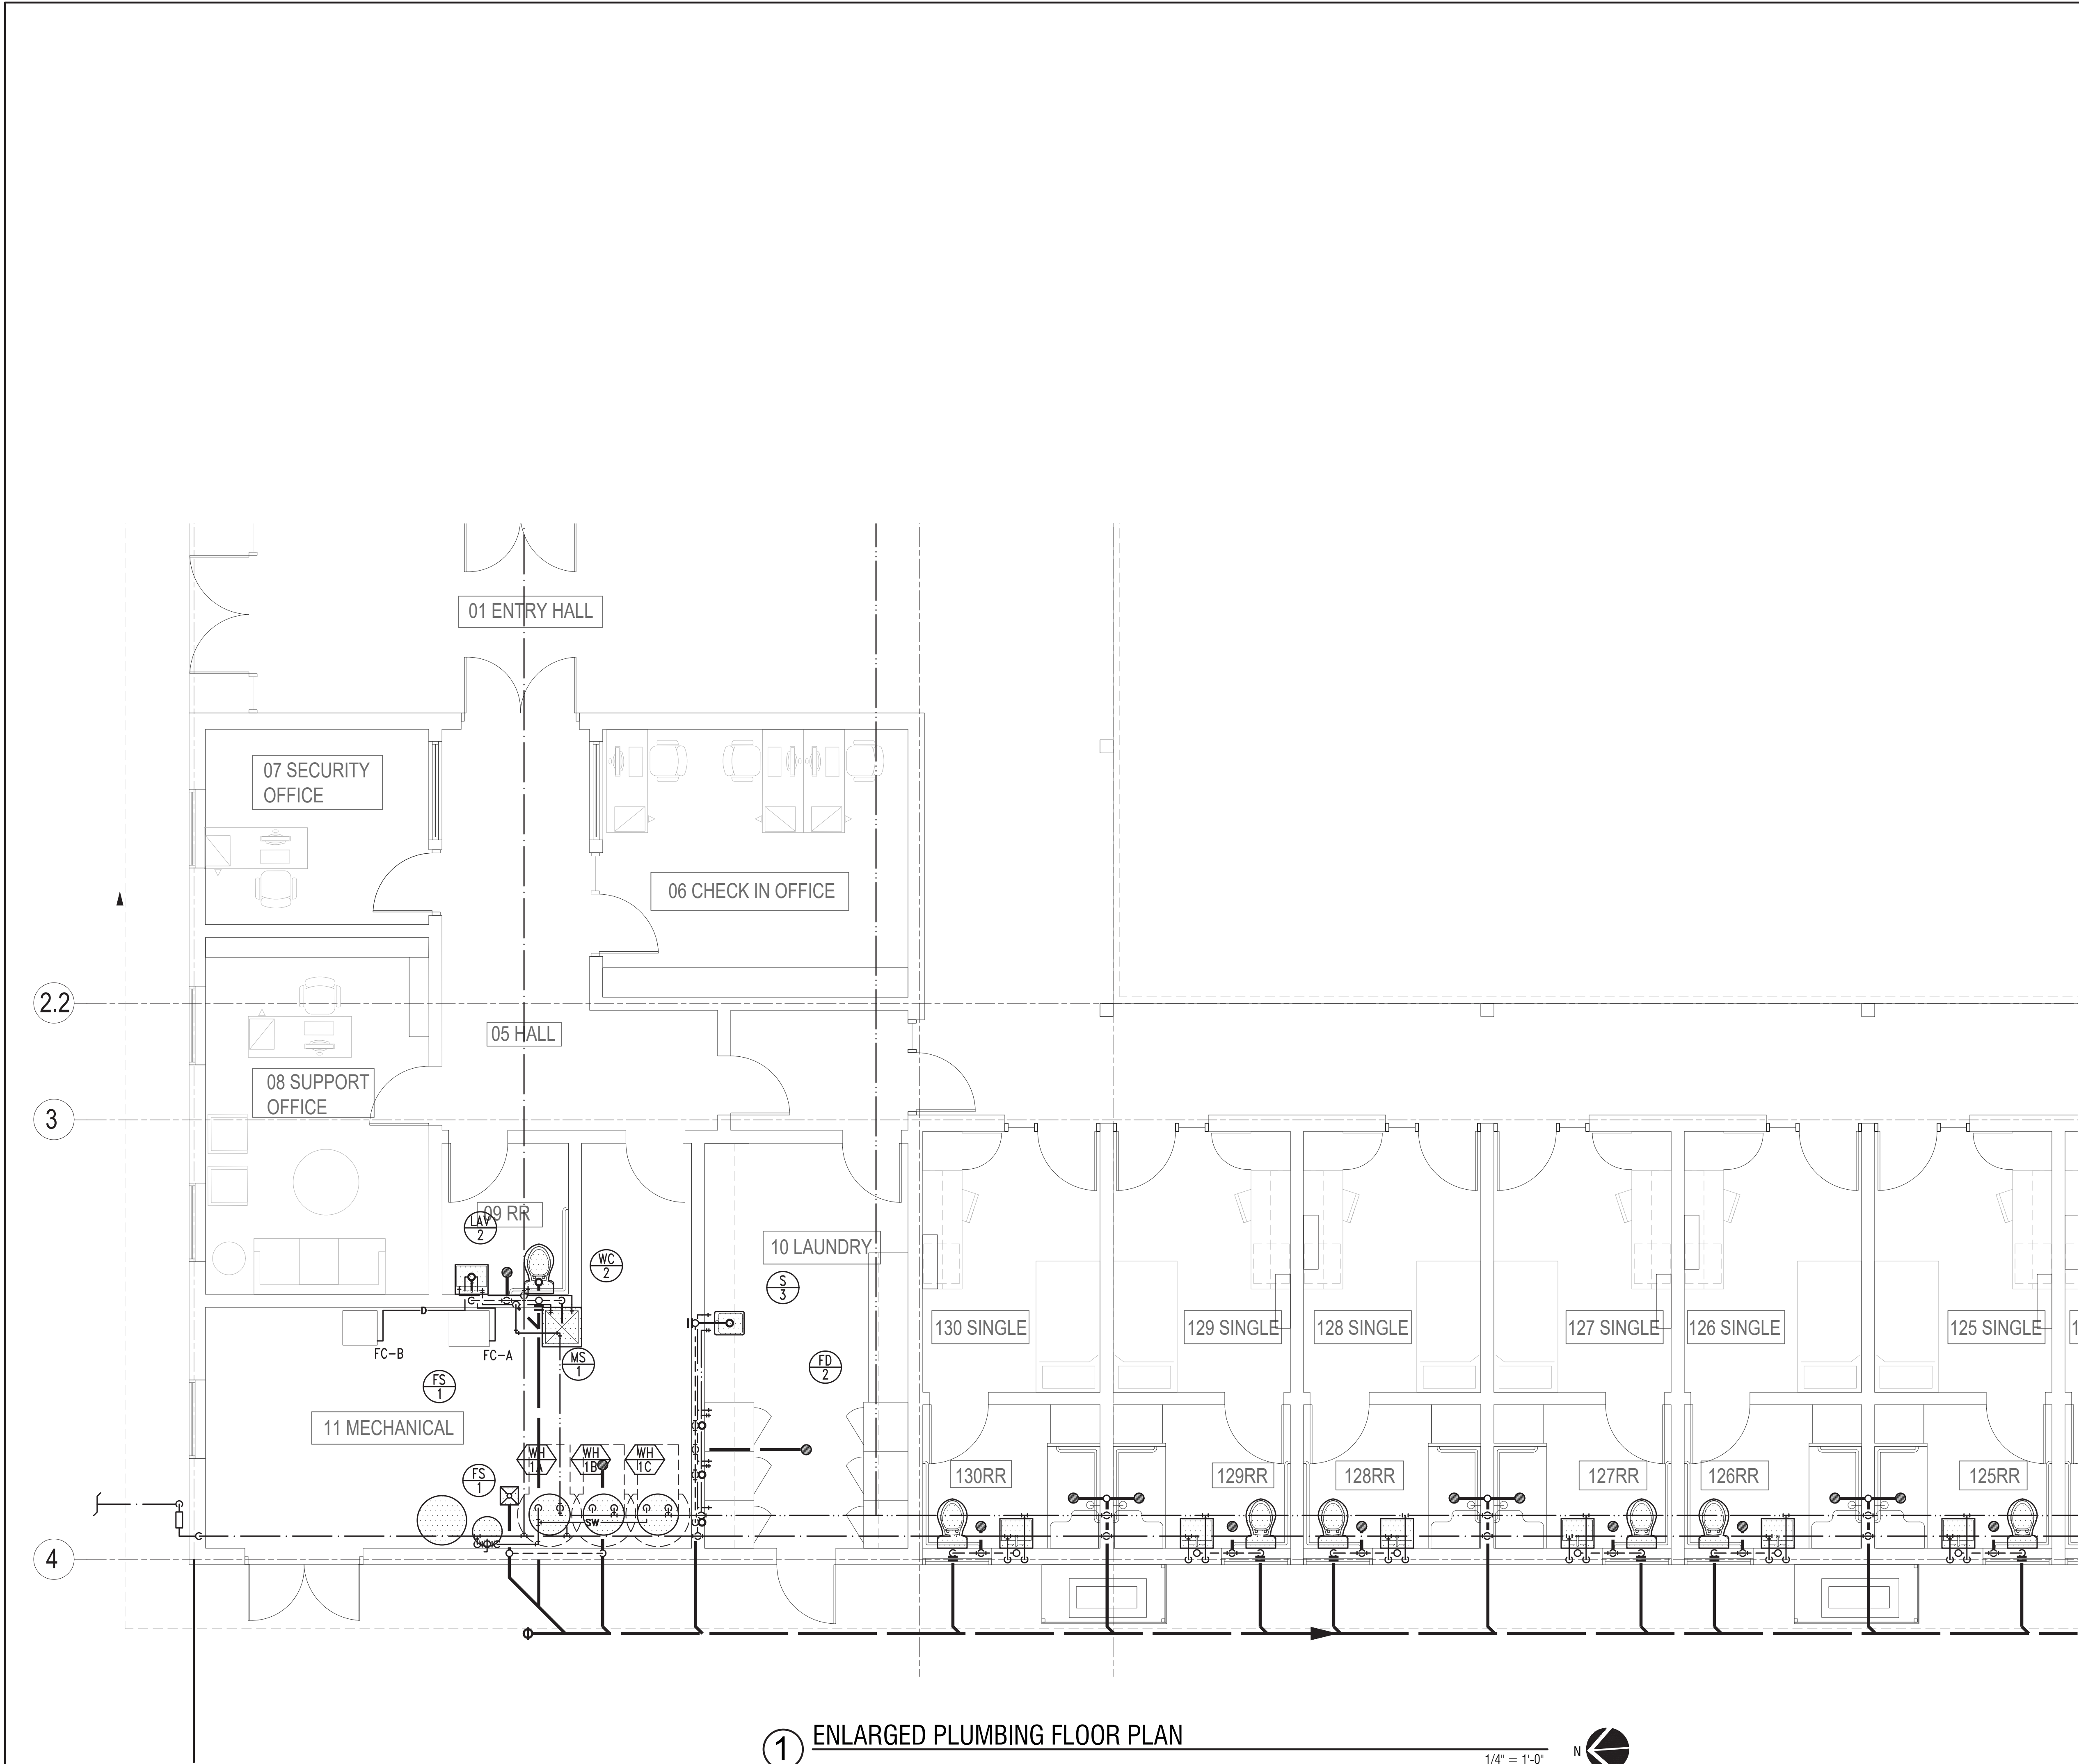

1 ENLARGED PLUMBING FLOOR PLAN

1/4" = 1'-0"



KEYNOTES


- 1 TO MIN 1½" WATER METER (64 GPM). PROVIDE APPROVED, TESTABLE REDUCED PRESSURE PRINCIPLE BACKFLOW PREVENTION ASSEMBLY, FEBCO LF825Y SERIES (LINE SIZE), OR EQUAL. ASSEMBLY SHALL BE LOCATED WITHIN THE PROPERTY BOUNDARY, AS CLOSE TO THE WATER METER AS POSSIBLE, UPSTREAM OF ALL CONNECTIONS ON THE PROPERTY, COORDINATE LOCATION WITH CEOR.
- 2 PRV ASSEMBLY.
- 3 SEE CIVIL SITE UTILITY PLAN FOR CONTINUATION.
- 4 2% MINIMUM SLOPE ON ALL DRAINAGE PIPING.
- 5 ROUTE P&T TO +6" ABOVE FINISHED GRADE WITH 90 DEGREE ELBOW FACING DOWN.
- 6 PROVIDE RECESSED BOX FOR 3/4" HW & 3/4" CW SUPPLIES AND IW FROM WASHER.
- 7 WATER SOFTENER, BY OTHERS. PROVIDE LINE SIZE BYPASS SOV. WATER TREATMENT EQUIPMENT SHALL BE SIZED TO ACCOMMODATE 64 GPM PEAK FLOW WITH NO MORE THAN 15 PSI PRESSURE LOSS.
- 8 OFFSET VENT AS REQUIRED TO MAINTAIN 10 FT MINIMUM SEPARATION FROM OUTSIDE AIR INTAKES.
- 9 WHA WITH ACCESS.
- 10 CONNECT TRAP PRIMER TO THE TOP OF THE CW SUPPLY OF A FREQUENTLY USED FIXTURE, AT LEAST 6" ABOVE THE FINISHED FLOOR, AND WITH ACCESS. ROUTE THE GRAVITY OUTLET TO THE TAILPIECE OF THE FD, PER MFR'S INSTRUCTIONS.
- 11 ROUTE INDIRECT WASTE FROM EQUIPMENT IN MECHANICAL ROOM TO FLOOR SINK.
- 12 PROVIDE INLINE INTERCEPTOR ON THE WASHING MACHINE DRAIN WITH REMOVABLE WIRE BASKET STRAINER TO PREVENT THE PASSAGE OF SOLIDS 1/2" OR LARGER FROM DISCHARGING TO THE PUBLIC SEWER SYSTEM.
- 13 ROUTE PIPING TO AVOID CONFLICTS WITH THE STRUCTURE. STRUCTURAL MODIFICATIONS SHALL REQUIRE THE APPROVAL OF ARCHITECT AND SEOR.
- 14 PROTECT THE INTEGRITY OF FIRE RATED ASSEMBLIES WITH UL LISTED FIRE STOP COMPATIBLE WITH THE PIPING MATERIALS AND CONSTRUCTION.
- 15 PROVIDE SEISMIC STRAPPING FOR WATER HEATER TANK PER CPC 507.2. QUICK STRAP #QS-120 BY HOLDITE OR EQUAL.

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Ojai, CA 93023


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DATE:		07/24/2025

ENLARGED  
PLUMBING  
FLOOR PLAN

P2.3

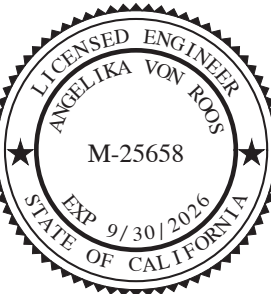DESIGN DEVELOPMENT - NOT FOR CONSTRUCTION



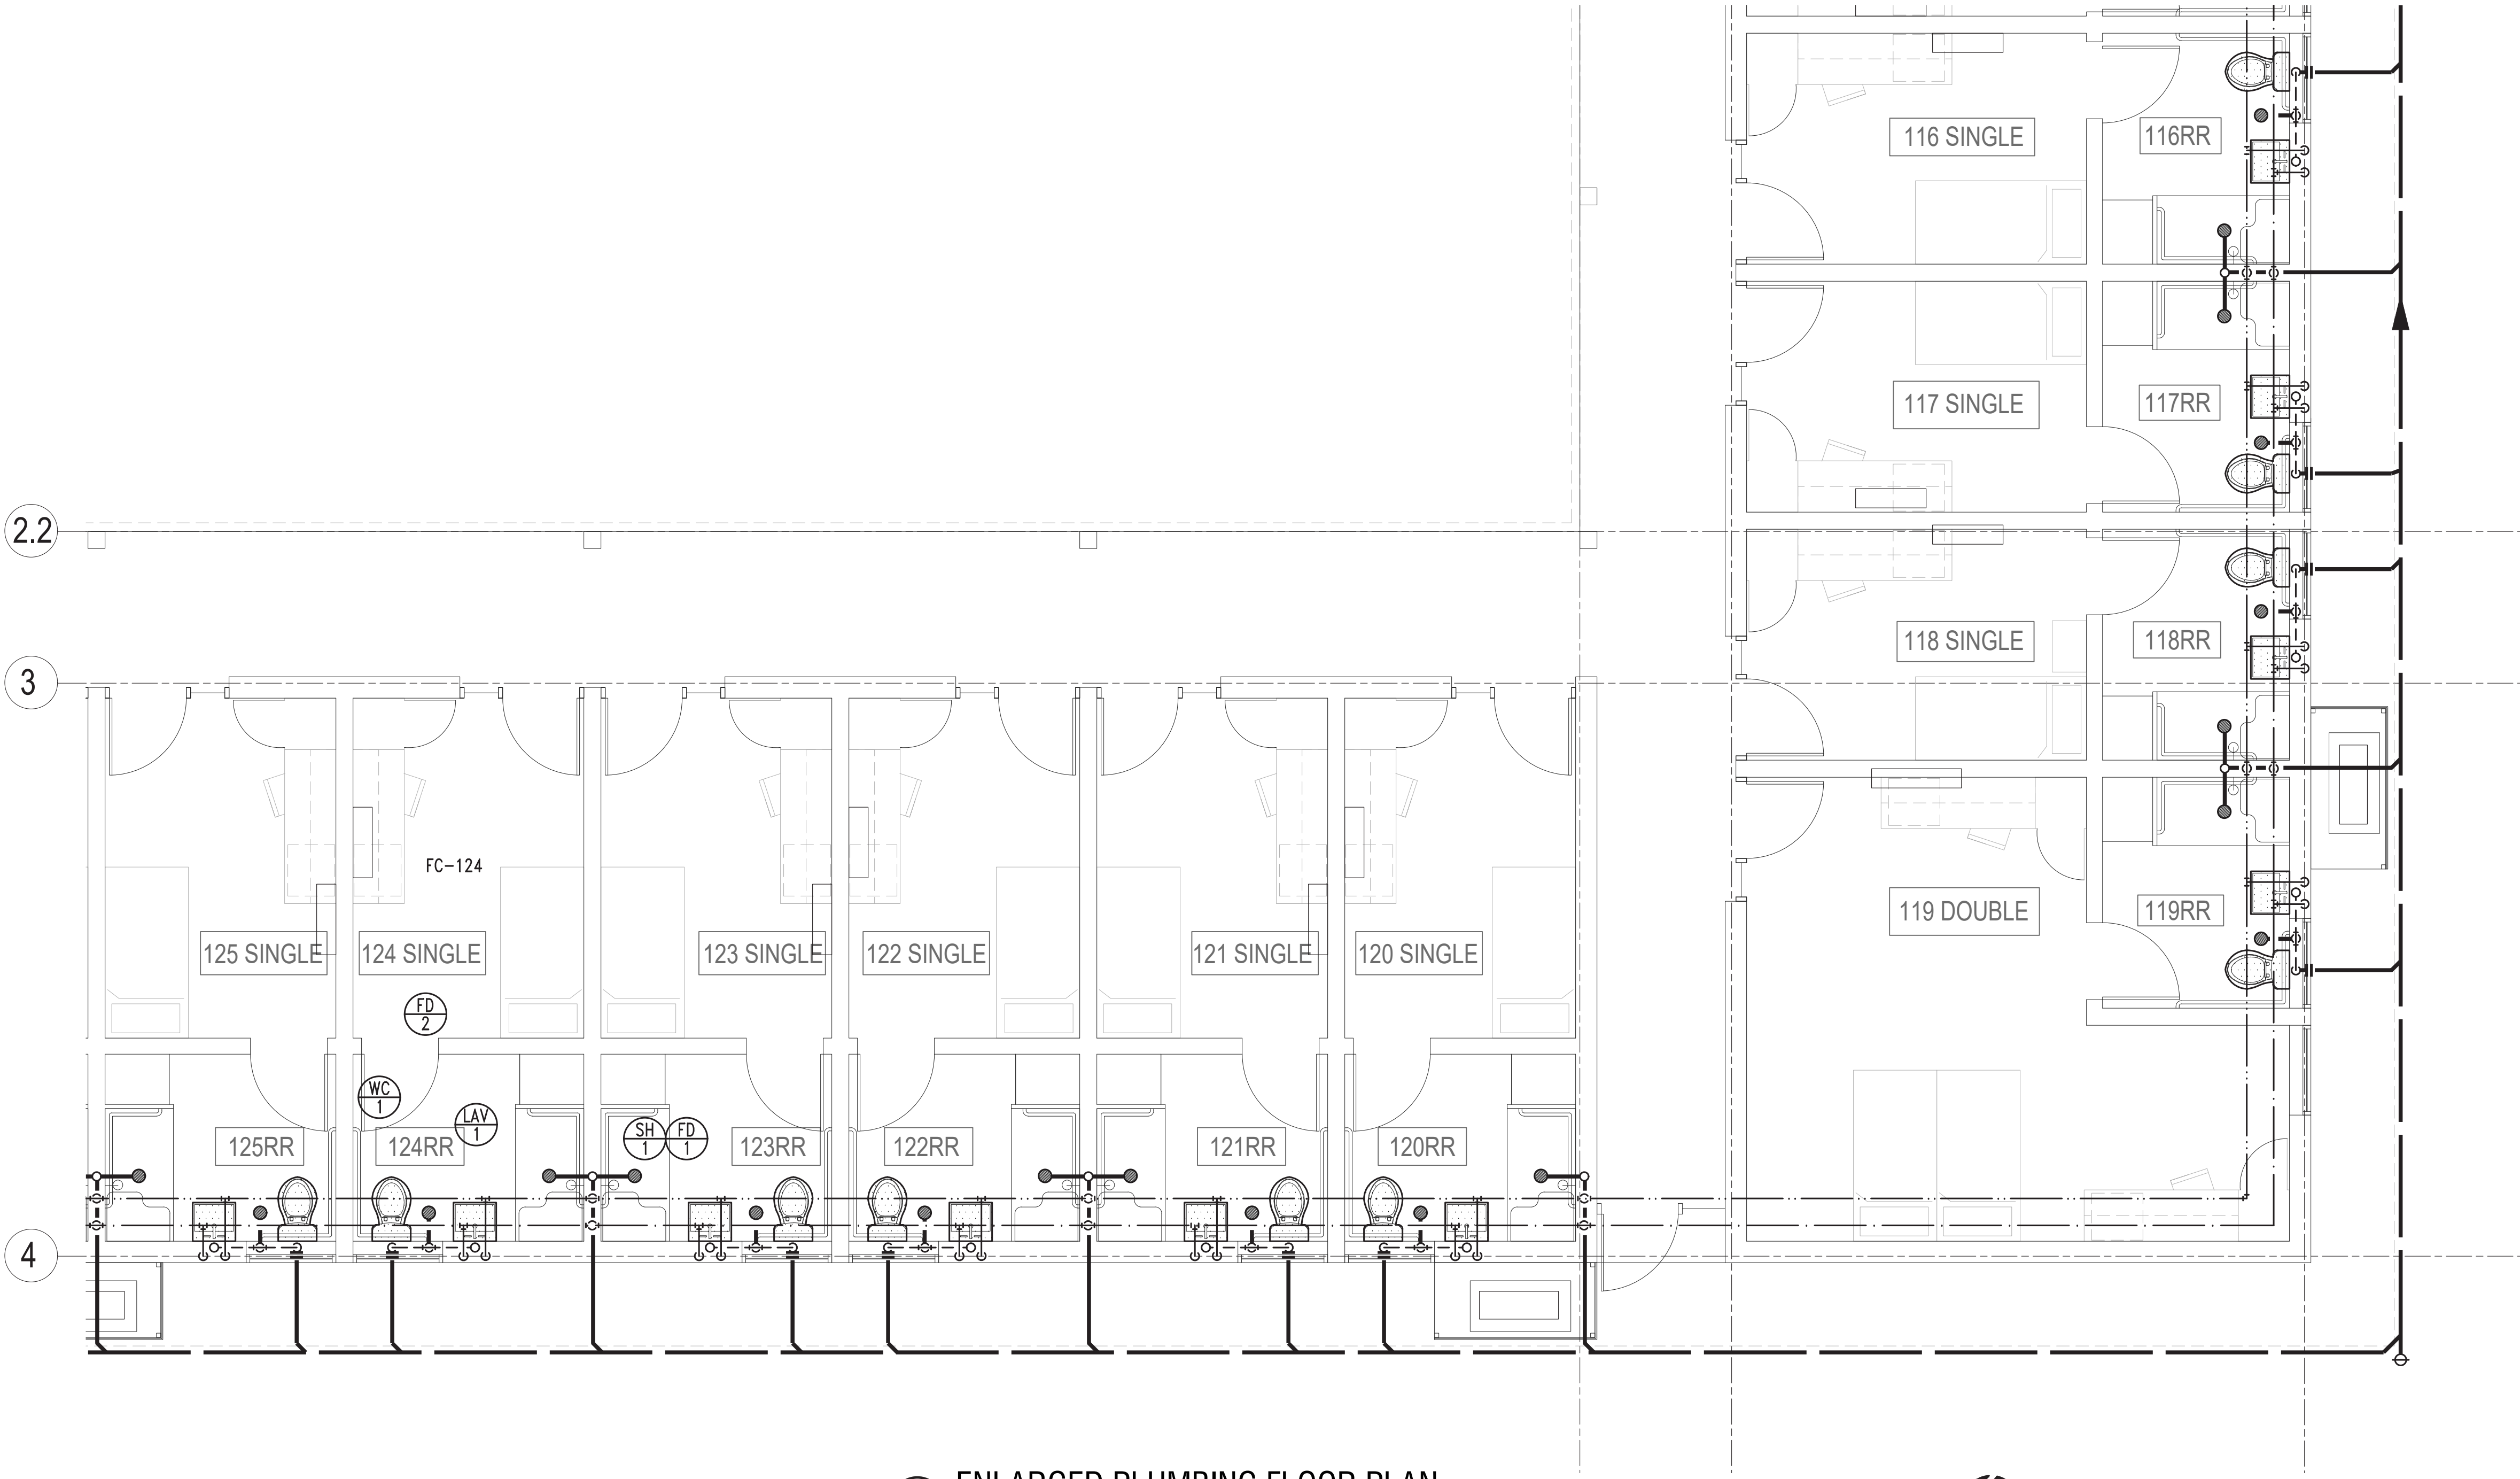

1 ENLARGED PLUMBING FLOOR PLAN

1/4" = 1'-0"



KEYNOTES

- 1 2% MINIMUM SLOPE ON ALL DRAINAGE PIPING.
- 2 ROUTE 3/4" PRIMARY CONDENSATE DRAIN TO SINK TAILPIECE.
- 3 OFFSET VENT AS REQUIRED TO MAINTAIN 10 FT MINIMUM SEPARATION FROM OUTSIDE AIR INTAKES.
- 4 WHA WITH ACCESS.
- 5 ROUTE PIPING TO AVOID CONFLICTS WITH THE STRUCTURE. STRUCTURAL MODIFICATIONS SHALL REQUIRE THE APPROVAL OF ARCHITECT AND SEOR.
- 6 PROTECT THE INTEGRITY OF FIRE RATED ASSEMBLIES WITH UL LISTED FIRE STOP COMPATIBLE WITH THE PIPING MATERIALS AND CONSTRUCTION.

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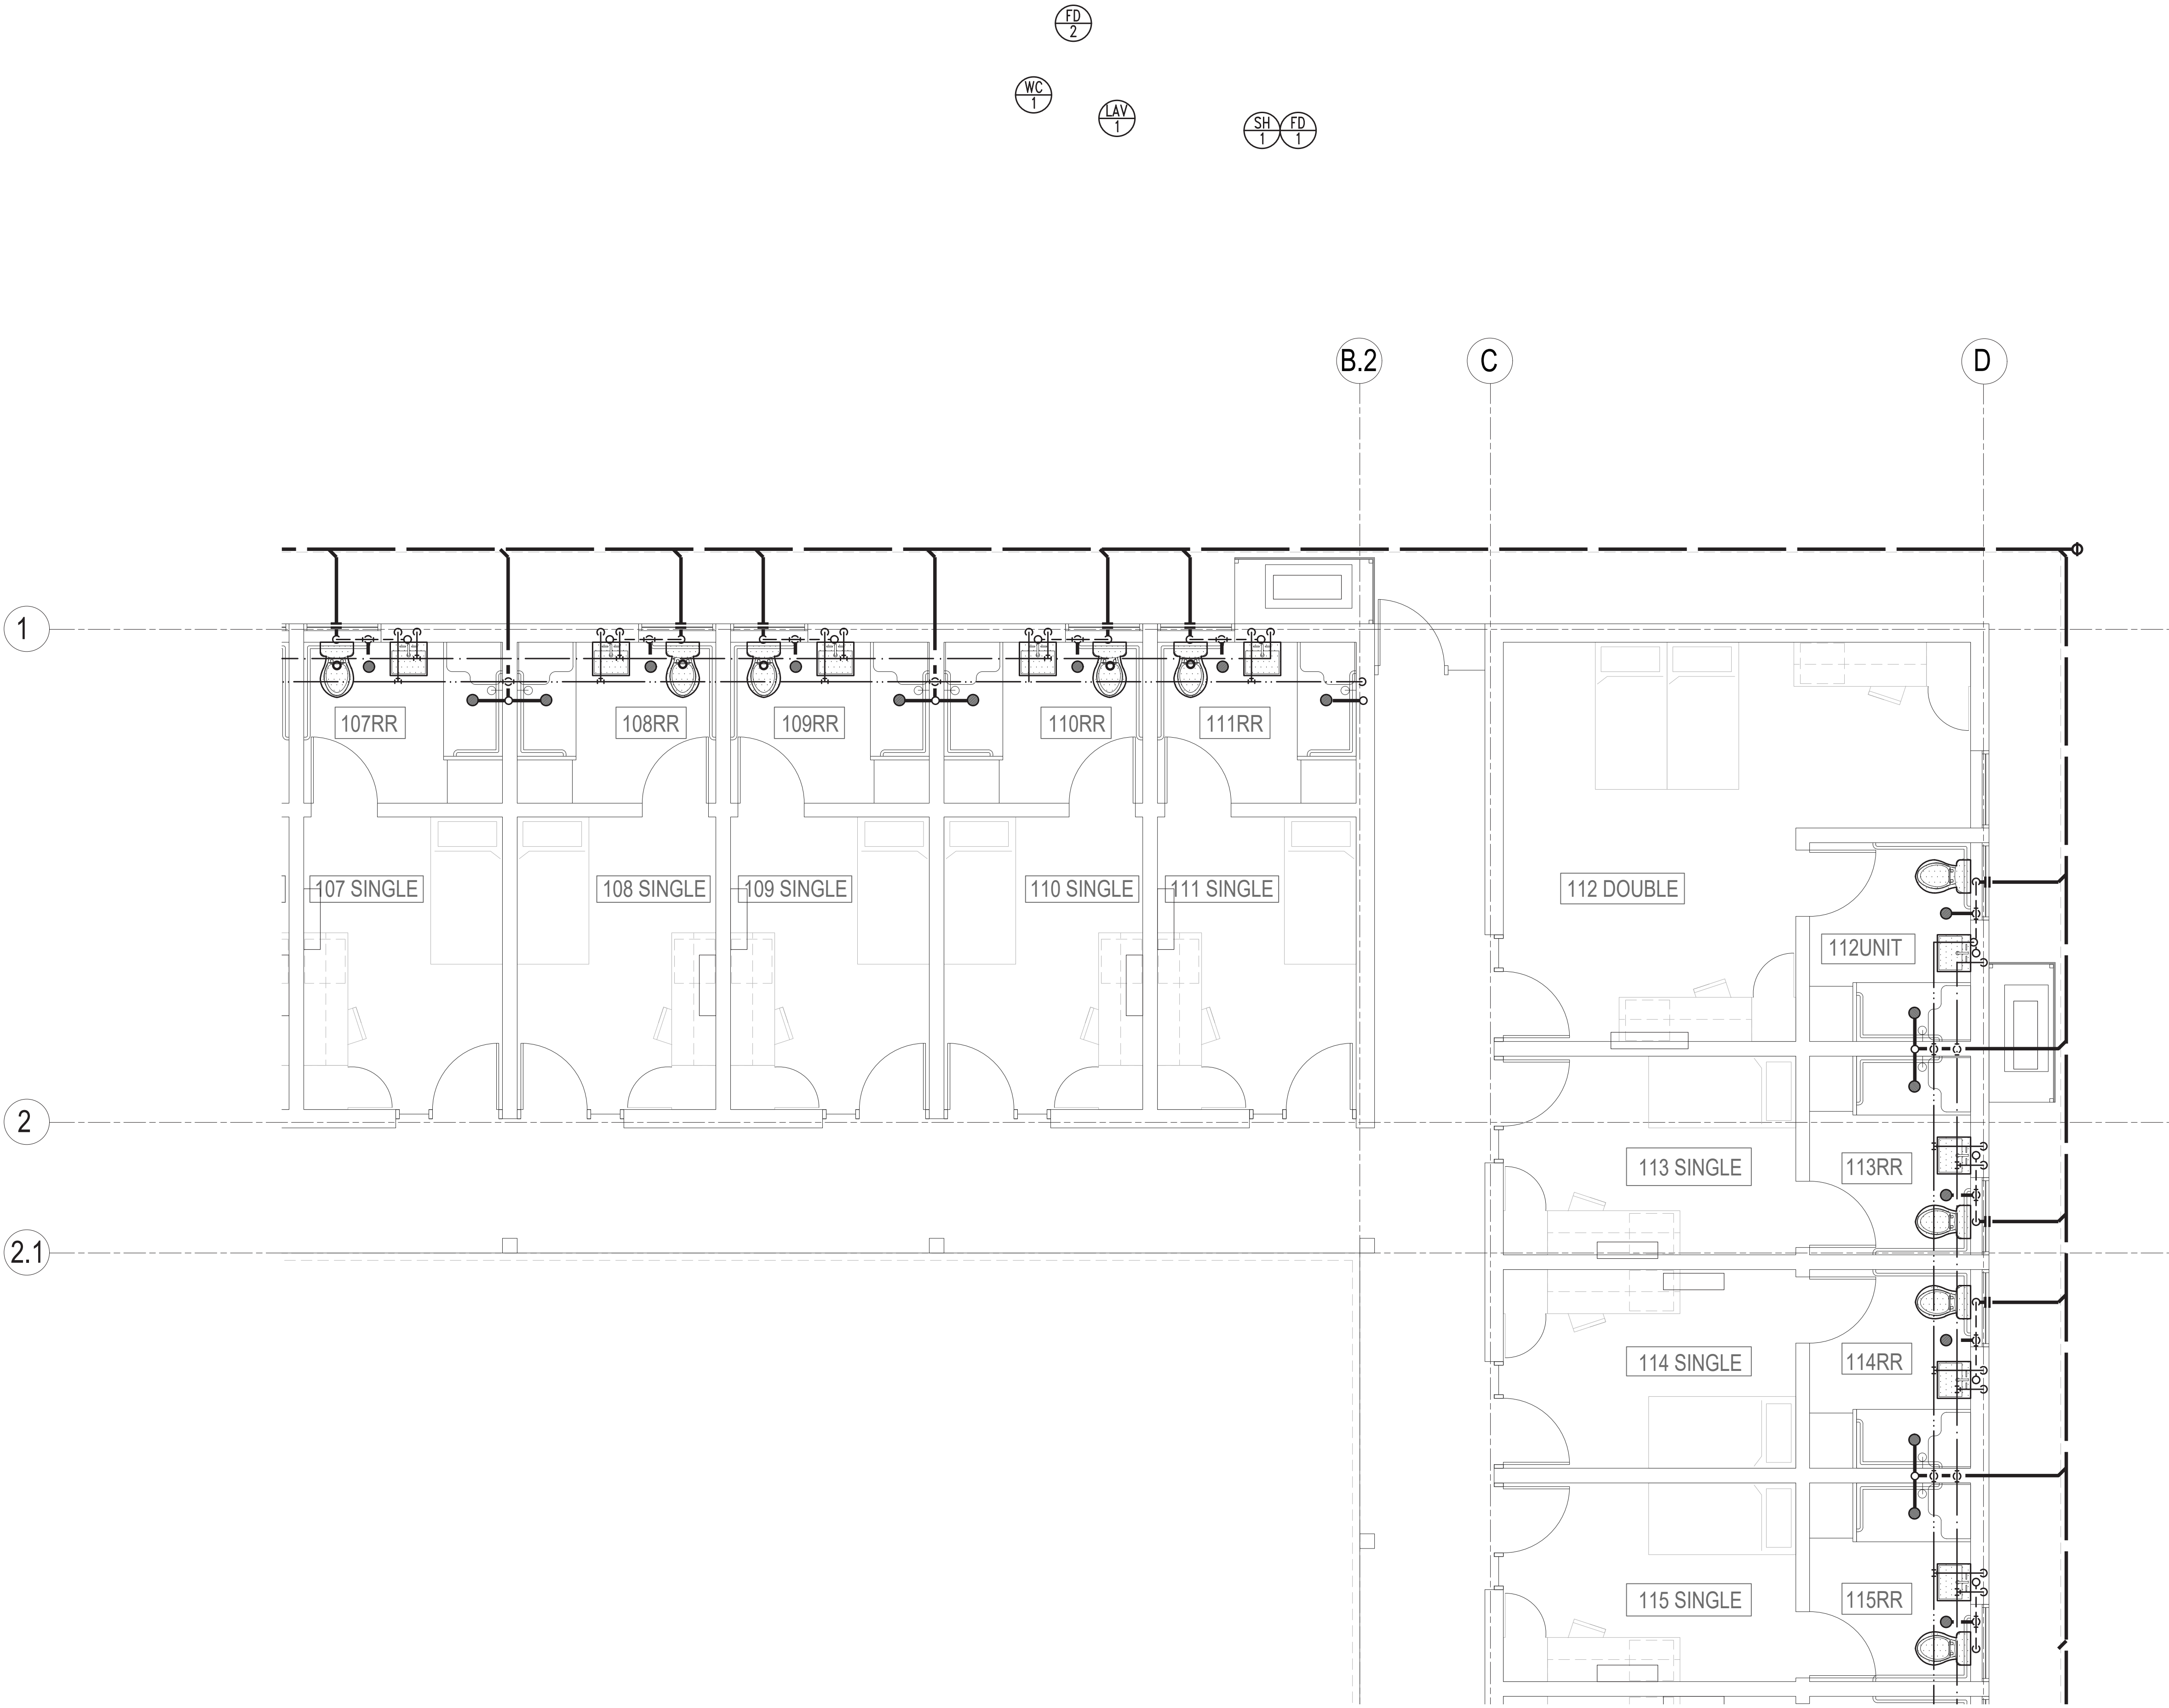
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SUPPORTIVE HOUSING  
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DATE:		07/24/2025

ENLARGED  
PLUMBING  
FLOOR PLANS

P2.4






1 ENLARGED PLUMBING FLOOR PLAN

1/4" = 1'-0" N

KEYNOTES

- 1 2% MINIMUM SLOPE ON ALL DRAINAGE PIPING.
- 2 ROUTE 3/4" PRIMARY CONDENSATE DRAIN TO SINK TAILPIECE.
- 3 OFFSET VENT AS REQUIRED TO MAINTAIN 10 FT MINIMUM SEPARATION FROM OUTSIDE AIR INTAKES.
- 4 WHA WITH ACCESS.
- 5 ROUTE PIPING TO AVOID CONFLICTS WITH THE STRUCTURE. STRUCTURAL MODIFICATIONS SHALL REQUIRE THE APPROVAL OF ARCHITECT AND SEOR.
- 6 PROTECT THE INTEGRITY OF FIRE RATED ASSEMBLIES WITH UL LISTED FIRE STOP COMPATIBLE WITH THE PIPING MATERIALS AND CONSTRUCTION.

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SUPPORTIVE HOUSING
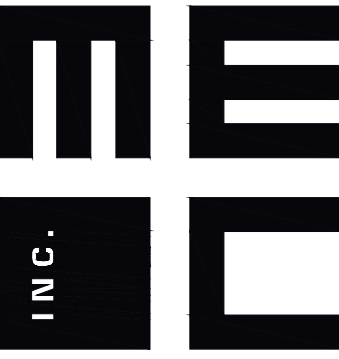
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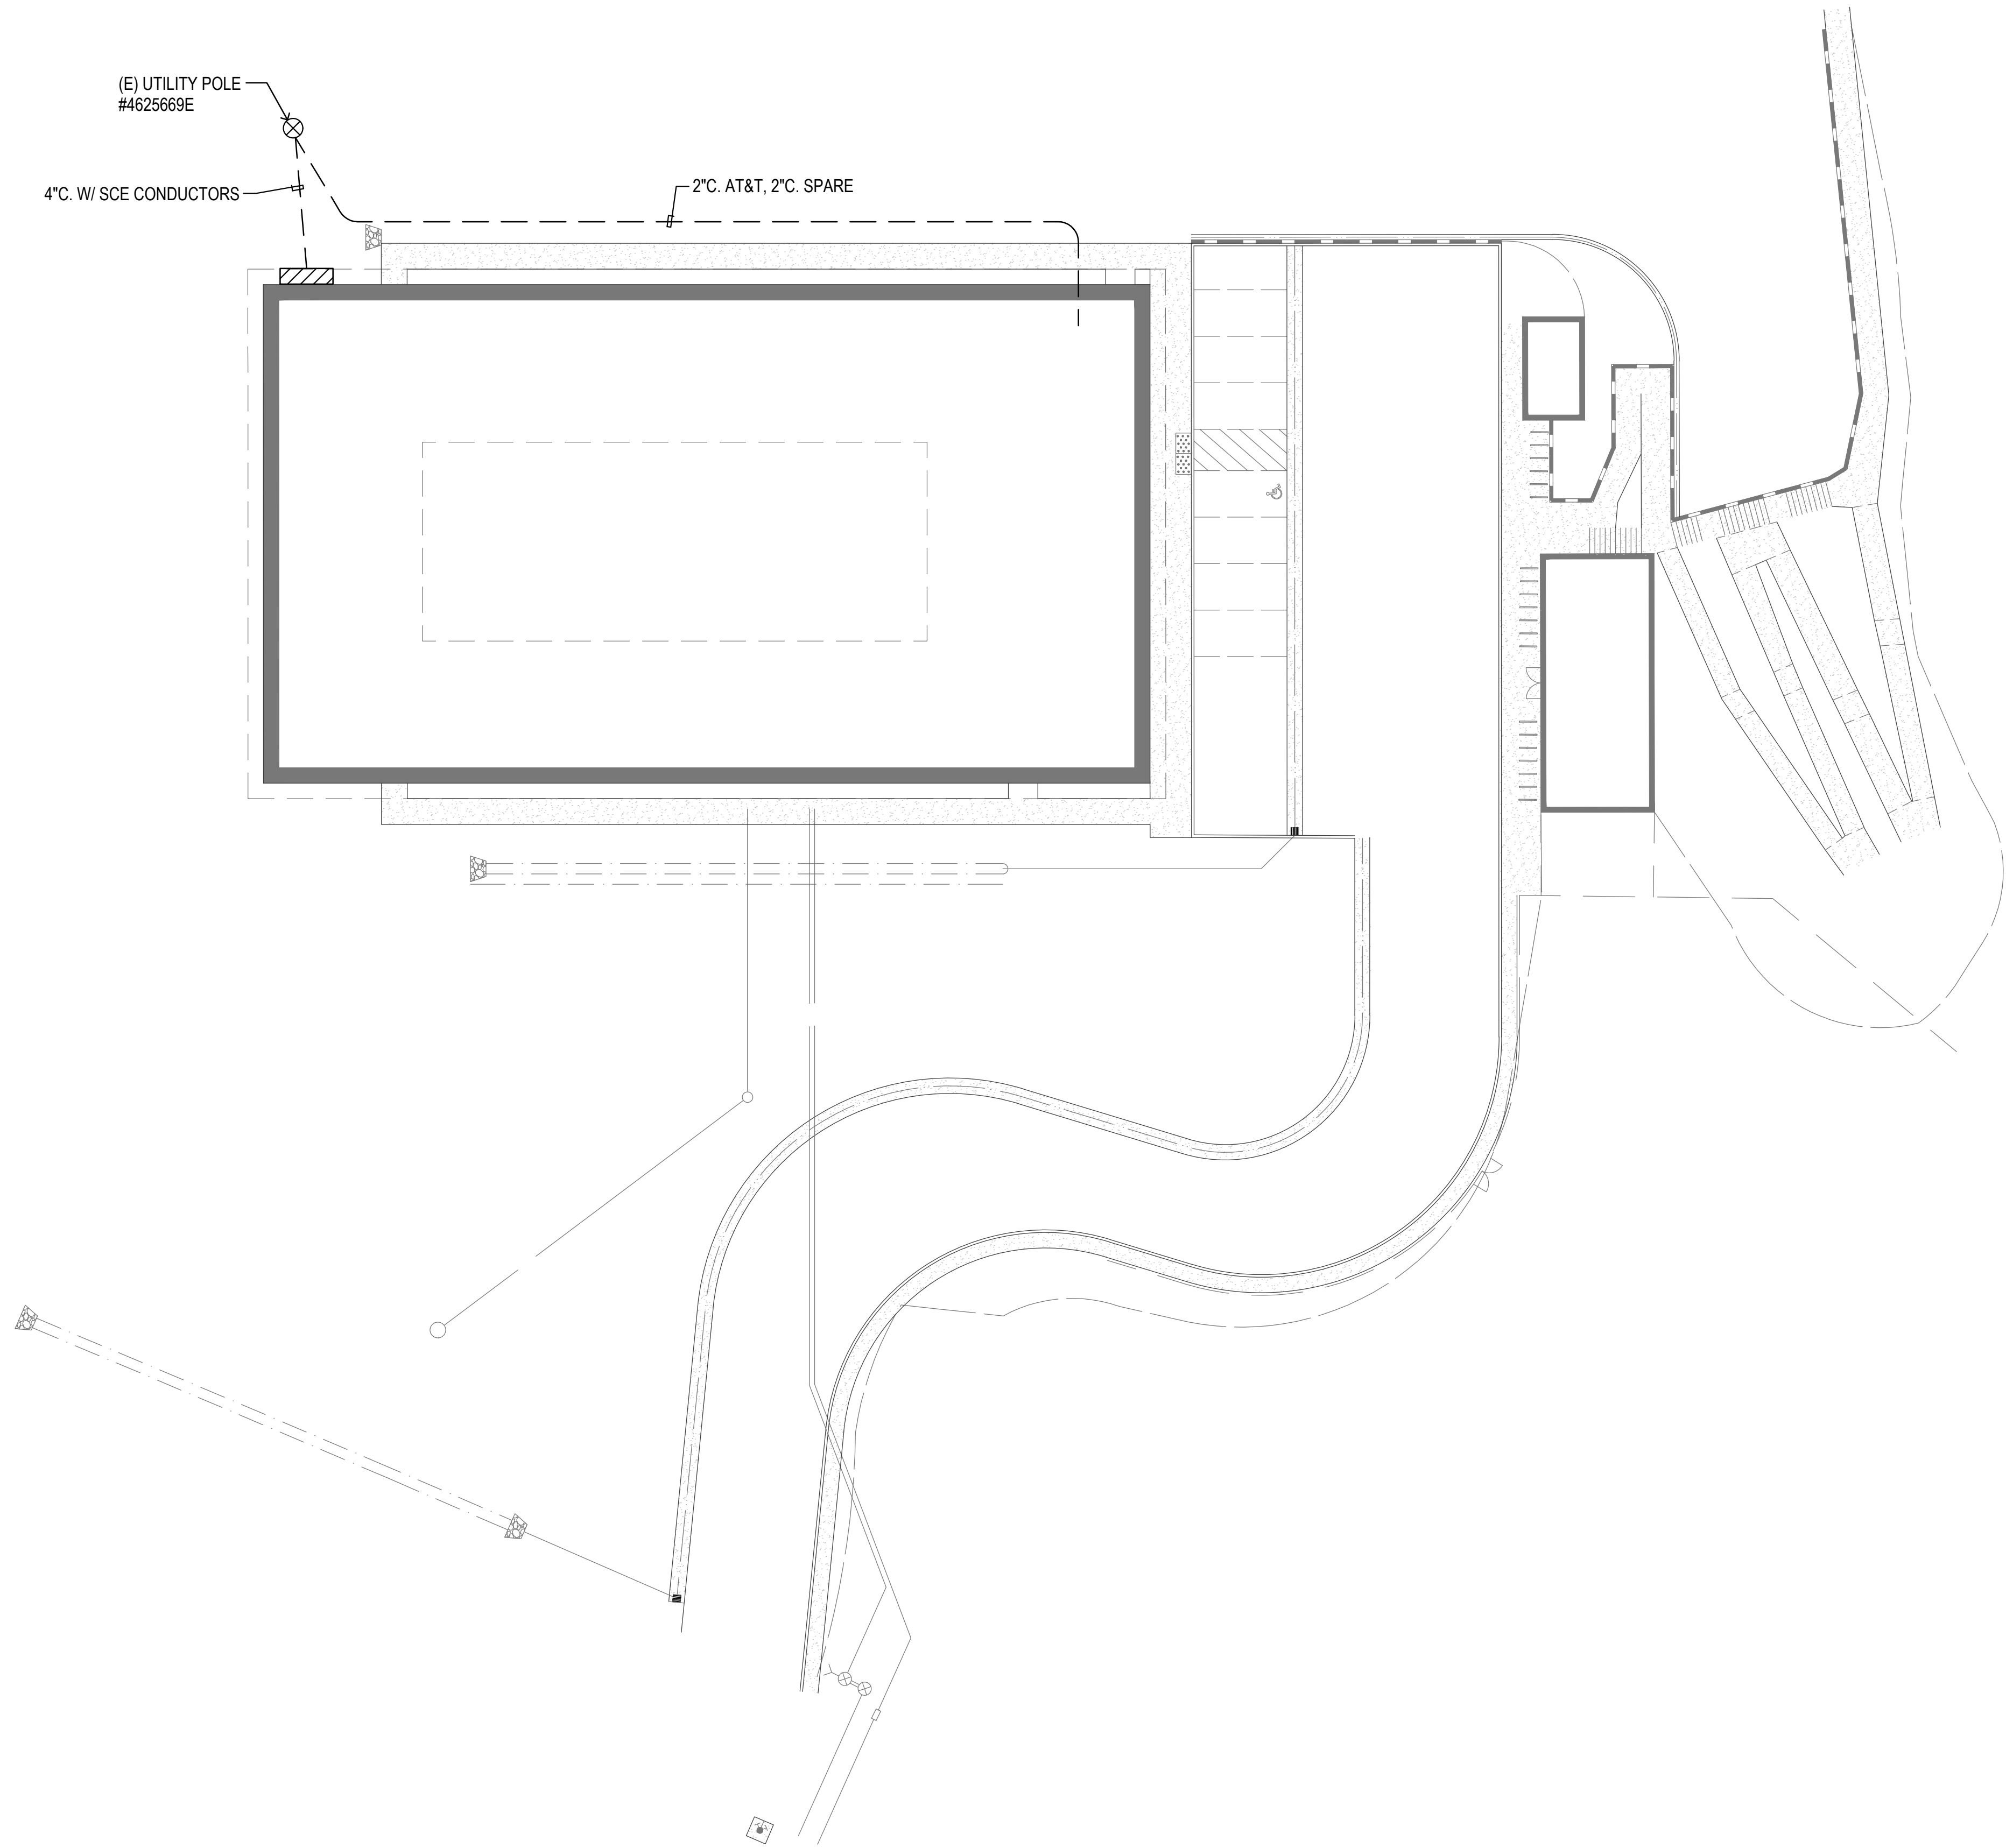
ENLARGED  
PLUMBING  
FLOOR PLANS

P2.5










ELECTRICAL SITE PLAN

SCALE: 1"=20'-0"

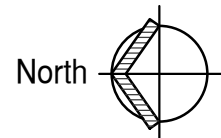

**JMPE**  
ELECTRICAL ENGINEERING  
LIGHTING DESIGN  
CA REGISTRATION NO. E11083

146 EAST CARRILLO STREET  
SANTA BARBARA CA 93101  
(805) 569-3518  
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25326



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Santa Barbara, CA 93103  
206.459.7027 dylan@djaarchitects.com

Ojai Permanent Supportive Housing

611 South Montgomery Street, Ojai California

Drawn By: DJ  
Checked By: 2407  
Job No.

Revisions:

No.	Date	By

NOT FOR CONSTRUCTION

25 July 2025

Design  
Development

ELECTRICAL  
SITE PLAN  
E-2



611 South Montgomery Street, Ojai California

Revisions:


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Design  
Development


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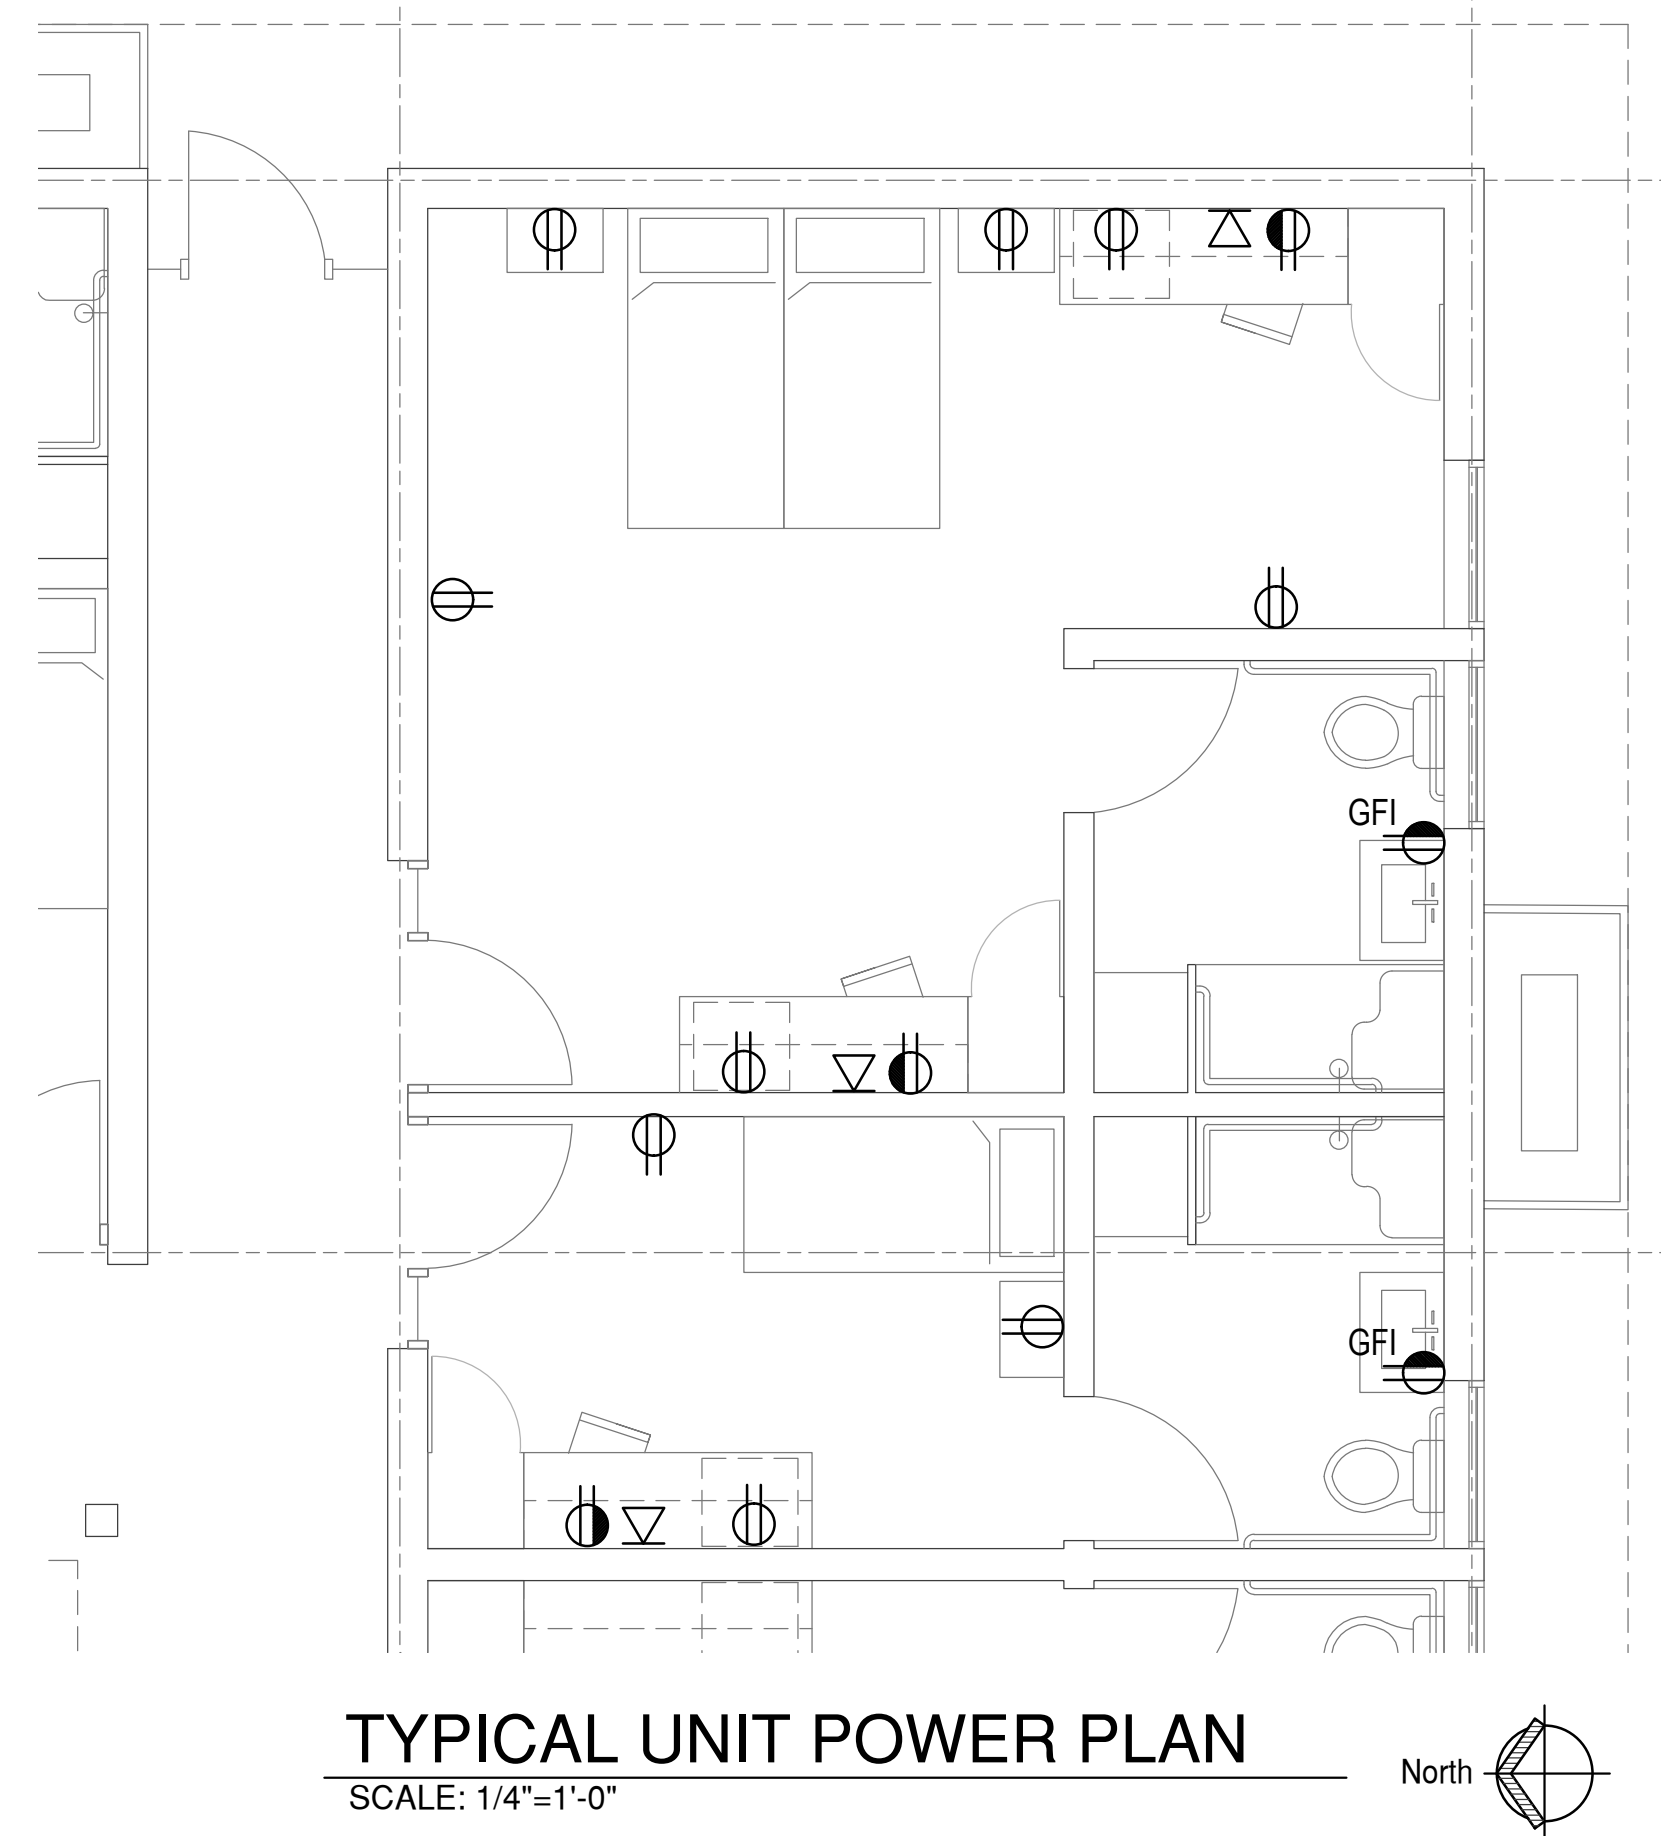




LIGHTING PLAN  
SCALE: 3/16"=1'-0"

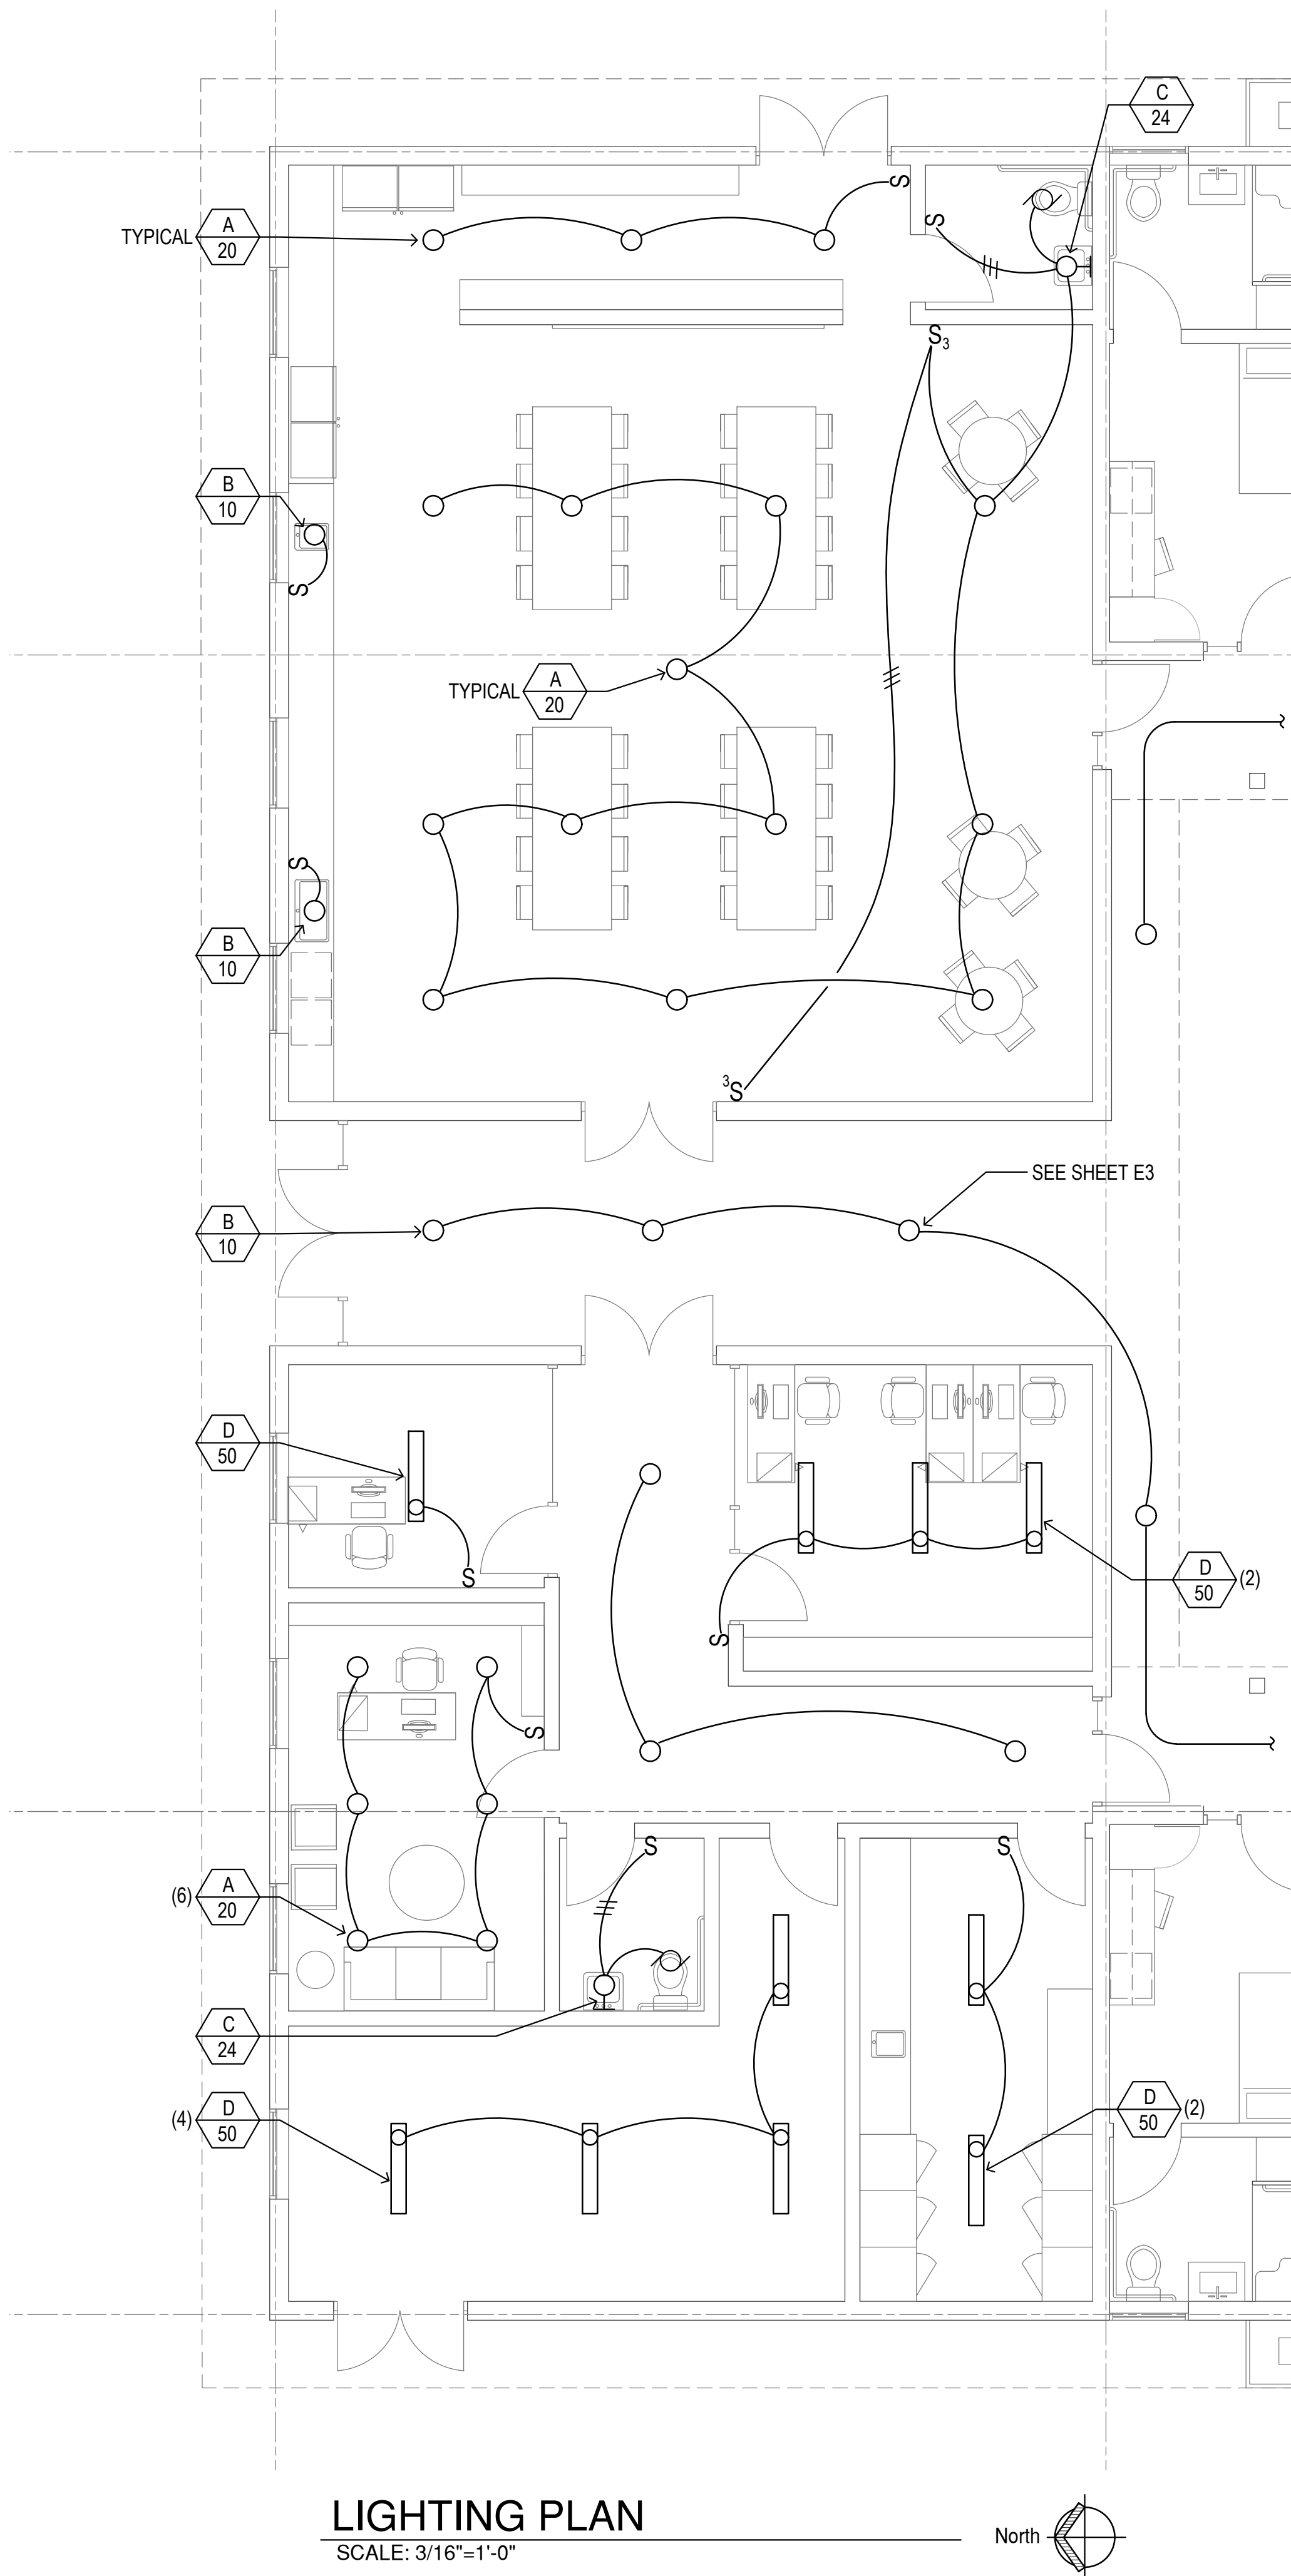

TYPICAL UNIT LIGHTING PLAN  
SCALE: 1/4"=1'-0"

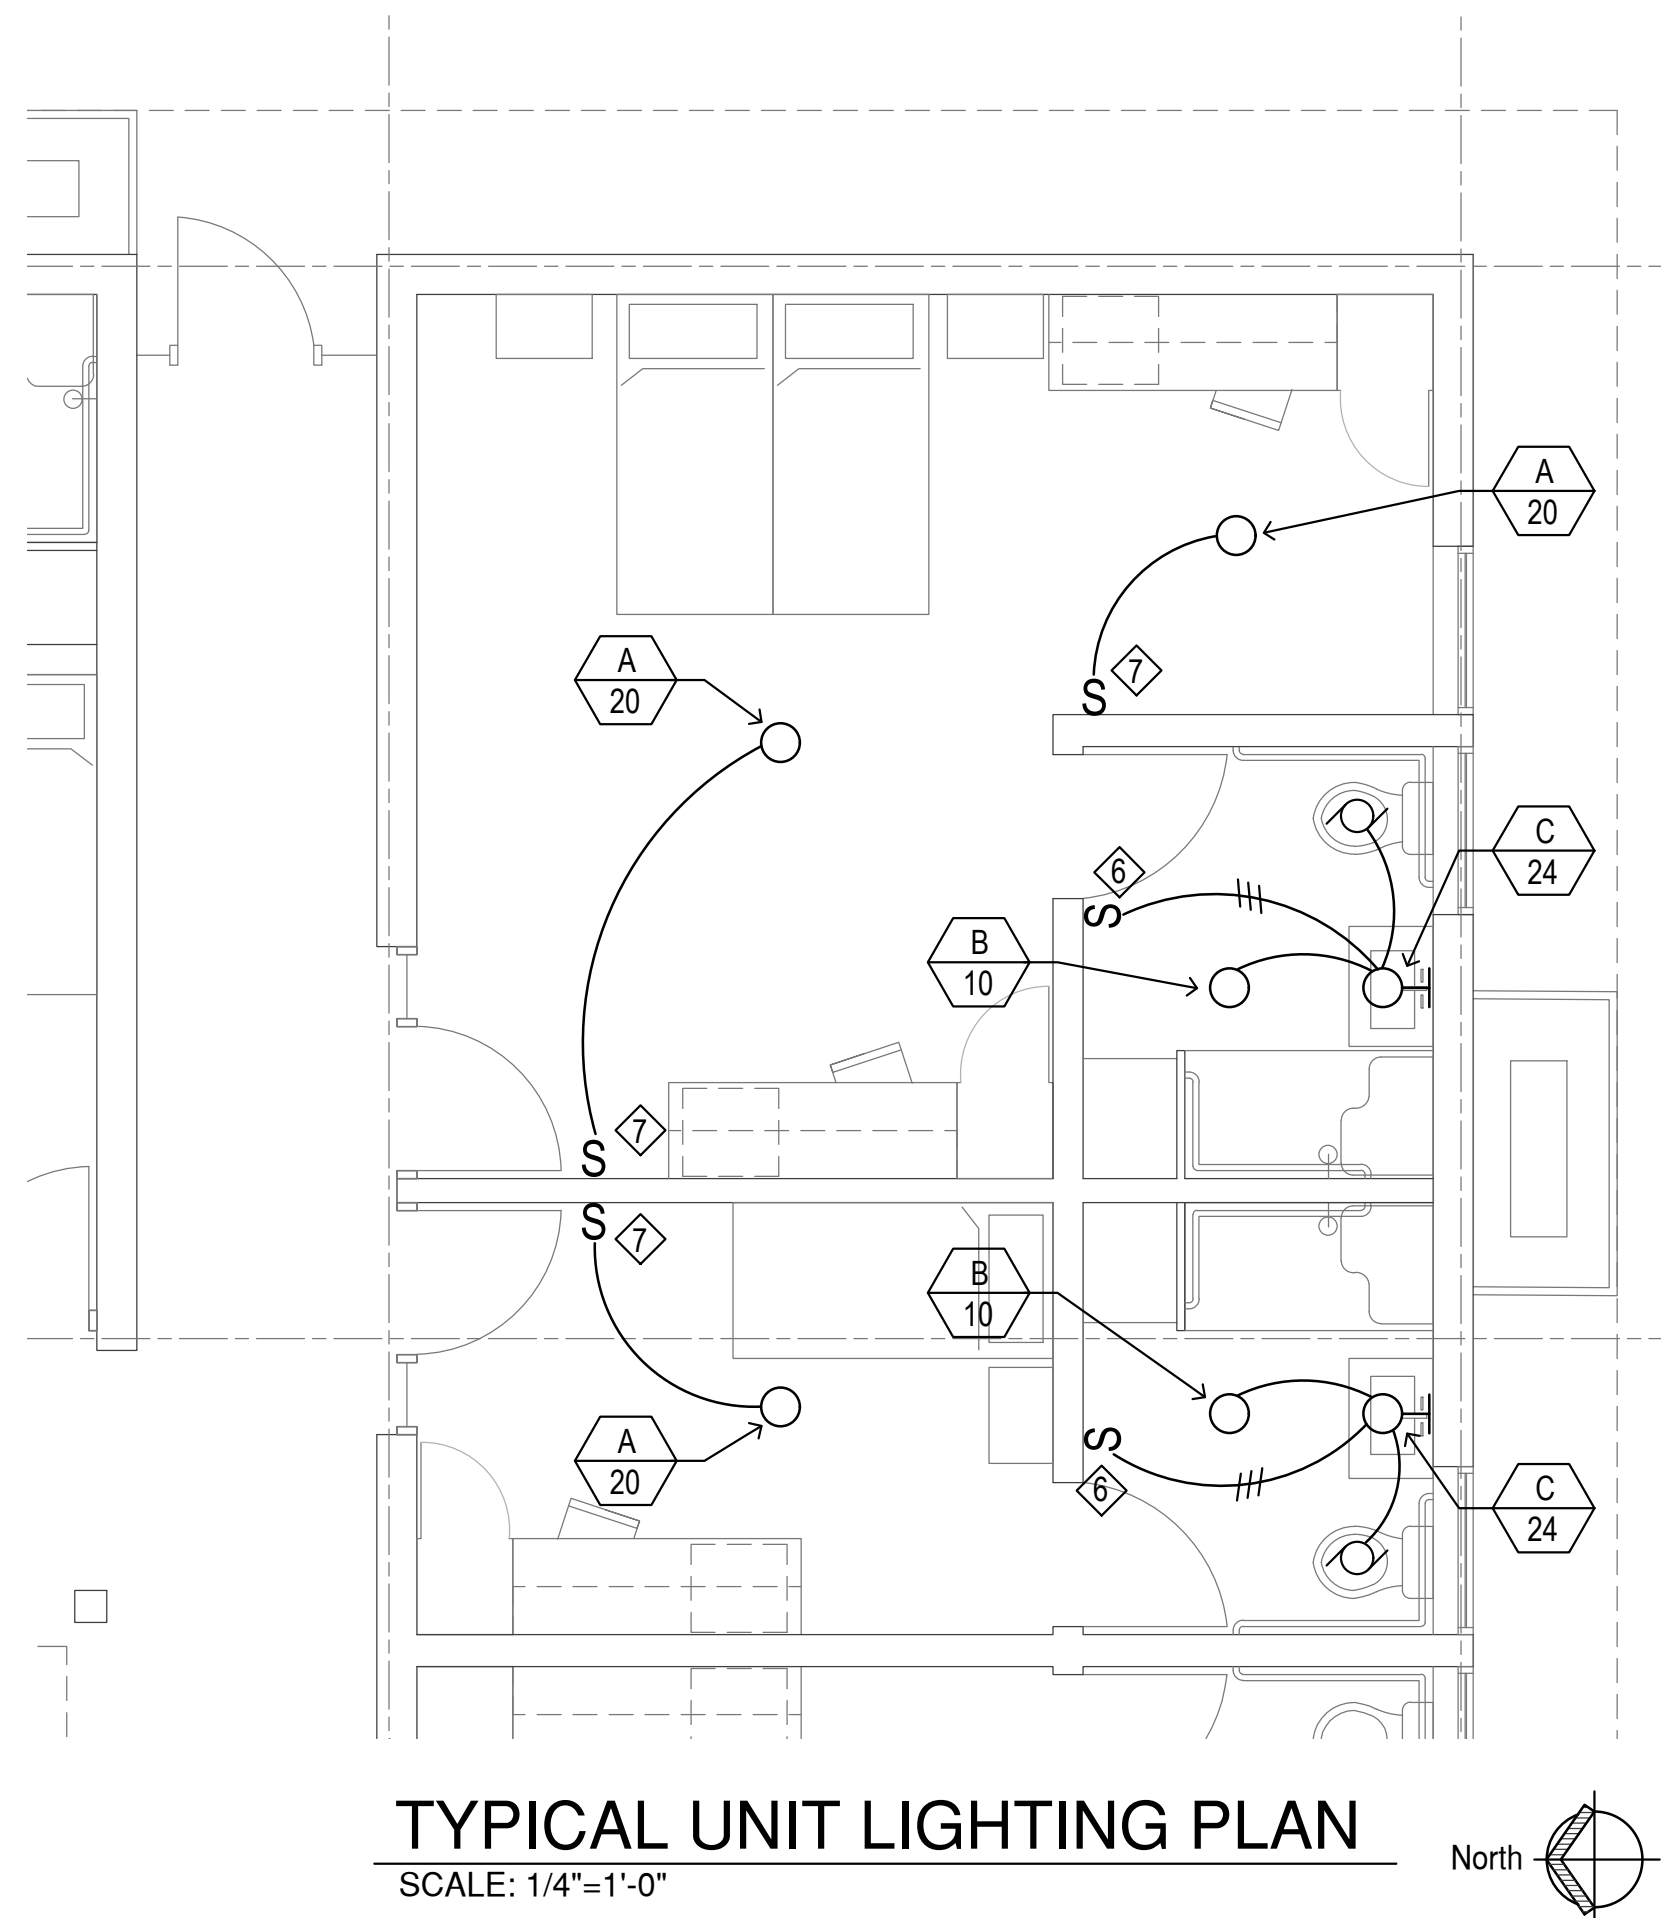

TYPICAL UNIT POWER PLAN  
SCALE: 1/4"=1'-0"


#### LIGHTING NOTES

1. ALL INSTALLED LIGHTING TO BE HIGH EFFICACY PER REQUIREMENTS OF 2022 CEC SECTION 150.0(k) AND JOINT APPENDIX JA8.
2. BUILDER SHALL PROVIDE THE HOMEOWNER WITH A LUMINAIRE SCHEDULE THAT INCLUDES A LIST OF ALL INSTALLED LAMPS AND LUMINAIRES.
3. ANY JA8 COMPLIANT LAMP MUST BE CONTROLLED BY A VACANCY SENSOR OR DIMMER BASED ON TYPE OF LUMINAIRE OR LAMP INSTALLED.
4. RECESSED FIXTURES SHALL BE IC RATED AND ASTM E283 CERTIFIED. RECESSED FIXTURES SHALL NOT CONTAIN A SCREW BASE SOCKET AND MUST BE INSTALLED WITH A LIGHT SOURCE THAT IS JA8 CERTIFIED, SHALL NOT CONTAIN LIGHT SOURCES THAT ARE LABELED "NOT FOR USE IN ENCLOSED FIXTURES" OR "NOT FOR USE IN RECESSED FIXTURES."
5. IN BATHROOMS, LAUNDRY ROOMS, GARAGES, AND UTILITY ROOMS, AT LEAST ONE LUMINAIRE SHALL BE CONTROLLED BY A VACANCY SENSOR.

6 SENSOR SWITCH #WSX-PDT-2P-FAN-WH

7 DIMMER

REFER TO A6.1 AND A6.2  
REFLECTED CEILING PLANS  
FOR LIGHTING AND FAN  
LAYOUTS. PROVIDE  
PRICING BASED ON  
ARCHITECTURAL PLANS.

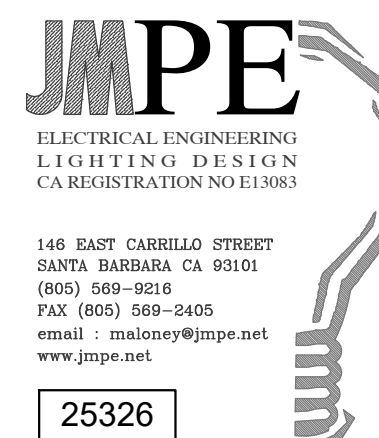

DJA Architects, PLLC  
Dylan Johnson  
Santa Barbara, CA 93103  
206.459.7027 dylan@djaarchitects.com

Ojai Permanent Supportive Housing

611 South Montgomery Street, Ojai California

Drawn By: DJ  
Checked By: 2407  
Job No. 2407  
Revisions:

No.	Date	By

NOT FOR CONSTRUCTION

25 July 2025

Design  
Development

ELECTRICAL  
FLOOR PLANS

E-4